Restroom / Storage Building

OTAY RANCH VILLAGE 8

Chula Vista, CA

CODE COMPLIANCE

APPLICABLE CODES:

2022 CALIFORNIA BUILDING CODE2022 CALIFORNIA PLUMBING CODE

2022 CALIFORNIA PLUMBING CODE
 2022 CALIFORNIA ELECTRICAL CODE

2022 CALIFORNIA GREEN CODE

2022 CALIFORNIA ENERGY CODE
ADA TITLE II (28 CFR PART 35) & 2010 ADAS

APPLICABLE TO STATE & LOCAL GOVERNMENT SERVICES. PROGRAMS & ACTIVITIES

OCCUPANCY & USE:

U (WITH ACCESSIBILITY PROVISIONS FOR RESTROOMS)

TYPE OF CONSTRUCTION:

V-D

FIRE SPRINKLERS:

FIRE SEPARATION DISTANCE:

10' OR GREATER ON ALL SIDES

HEIGHT & STORIES:

NUMBER OF STORIES

BUILDING HEIGHT

12

12'-5" (40'-0" ALLOWED) 1 STORY (1 STORY ALLOWED)

BUILDING AREA: 484 s.f. (5,500 ALLOWED)

CLIMATE ZONE:

PRC JOB NUMBER:

11385A

BUILDING MODEL NUMBER:

PS-033-ST-CUSTOM


NUMBER OF BUILDING MODS:

GENERAL NOTES

- THE STRUCTURAL DESIGN DETAILS HEREIN ARE SPECIFIC TO THE BUILDING SIZE AND MODULE CONFIGURATION SHOWN ON THE FLOOR PLAN OF THESE DRAWINGS.
- LOCATION OF THIS BUILDING SHALL MEET REQUIRED PROPERTY CODE SETBACKS PER LOCAL JURISDICTION.
 ACCESSIBILITY TO THIS STRUCTURE SHALL BE IN CONFORMANCE WITH LOCAL CODE
- INCLUDING ALL PATHWAYS, RAMPS AND PATHS OF TRAVEL FROM PARKING TO THE BUILDING.
 SOIL BEARING REQUIREMENT IS 1500 PSF, SUB GRADE COMPACTION AT 90%. SITE BUILDING PAD PREPARATION BY OTHERS.
- ALL DIMENSIONS HEREIN ARE NOMINAL AND SUBJECT TO CHANGE AS LONG AS THEY DO NOT VIOLATE CODE.
- THIS BUILDING IS NOT DESIGNED TO BE HEATED OR COOLED FOR OCCUPANT COMFORT AND DOES NOT CONFORM WITH TITLE 24 MINIMUM INSULATION REQUIREMENTS.
- THIS BUILDING IS NOT DESIGNED TO BE LOCATED IN A WUI (WILDLAND URBAN INTERFACE) FIRE AREA.
- ALL WORK REQUIRED TO BE COMPLETED ON SITE SUBJECT TO LOCAL REVIEW, APPROVAL AND INSPECTION BY LOCAL AHJ. OWNER / GENERAL CONTRACTOR RESPONSIBLE FOR ALL INSPECTIONS.
- a. SITE CONCRETE FOUNDATION (IF APPLICABLE)
- b. COMPACTED BUILDING PAD
- c. UNDER SLAB UTILITY PIPING (SEE NOTE)
- d. ELECTRICAL CONNECTION
- e. WATER SUPPLY CONNECTIONf. SEWER (DWV) CONNECTION
- g. CONCRETE WALKWAY COMPLIANT WITH PATH OF TRAVEL FROM ACCESSIBLE PARKING NOTE: PUBLIC RESTROOM COMPANY WILL ONLY FURNISH AND INSTALL UNDERGROUND UTILITIES (UNDER SLAB) EXTENDING 6 FEET (MAX.) BEYOND THE BUILDING LINE. MIN. OF 24" -
- SITE INSTALLATION DETAILS ARE NOTED ON SHEETS S-1 FOR STRUCTURAL CONNECTIONS, A-2 FOR WEATHERIZATION FINISH, P-1 FOR PLUMBING CONNECTIONS & E-1 FOR ELECTRICAL CONNECTIONS IN ACCORDANCE w/ SECTION 4368.

MAX. OF 36" BELOW GRADE - U.N.O. ALL UTILITY BOXES TO BE PROVIDED BY OTHERS.

- a. SERVICE HOOKUPS (PLUMBING AND ELECTRICAL CONNECTIONS).
- b. PATCH AND FINISH AT CRANE PICK LOCATIONS AS NEEDED.
- c. INSTALL AND CONNECT PLUMBING DRAIN TRAPS ASSEMBLIES
- d. INSTALL ROOFING @ MOD LINE.
- e. INSTALL LIGHT FIXTURE @ MOD LINE
- f. INSTALL MOD LINE CONNECTORS.

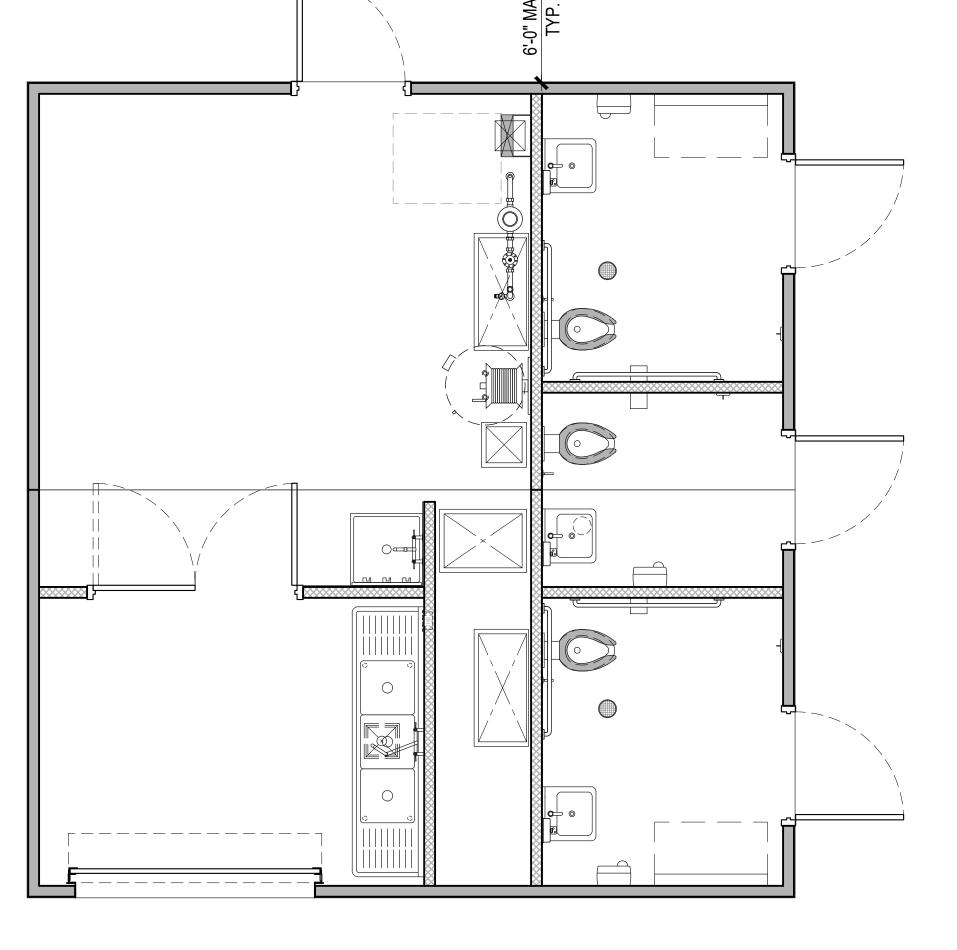

Utility Location

NOTE: FINAL LOCATIONS OF P.O.C. TO BE COORDINATED WITH P.R.C. AND TO BE CONFIRMED ON SITE . UTILITY BOXES TO BE PROVIDED BY OTHERS



PROJECT INFORMATION

SITE ADDRESS: OTAY RANCH VILLAGE 8 - La Media North & Main Street West, Chula Vista, CA 91911

PROJECT OWNER:

EMAIL:

HOMEFED CORPORATION
1903 Wright Place #220
Carlsbad, CA 92008
CONTACT: Don Ross
POSITION: Project Manager
PHONE: (760) 219-1159

dross@hfc-ca.com

kari@trib-la.com

CONSULTANT - LANDSCAPE ARCHITECT:

TRIBUTARY LA, INC.

2725 Jefferson Street - Suite 14

Carlsbad, CA 92008

CONTACT: Kari Kiehnau

PHONE: (608) 513-2903

POSITION: Architect

R & S TAVARES ASSOCIATES
1590 W. Bernardo Court, Suite 100
San Diego, CA 92127
CONTACT: Mariana Cardoso

POSITION: Controller
PHONE: (858) 444 3344
EMAIL: mariana@rstavares.com

DESIGNER / DEALER:
PUBLIC RESTROOM COMPANY
2587 Business Parkway

2587 Business Parkway
Minden, NV 89423
CONTACT: Chad Kaufman
PHONE: (888) 888-2060
FAX: (888) 888-1448

(888) 888-1448 L: chad@publicrestroomcompany.com

DRAWING INDEX

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AC	ACCESSIBILITY COMPLIANCE	•	•		•		
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A-1.1	ROOF FRAMING PLAN, BUILDING SECTIONS & FASTENING SCHEDULE						
A-2	EXTERIOR ELEVATIONS & FINISH SCHEDULE	•	•	•	•		
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E-1	ELECTRICAL PLAN & SCHEDULES		•		•		
S-1	CONCRETE SLAB PLAN & DETAILS		•	•	•		

DESIGN LOADS

GRAVITY			ESIGN CRITERIA ISEISMIC	
GRAVIII	FLOOR LIVE	100 psf	SEISMIC DESIGN CATEGORY	D
	FLOOR DEAD	100 psf	SITE CLASS	D
	ROOF LIVE	20 psf	IMPORTANCE FACTOR	1.0
	ROOF LIVE ROOF DEAD	10 psf	RISK CATEGORY	II.U
	EXTERIOR WALL DEAD	30 psf	MAPPED ACCELERATIONS	11
	EXTENION WALL BEAD	00 psi	S _S	0.771
			S _S S ₁	0.771
SNOW			SPECTRAL RESPONSE	0.219
SINOVV	GROUND SNOW, Pa	0 psf	S _{DS}	0.617
	FLAT-ROOF SNOW, P _f	0 psf	S _{DS} S _{D1}	0.380
	IMPORTANCE FACTOR, Is	1.00	SEISMIC FORCE RESISTING SYSTEM	A7
	EXPOSURE FACTOR, C _e	1.00	DESIGN BASE SHEAR	0.123W
	THERMAL FACTOR, C ₁	1.00	RESPONSE MODIFICATION FACTOR	5.0
	11121 1111 12 17 13 13 1, 34	1.00	ANALYSIS PROCEDURE	ASCE7-16
WIND			AND LIGHT TOOLBONE	7.0027 1.
	ULTIMATE WIND SPEED, Vult	97 mph		
	EXPOSURE CATEGORY	C .	FLOOD	
	RISK CATEGORY	II	BUILDING SHALL NOT BE LOCATED, IN WH	
	INTERNAL PRESSURE, Gcpi	+/- 0.18	PART, IN A FLOOD HAZARD AREA AS ESTA	
	MEAN ROOF HEIGHT	15 Ft	BY THE AUTHORITY HAVING JURISDICTION	
	MEAN TOOL HEIGHT	1011	SET ON A FOUNDATION DESIGNED IN ACC	CORDANCE
			WITH ASCE/SEI 25. THE FLOOD RESISTAN	
	BUILDING SHALL NOT BE PLA	CED ON THE	FOUNDATION SHALL BE DESIGNED BY A FINE DESIGN PROFESSIONAL AND CONSTRUCT	_
	UPPER HALF OF A HILL OR ES		RESIST ALL FLOOD LOADS WITHOUT TRAI	
	EXCEEDING 15 FEET IN HEIGH	HT	LOADS TO THE MODULAR STRUCTURE.	=:

COMPONENTS & CLADDING WIND LOADS								
END ZONE INTERIOR ZONE								
COMPONENT	(psf)	(psf)						
WINDOWS & SIDING	+25.1 / -25.1	+20.4 / -20.4						
DOORS	+25.1 / -25.1	+20.4 / -20.4						
ROOF CLADDING	+43.2 / -43.2	+32.7 / -32.7						
ROOF OVERHANGS	+58.8 / -58.8	+43.2 / -43.2						

APPROVED
BY RADCO a CA
Department of Housing
And Community
Development approved
third party design
approval agency
DM920272
Approval Date Expiration Date
5/17/2023 8/31/2024
APPROVAL NO.
591-1254

STRUCTURAL ONLY
This certification is for structural design only. All other matters of cod



DO NOT SCALE - DIMENSIONS PRESIDE 24x36 SHEET = SCALE AS NOTED 11x17 SHEET = NTS

No. Description Date

CONSTRUCTION DOCUMENTS 05/16/2023

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PUBLIC RESTROOM COMPANY

Building Better Places To Go.

2587 Business Pkwy, Minden, NV 89423

Ph: 888-888-2060 Fax: 888-888-1448

PROJECT OWNER:

HOMEFED CORPORATION

Carlsbad, CA

OTAY RANCH VILLAGE 8 Chula Vista, CA

PROJECT NAME AND LOCATION:

TITLE SHEET

SHEET TITLE:


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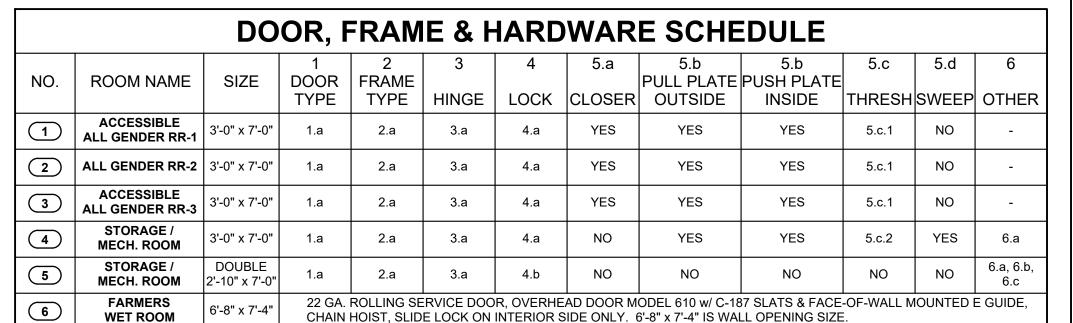
Checked by: JC / KM

Current Date: 05/16/2023

Start Date: 02/22/2023

T-1



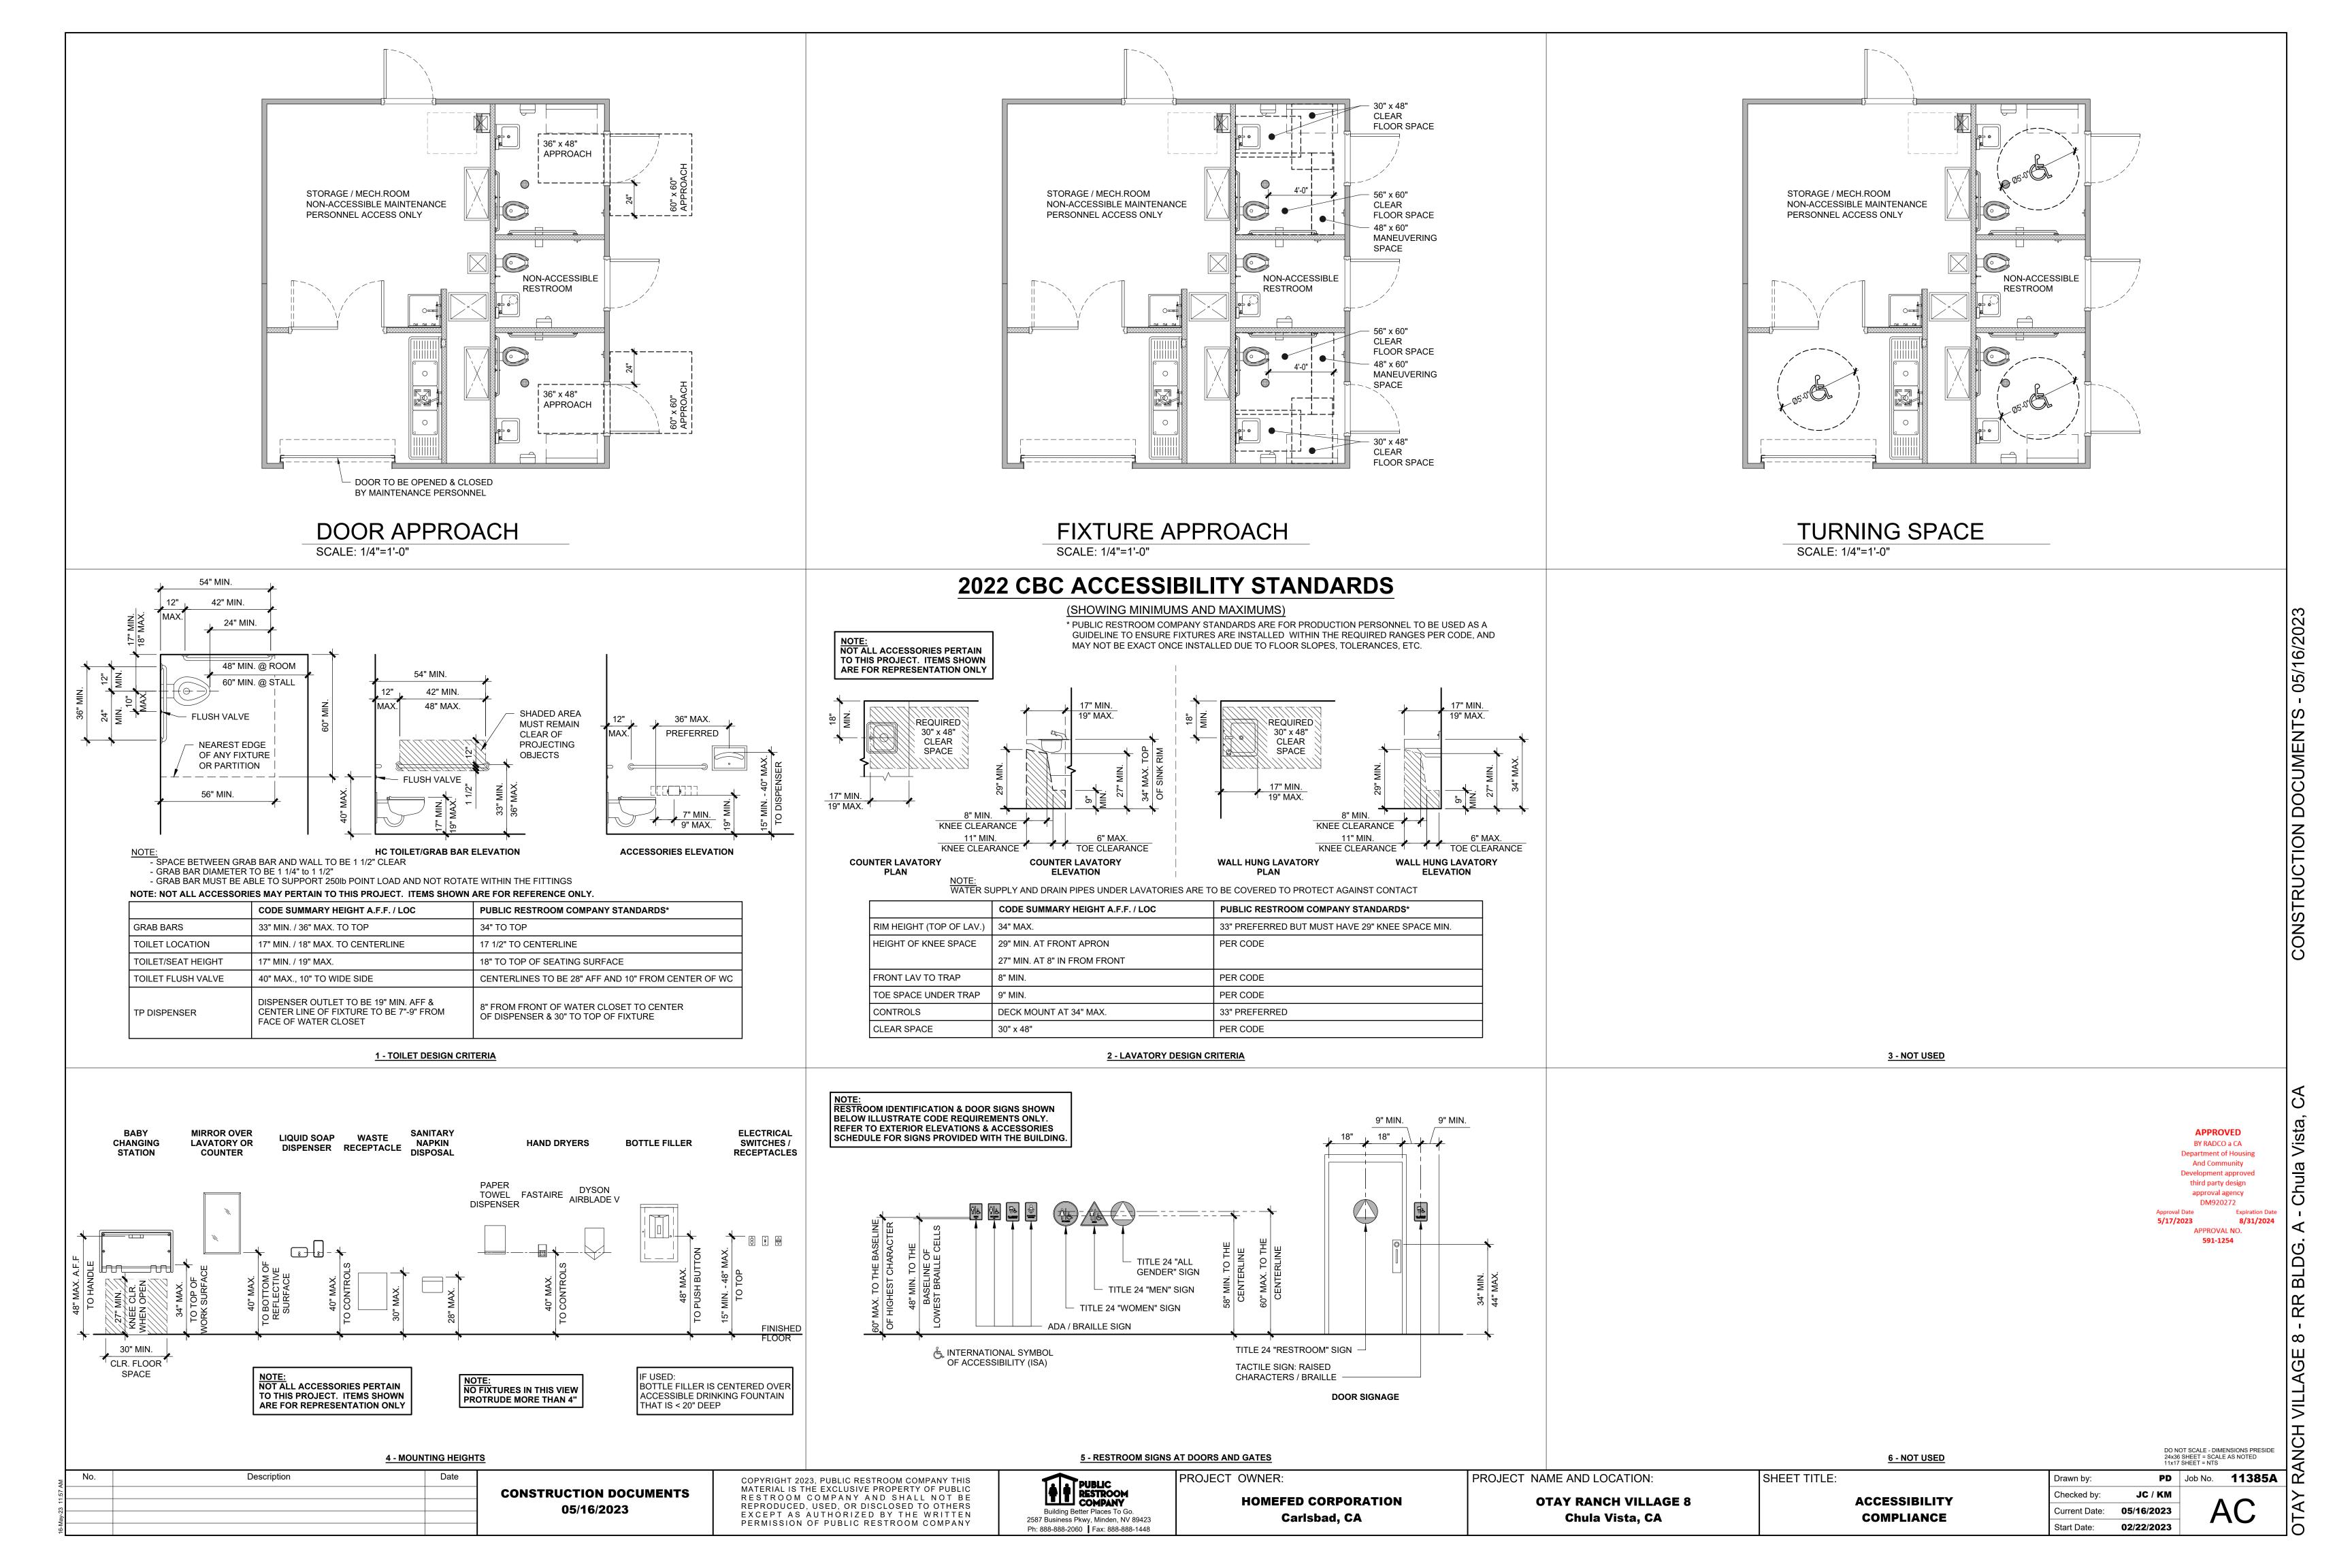

SPECS:

1. DOOR TYPES:

a) 14 GA. GALVANIZED HOLLOW METAL

2. DOOR FRAMES:

a) 4 3/4" WIDE 14 GA. GALVANIZED HOLLOW METAL (WELDED) 3. HINGE:

a) PEMKO KCFM-83" HD (OR EQ.) CONTINUOUS GEAR HINGE WITH STAINLESS STEEL VANDAL RESISTANT SCREWS.

4. LOCK:

a) DEADBOLT: SCHLAGE B660 626 WITH TEMPORARY CONSTRUCTION FULL SIZE INTERCHANGEABLE CORE (FSIC), ADA THUMB TURN LOCKS AND UNLOCKS

b) LEVER: SCHLAGE ND66PD SPA 626 WITH TEMPORARY CONSTRUCTION FULL SIZE INTERCHANGEABLE CORE (FSIC), KEYED BOTH SIDES LOCKS AND UNLOCKS


5. HARDWARE:

a) CLOSER: LCN 4211 (CUSH ARM) b) PUSH / PULL PLATES: ROCKWOOD VRT24C x 91CFC US32DMS WITH BLACK COOL COATING HANDLE

c) THRESHOLD: 1) PEMKO 229A (OR EQ.) 2) PEMKO 270A (OR EQ.)

d) SWEEP: PEMKO 321 SSN (OR EQ.) 6. OTHER:

- a) CHECK CHAIN: IVES CS115-25 (OR EQ.) BOTH LEAVES ON DBL. DOORS b) WALL STOP: IVES WS449 626 (OR EQ.) - BOTH LEAVES ON DBL. DOORS
- c) LOCK INACTIVE LEAF WITH FLUSH BOLTS TOP & BOTTOM. ACTIVE LEAF TO RECEIVE LEVER LOCK

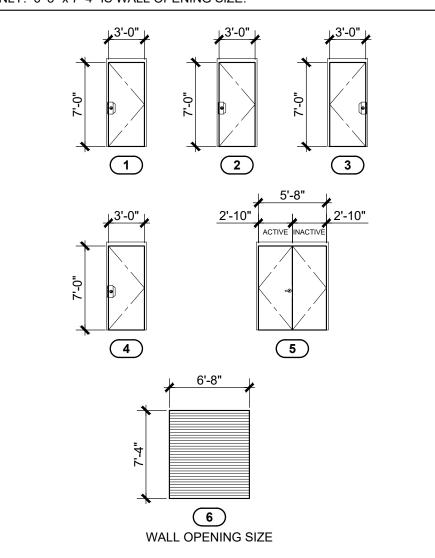

11012.	
DIMENSIONS ARE FOR DOORS	
ONLY, FRAMES ARE NOT INCLUDE	D.

COMPONENT	DESCRIPTION	SPECIFIC MATERIAL LIST	NOTES
SLAB			
PERIMETER FRAMEWORK	STRUCTURAL STEEL	L 6"x6"x5/16"	
REINFORCEMENT	REBAR MAT DESIGN	#4 MIN. GRADE 60 TOP: 8" O.C. EACH WAY - BOT: 16" O.C. EACH WAY	
CONCRETE	8" MAT DESIGN	DESIGN BASIS IS MIN. 2500 PSI	NOTE #1
REBAR CONNECTION TO CONCRETE SLAB	STARTER BARS CONNECTION TO CONCRETE SLAB SHALL BE WITH 2 PART EPOXY w/ 5" MIN. EMBED DEPTH	RED HEAD A7+ EPOXY (OR EQUAL)	USE OF ADHESIVE ANCHORAGE SYSTEM BY PROVISIONS OF CODE REPORT ESR-3903 AND MANUFACTURER RECOMMENDATIONS
WALLS			
FRAMING (EXT.)			
TO CAP BEAM	C.M.U. BLOCK	4 x 8 x 16 CONCRETE BLOCK. GROUT EVERY CELL w/ TYPE 'S' FINE GROUT. REINFORCING: HORIZONTAL - (2) 9 GA WIRES @ 8" O.C. (EVERY COURSE) VERTICAL -#3 REBAR @ 8" O.C. (EVERY CELL), EXCEPT USE #4 REBAR @ END OF WALLS, @ EACH SIDE OF OPENINGS, AND @ 10'-0" O.C. MAX.	USE TYPE 'S' FINE GROUT w/ A SLUMP OF 10"-11" FOR A "HIGH LIFT" GROUT POUR GROUT POUR HEIGHT NOT TO EXCEED 12'-8"
CAP BEAM	STEEL	HSS 6 x 4 x 1/8 (A1085 / A 500 Grade B)	
	WOOD	2x3 DF#2 OR BETTER STUDS @ 24" O.C.	
ABOVE CAP BEAM (OPTION)	STEEL	2 1/2" 18 GA. GALV. STEEL STUDS @ 24" O.C. (250S162-43 STUDS, 2501200-43 TRACKS)	
FRAMING (INT.)			
ТО САР ВЕАМ	C.M.U.BLOCK	4 x 8 x 16 CONCRETE BLOCK. GROUT EVERY CELL w/ TYPE 'S' FINE GROUT. REINFORCING: HORIZONTAL - (2) 9 GA WIRES @ 8" O.C. (EVERY COURSE) VERTICAL -#3 REBAR @ 8" O.C. (EVERY CELL), EXCEPT USE #4 REBAR @ END OF WALLS, @ EACH SIDE OF OPENINGS, AND @ 10'-0" O.C. MAX.	USE TYPE 'S' FINE GROUT w/ A SLUMP OF 10"-11" FOR A "HIGH LIFT" GROUT POUF GROUT POUR HEIGHT NOT TO EXCEED 12'-8"
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ABOVE CAP BEAM (OPTION)	STEEL	2 1/2" 18 GA. GALV. STEEL STUDS @ 24" O.C. (250S162-43 STUDS, 2501200-43 TRACKS)	
SHEATHING (ABOVE CAP BEAM)			
ALL FRAMED WALLS	WOOD	7/16" SHEATHING BOTH SIDES	NOTE #2
ROOF			
TRUSSES	STEEL	HSS SIZES PER DETAILS (A1085 / A 500 Grade B)	
PURLINS	STEEL	HSS 4 x 4 x 1/8 (A1085 / A 500 Grade B)	
LOOKOUTS	STEEL	HSS 4 x 4 x 1/8 (A1085 / A 500 Grade B)	
FASCIA	STEEL	HSS 6 x 2 x 1/8 (A1085 / A 500 Grade B)	
ROOFING	METAL	24 GA. STANDING SEAM METAL ROOF PANELS	




GENERAL SHEET NOTES:

1. LOCATION OF ALL PLUMBING & ELECTRICAL COMPONENTS IN THE STORAGE / MECHANICAL ROOM ARE SUBJECT TO CHANGE, FINAL LOCATIONS TBD.

4" C.M.U. - SPLIT FACE 4" C.M.U. - PRECISION

WALL LEGEND:

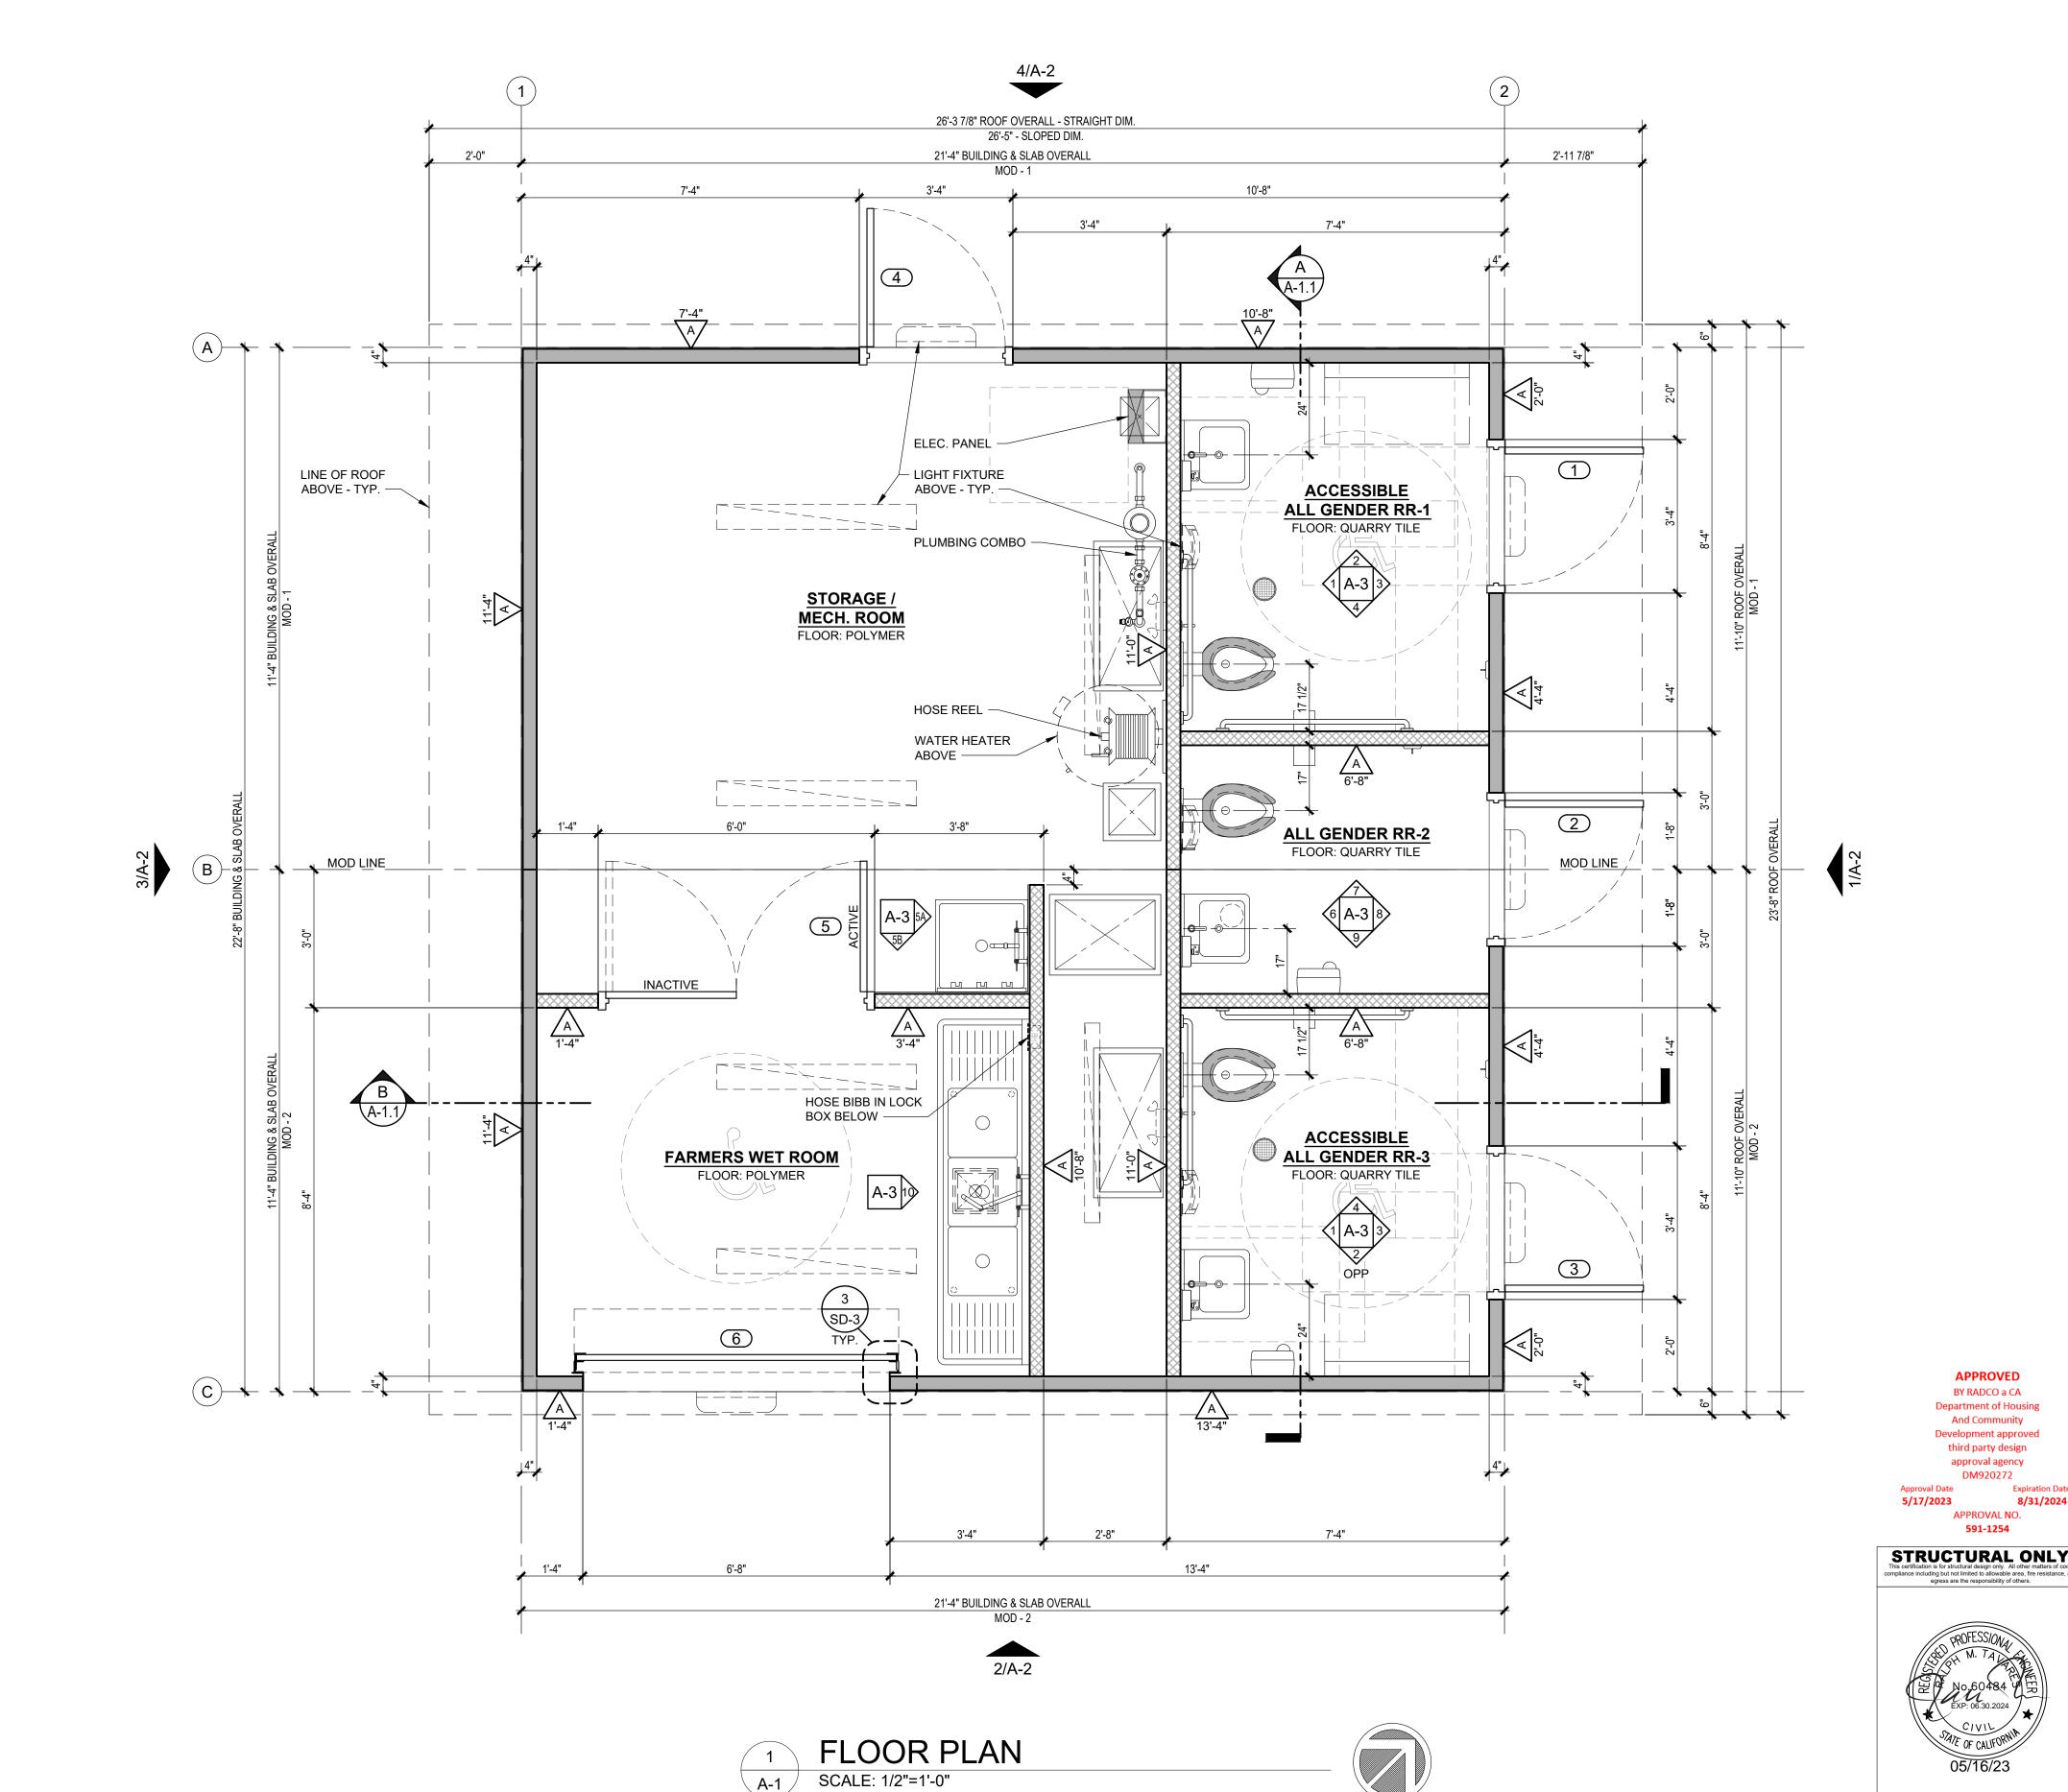

2. PAINT WALL SHEATHING FOR MOISTURE PROTECTION (STORAGE / MECHANICAL ROOM SIDE)

CONSTRUCTION DOCUMENTS 05/16/2023

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PUBLIC RESTROOM COMPANY Building Better Places To Go 2587 Business Pkwy, Minden, NV 89423 Ph: 888-888-2060 | Fax: 888-888-1448

HOMEFED CORPORATION Carlsbad, CA

PROJECT OWNER:

PROJECT NAME AND LOCATION: **OTAY RANCH VILLAGE 8**

Chula Vista, CA

SHEET TITLE: FLOOR PLAN, STRUCTURAL


DESIGN & SCHEDULES


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PD Job No. 11385A

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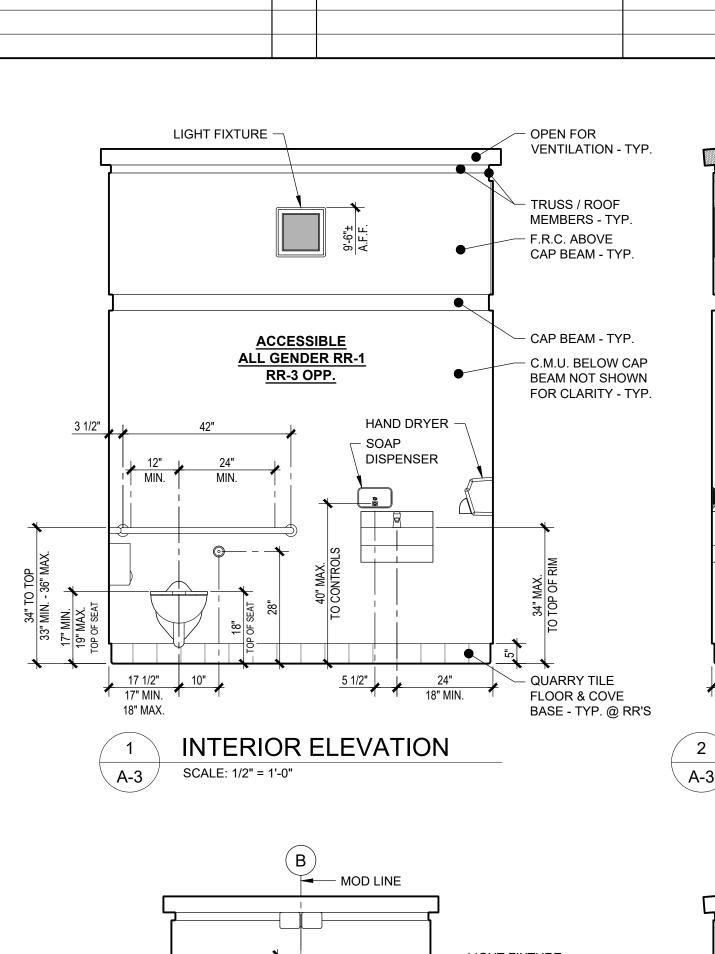
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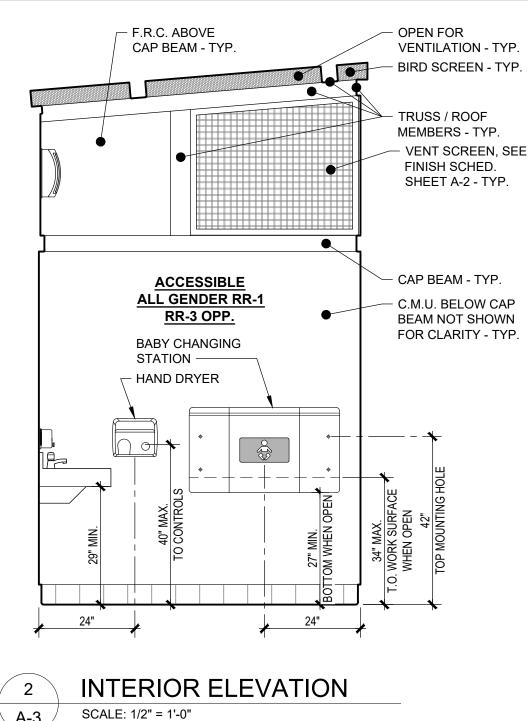





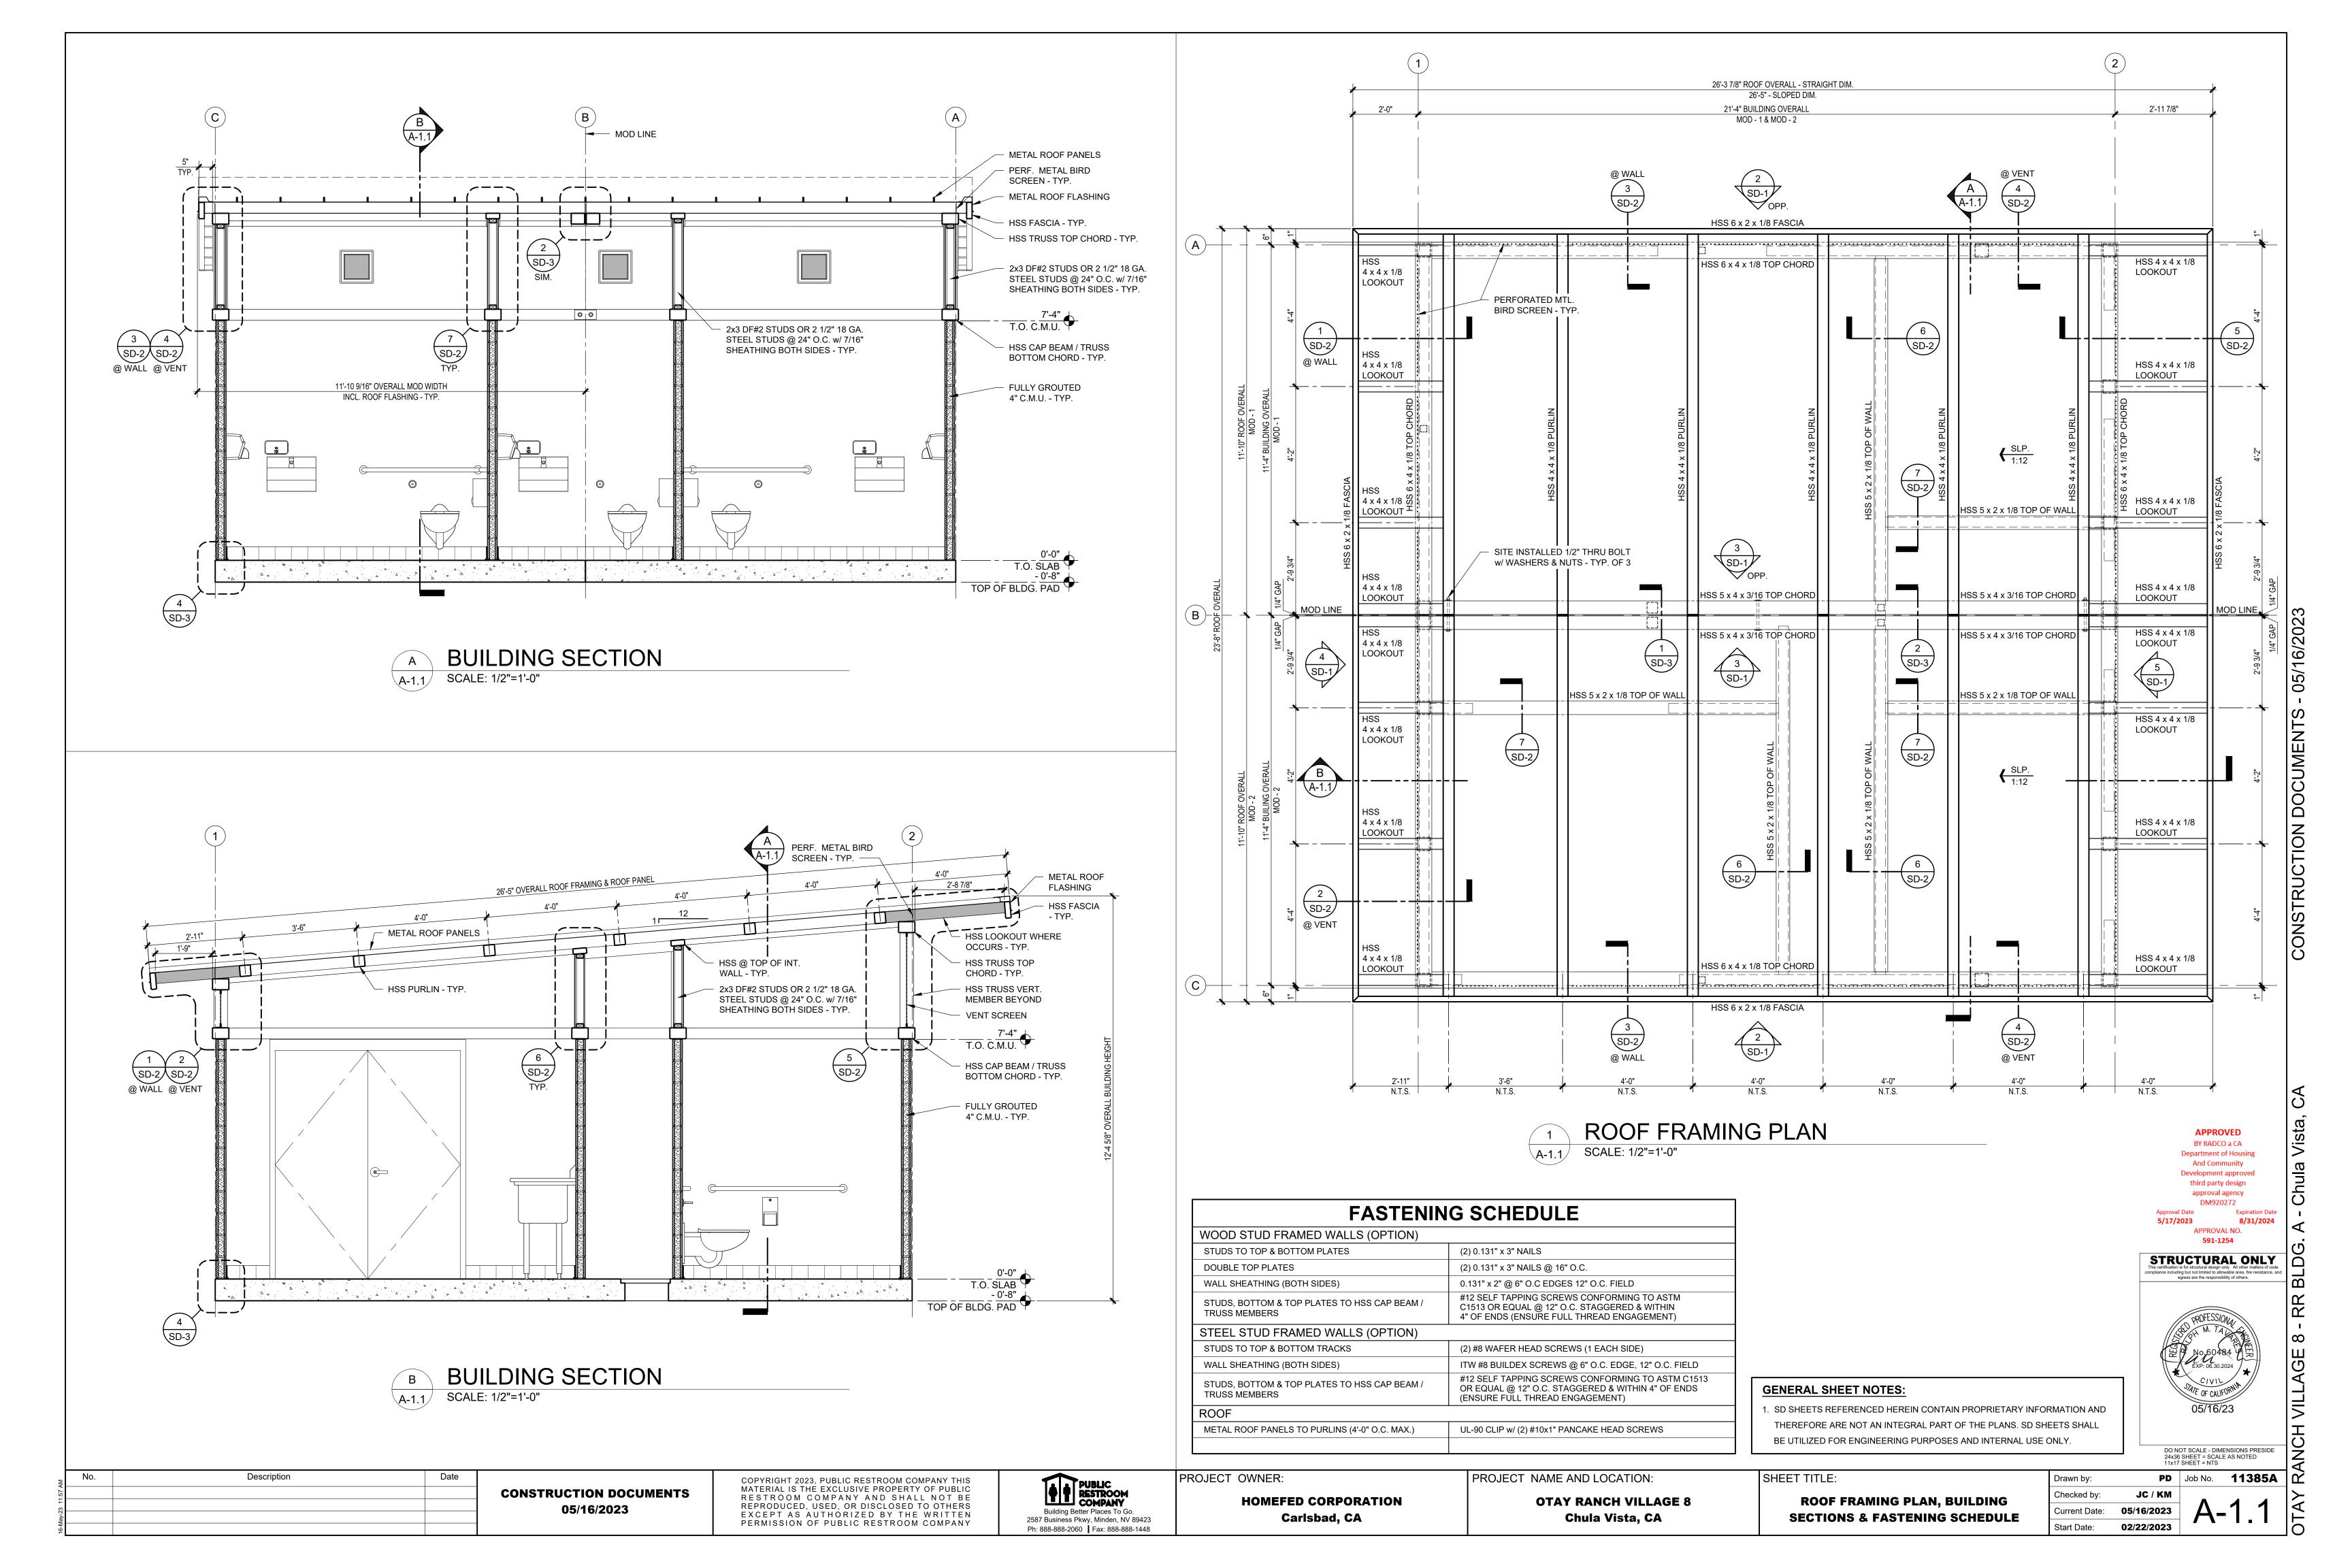



INTERIOR FINISH SCHEDULE							
COMPONENT	DESCRIPTION	FINISH BRAND / COLOR		NOTES			
FLOOR		1					
RESTROOMS	CONCRETE	6x6 QUARRY TILE	DALTILE - QUARRY TEXTURES / ASHEN GRAY - OTO3	EDOVY CROUT COLOR, RISCUIT 44, DO NOT SEAL CONCRETE			
RESTROOMS	CONCRETE	6x5 QUARRY COVE BASE	DALTILE - QUARRY TEXTURES / ASHEN GRAY - 0103	EPOXY GROUT COLOR: BISCUIT - 14; DO NOT SEAL CONCRETE			
STORAGE / MECH. ROOM	CONCRETE	POLYMER COATING	CROWN POLYMERS / GRAY	SKID RESISTANT COLOR CHIPS: A1435 - BLUE BLEND #B22-2104			
FARMERS WET ROOM	CONCRETE	POLYMER COATING	CROWN POLYMERS / GRAY	SKID RESISTANT COLOR CHIPS: A1435 - BLUE BLEND #B22-2104			
FAMIVIERS WET KUUIVI	CONCRETE	6x6 CERAMIC COVE BASE	DALTILE - GLAZED CERAMIC - S3619TN / ARCTIC WHITE 0190	EPOXY GROUT COLOR: BISCUIT - 14			
WALLS		•					
RESTROOMS	C.M.U PRECISION	BLOCK FILLER / PAINTED	PITTSBURGH PITT-TECH / PURE WHITE - 90-374	2 COATS BLOCK FILLER, 2 COATS FINISH / SEMI-GLOSS			
CAP BEAM & TRUSSES	STEEL	PAINTED	PITTSBURGH PITT-TECH / PURE WHITE - 90-374	1 COAT PRIMER, 2 COATS FINISH / SEMI-GLOSS			
ABOVE CAP BEAM	F.R.C TEXTURED PATTERN	PAINTED	PITTSBURGH PITT-TECH / PURE WHITE - 90-374	1 COAT PRIMER, 2 COATS FINISH / SEMI-GLOSS			
STORAGE / MECH. ROOM	C.M.U PRECISION	BLOCK FILLER / PAINTED	PITTSBURGH PITT-TECH / PURE WHITE - 90-374	1 COAT BLOCK FILLER, 1 COAT FINISH / SEMI-GLOSS			
STORAGE / MECH. ROOM	P.V.C. PANELS & TRIM	PREFINISHED	EXTRUTECH PLASTICS / WHITE	BEHIND MOP SINK; CLASS A RATED			
CAP BEAM & TRUSSES	STEEL	PAINTED	PITTSBURGH PITT-TECH / PURE WHITE - 90-374	1 COAT PRIMER, 2 COATS FINISH / SEMI-GLOSS			
ABOVE CAP BEAM	WOOD SHEATHING	PAINTED	PITTSBURGH PITT-TECH / PURE WHITE - 90-374	1 COAT PRIMER, 2 COATS FINISH / SEMI-GLOSS			
FARMERS WET ROOM	C.M.U PRECISION	BLOCK FILLER / PAINTED	PITTSBURGH PITT-TECH / PURE WHITE - 90-374	2 COATS BLOCK FILLER, 2 COATS EPOXY FINISH / SEMI-GLOSS			
CAP BEAM & TRUSSES	STEEL	PAINTED	PITTSBURGH PITT-TECH / PURE WHITE - 90-374	1 COAT PRIMER, 2 COATS FINISH / SEMI-GLOSS			
ABOVE CAP BEAM	F.R.C TEXTURED PATTERN	PAINTED	PITTSBURGH PITT-TECH / PURE WHITE - 90-374	1 COAT PRIMER, 2 COATS FINISH / SEMI-GLOSS			
CEILING							
ALL ROOMS	UNDERSIDE OF METAL ROOFING	PREFINISHED	METAL SALES / WHITE	-			
ALL ROUNS	STEEL ROOF MEMBERS	PAINTED	PITTSBURGH PITT-TECH / PURE WHITE - 90-374	1 COAT PRIMER, 2 COATS FINISH / SEMI-GLOSS			

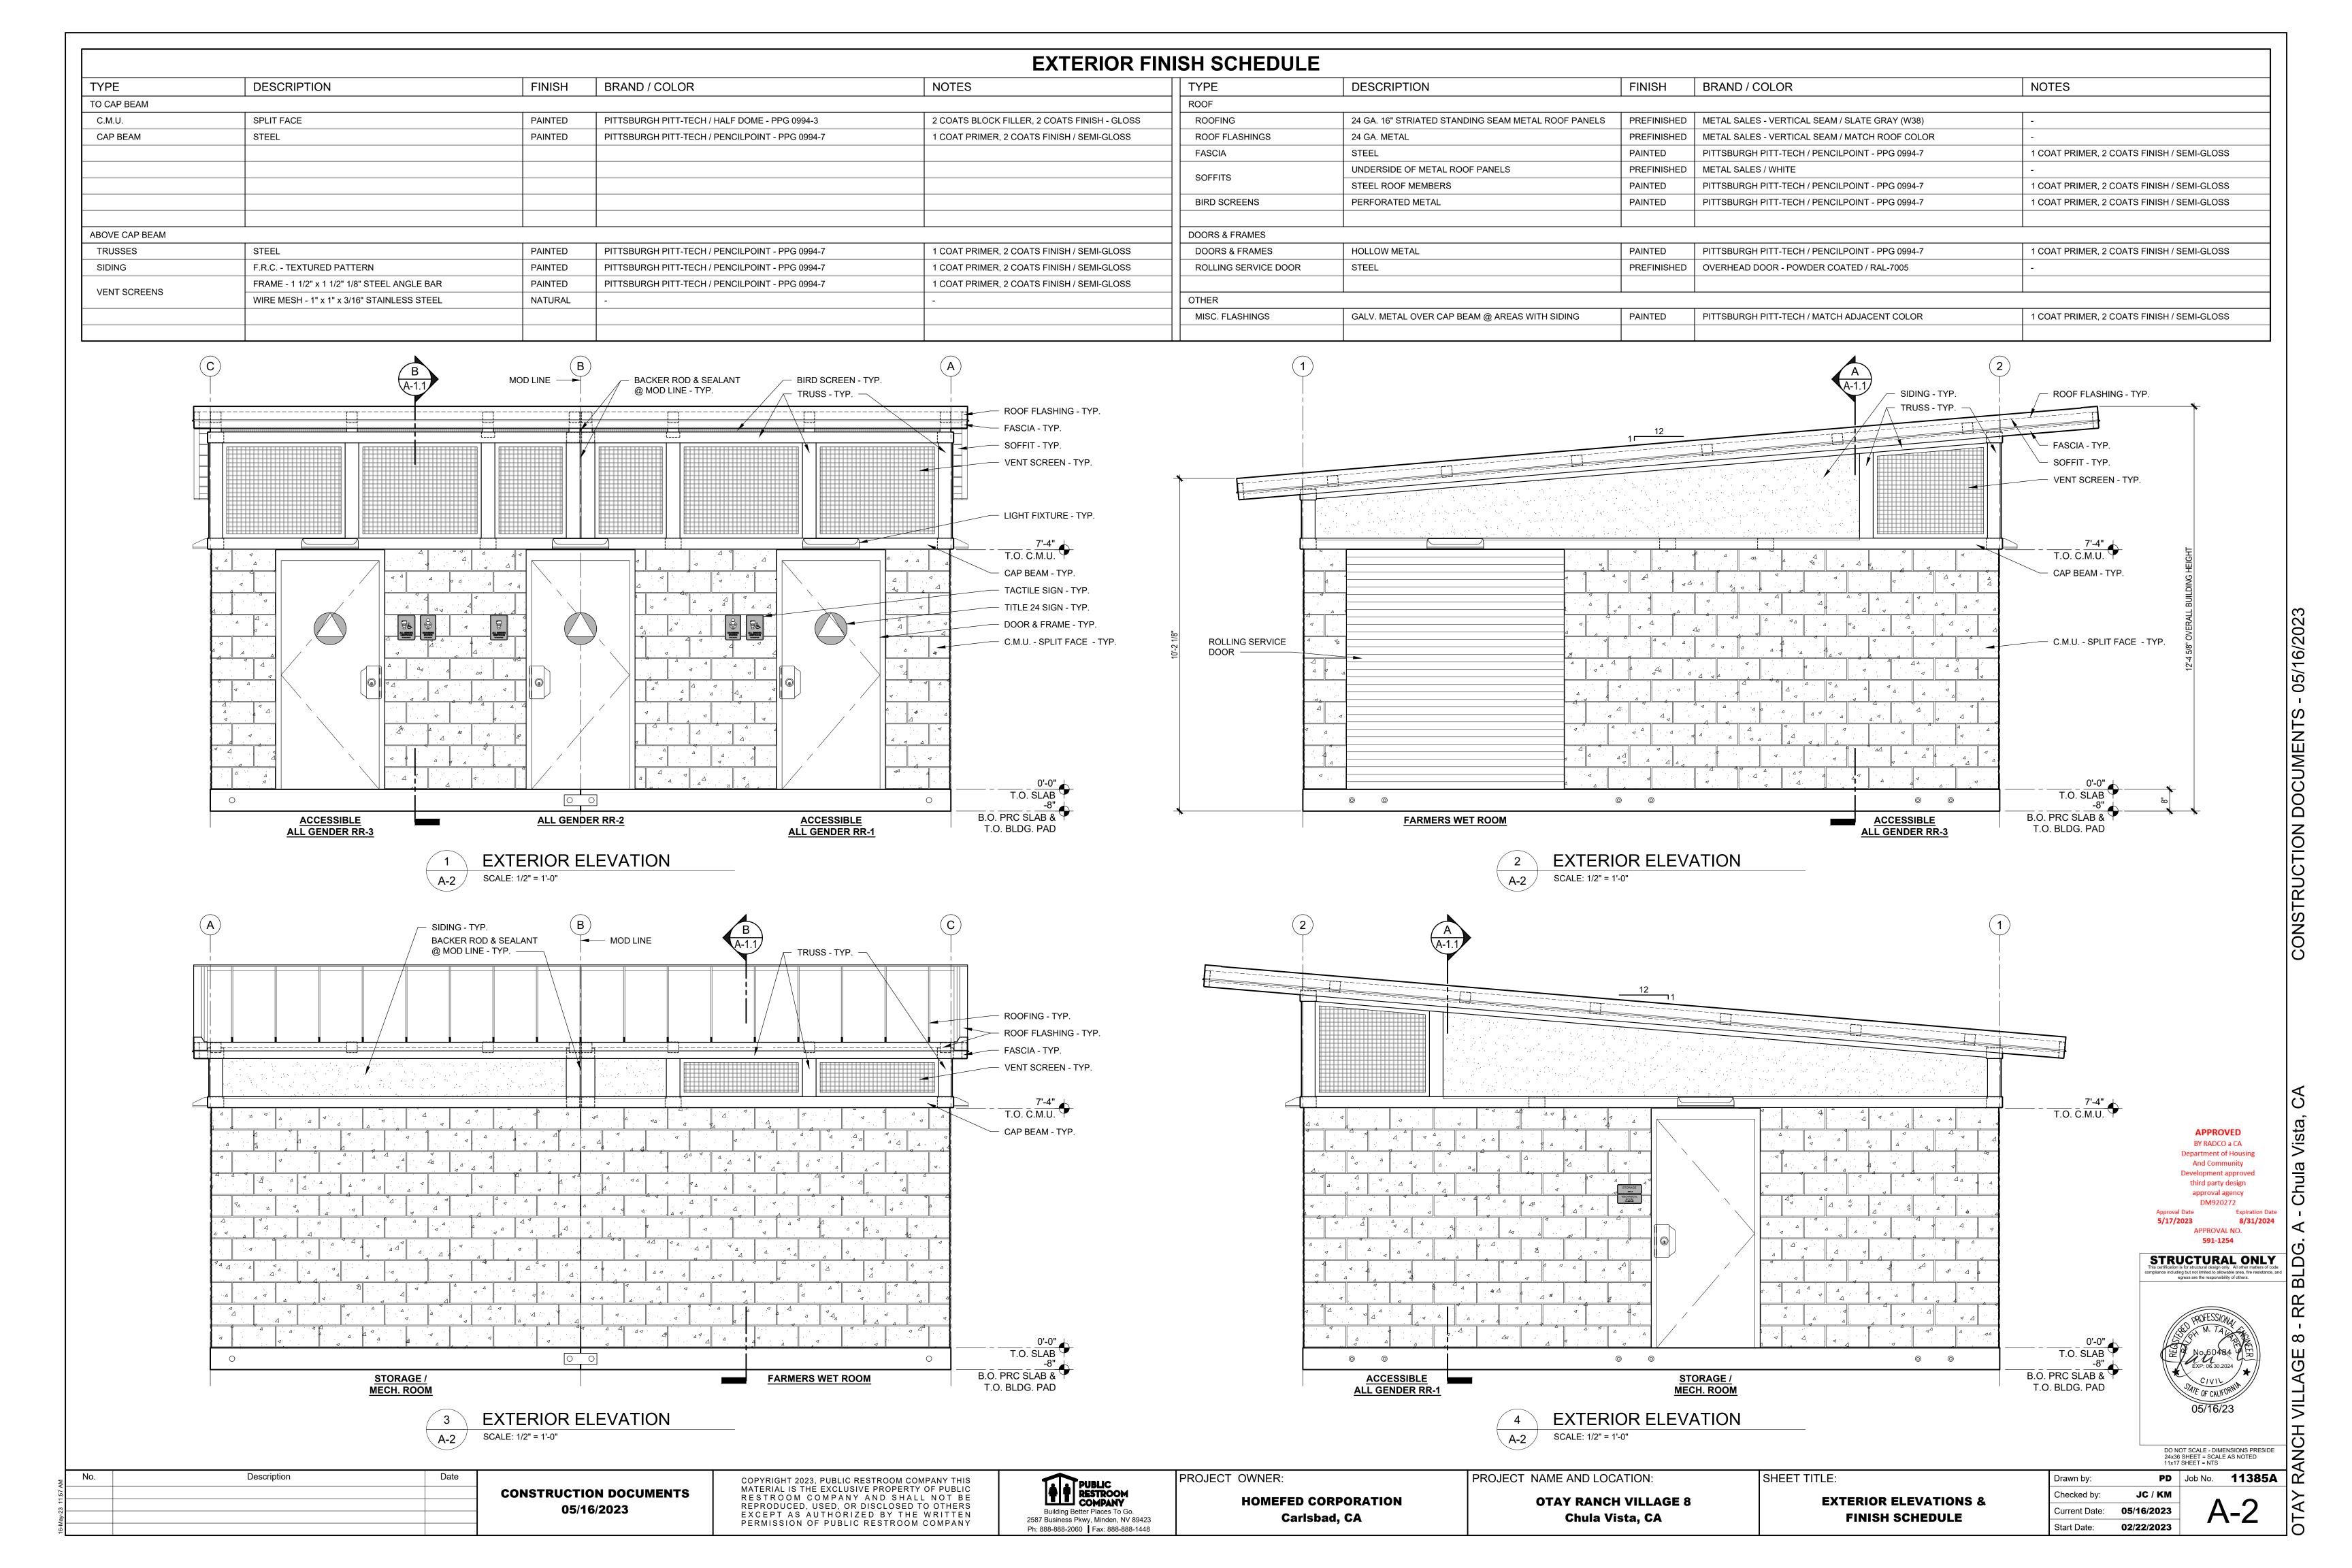



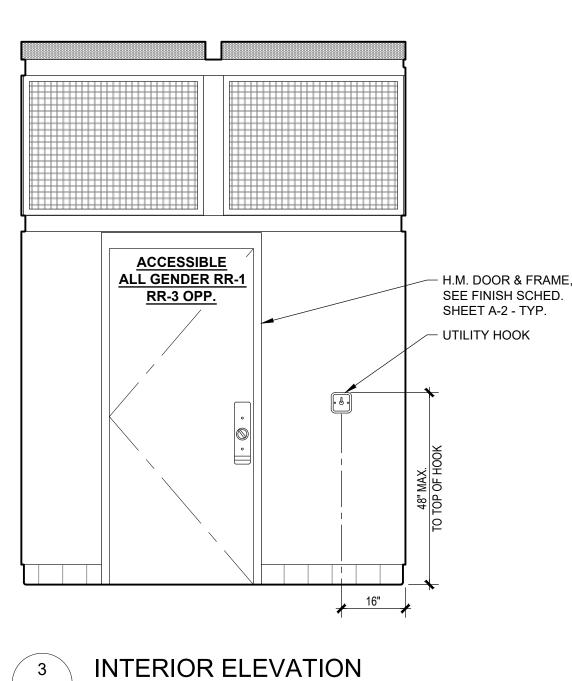


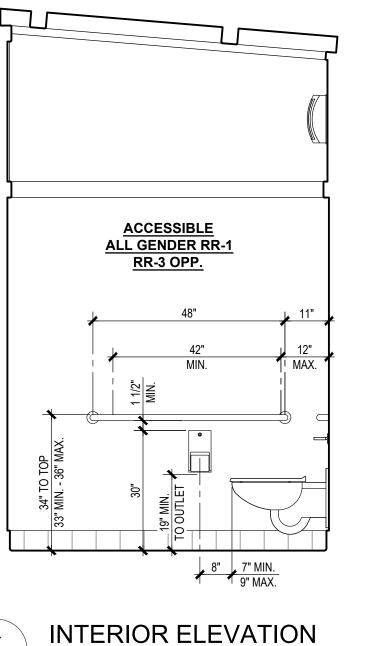


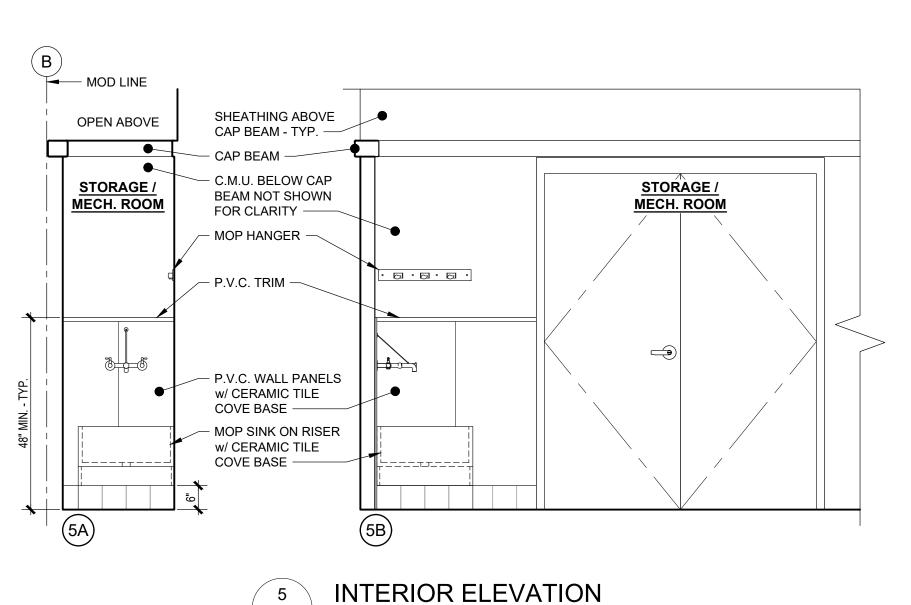



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A-3




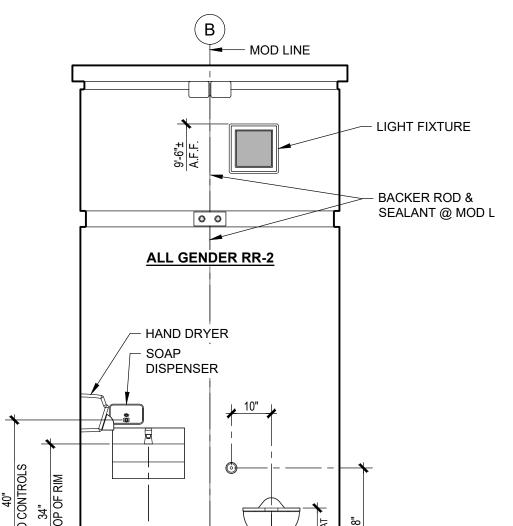

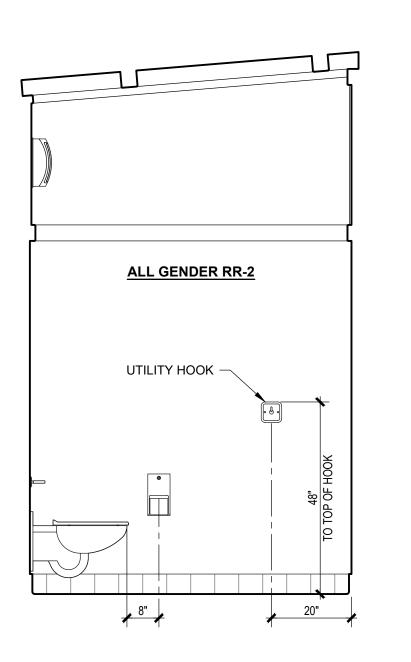

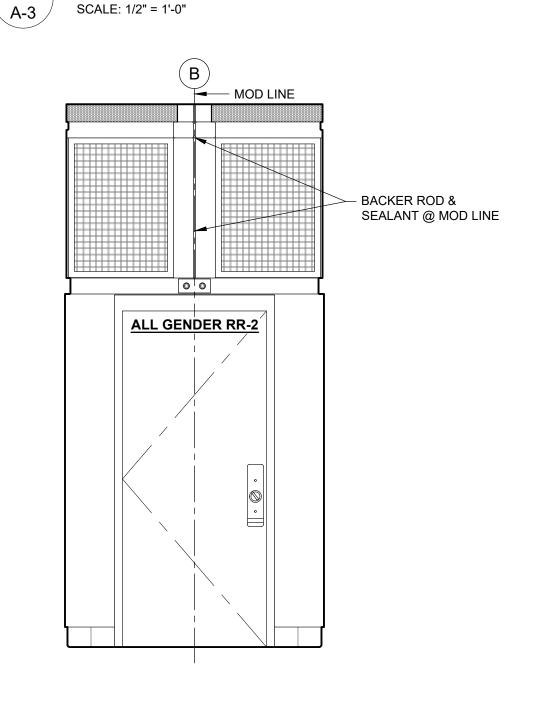

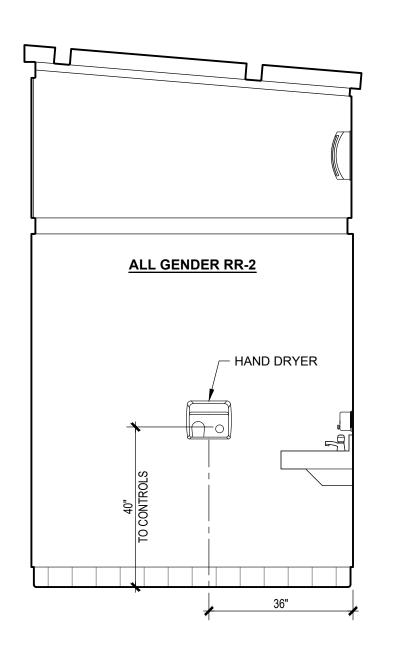SCALE: 1/2" = 1'-0"

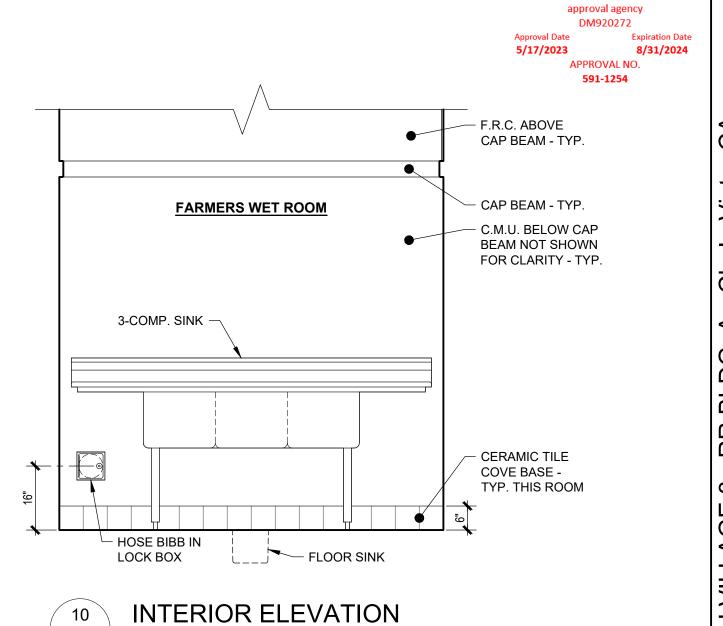









PROJECT NAME AND LOCATION:

SCALE: 1/2" = 1'-0" SHEET TITLE:

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APPROVED BY RADCO a CA Department of Housing

And Community

Development approved third party design

	Date	Description	Ю.
CONSTRUCTION DOCUMENTS			
05/16/2023			
03/10/2023			

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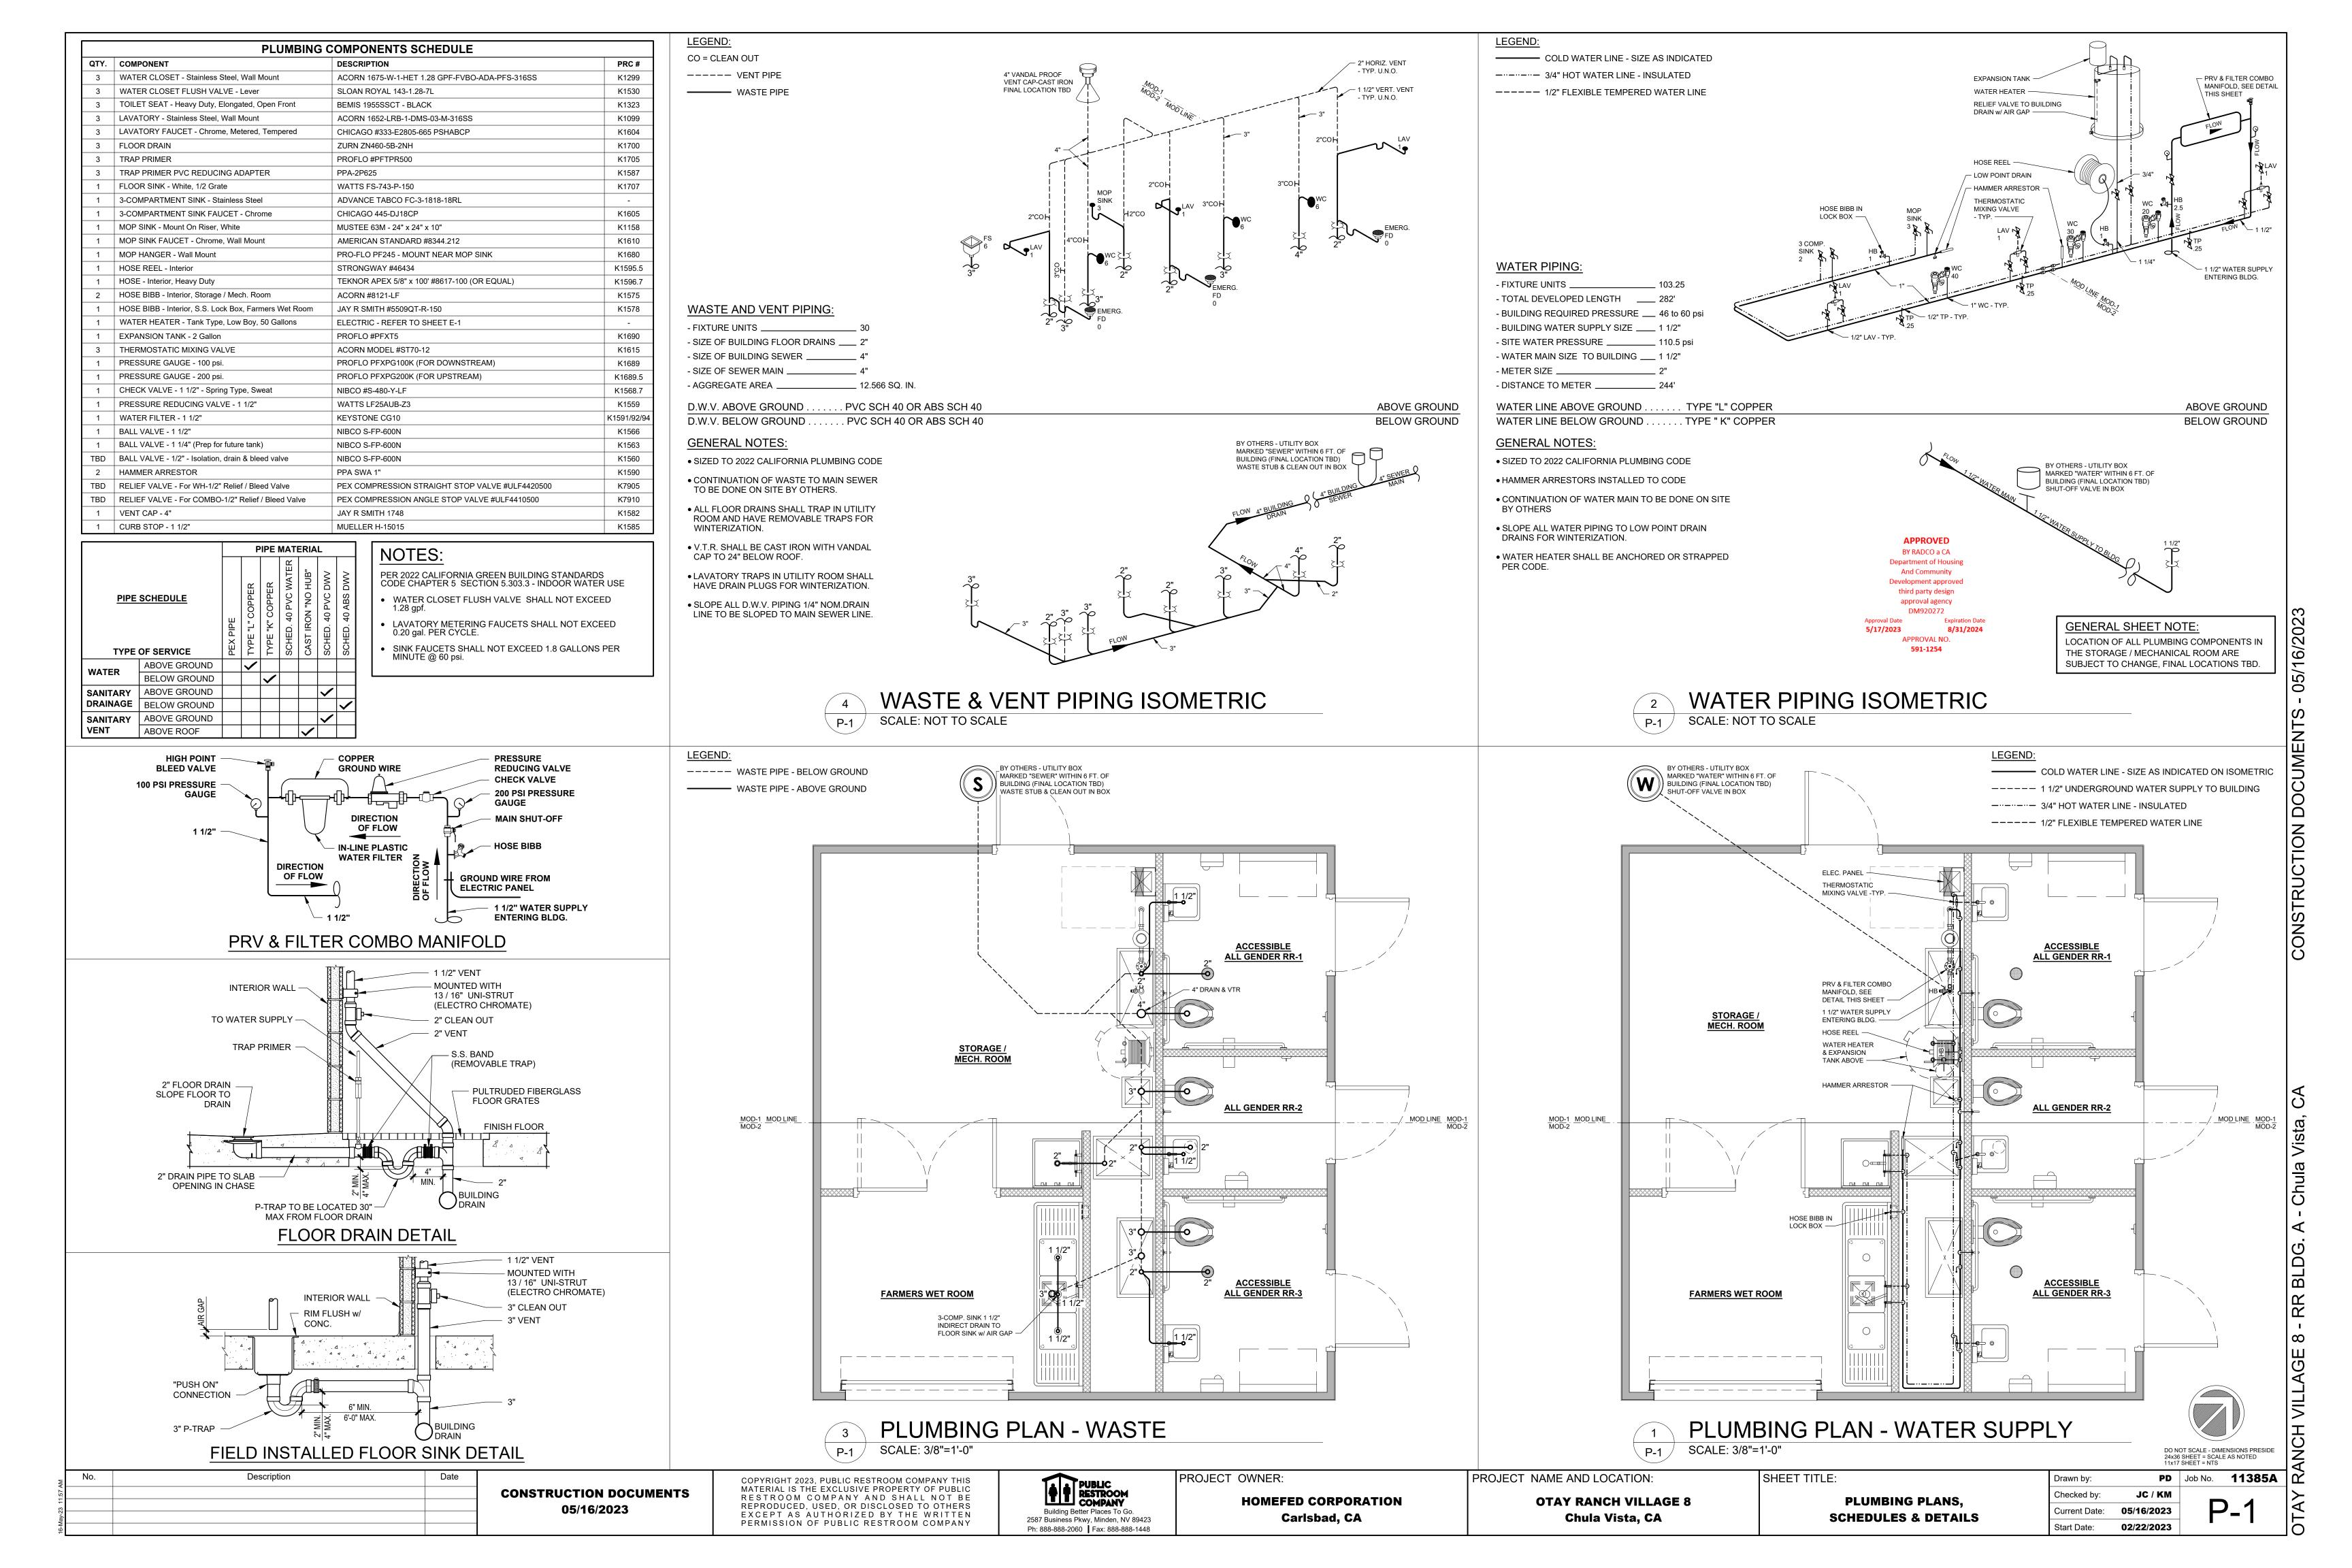
HOMEFED CORPORATION Carlsbad, CA

PROJECT OWNER:

OTAY RANCH VILLAGE 8 Chula Vista, CA

INTERIOR ELEVATIONS & SCHEDULES

02/22/2023



ELECTRICAL COMPONENTS SCHEDULE												
SYMBOL		QTY.	RATING	DESCRIPTION	MODEL	HEIGHT	COMMENTS	PRC #				
ELECTRICAL PANEL		1	125 AMP MAIN BREAKER	120/240V SINGLE PHASE - 3 WIRE, PLUG-ON BREAKERS, NEMA 1 ENCLOSURE	SQUARE D QO124M125P (OR EQUAL)	72" A.F.F. TOP OF PANEL	FURRED OUT AS NEEDED	-				
LIGHT - EXTERIOR		5	10 WATTS	LED - WALL MOUNT, VANDAL RESISTANT, FULL CUT-OFF	LUMINAIRE AEL-12-NODIM-10W-40K-120-DP-BZH	ON CAP BEAM	-	L1153				
LIGHT - RESTROOMS	(CC)	3	15 WATTS	LED - SURFACE MOUNT, VANDAL RESISTANT	LUMINAIRE SWP1212-NODIM-15W-40K-120-OP-BRZ-OCC	SEE SHEET A-3	BUILT-IN OCCUPANCY SENSOR	L1168.5				
LIGHT- ST. / M.R. & FARMERS	//////// 30	4	30 WATTS	LED T8 (2) TUBE - SURFACE MOUNT, SEALED SHATTERPROOF PLASTIC HOUSING	GREENLIGHTING AL-42L	CEILING MOUNTED	-	L1108				
LIGHT- STOR. / MECH. ROOM	7/////// 15	2	15 WATTS	LED T8 (1) TUBE - SURFACE MOUNT, SEALED SHATTERPROOF PLASTIC HOUSING	GREENLIGHTING AL-41L	CEILING MOUNTED	-	L1107				
EMERGENCY LIGHT		2	3 WATTS	LED - WALL MOUNT	LITHONIA MODEL #ELM2L (OR EQUAL)	ABOVE CAP BEAM	WIRE AHEAD OF SWITCH	L1198				
SWITCH	\$ occ	1	-	SINGLE POLE MANUAL ON/OFF SWITCH WITH OCCUPANCY SENSOR	LEVITON DECORA ODS10-IDW	48" MAX. A.F.F. TO TOP	-	L1879				
SWITCH	\$ OCC2	1	-	DOUBLE POLE MANUAL ON/OFF SWITCH WITH OCCUPANCY SENSOR	LEVITON DECORA ODS0D-IDW	48" MAX. A.F.F. TO TOP	-	-				
SWITCH	\$	2	-	SINGLE POLE MANUAL ON/OFF SWITCH	LEVITON 1221-2W	48" MAX. A.F.F. TO TOP	(1) STOR. / MECH. ROOM - (1) BYPASS SWITCH - RR-3 LIGHT	L1868				
SWITCH	\$2	1	-	DOUBLE POLE MANUAL ON/OFF SWITCH	LEVITON 1222-2W	48" +/- A.F.F. TO TOP	BYPASS SWITCH - RR-1 & RR-2 LIGHTS	L1872				
SWITCH	\$	1	-	SINGLE POLE MANUAL ON/OFF SWITCH	LEVITON 1221-2R	48" +/- A.F.F. TO TOP	BYPASS SWITCH - EXTERIOR LIGHTS	L1870				
PHOTOCELL	•	1	1800 WATTS	NIGHTFOX WALL MOUNT ELECTRONIC PHOTOCONTROL, 120-277V	INTERMATIC EK4336S	SEE SHEET A-2	CONTROLS EXTERIOR LIGHTS	L1896				
RECEPTACLE - DUPLEX	∯ GFCI	5	1500 WATTS	20 AMP, 125 VOLT GFCI DUPLEX RECEPTACLE	LEVITON GFNT2-W	48" A.F.F. TO TOP	-	L1876				
HAND DRYER	HD	3	1725 WATTS	SURFACE MOUNTED - PUSH BUTTON HAND DRYER	WORLD DRYER DA52-973 - STAINLESS STEEL / BRUSHED	40" MAX. A.F.F. TO CONTROLS	-	-				
WATER HEATER - TANK TYPE, L		1	10000 WATTS	50 GALLON COMMERCIAL ELECTRIC WATER HEATER	AO SMITH DEL-50 (OR EQ.) - 5000/5000 ELEMENTS	-	WIRED FOR 240V SIMULTANEOUS OPERATION, STRAP PER CODE	-				
		+	+					+				

LIGHTING CONTROLS SCHEDULE						
AREA	CONTROLS					
RESTROOMS	OCCUPANCY SENSOR BUILT-IN TO LIGHT FIXTURE / PHOTOCELL OVERRIDES OCCUPANCY SENSOR / BYPASS SWITCH OVERRIDES OCCUPANCY SENSOR & PHOTOCELL FOR MAINTENANCE					
STORAGE	MANUAL ON/OFF SWITCH WITH OCCUPANCY SENSOR					
MECH. ROOM	MANUAL ON/OFF SWITCH					
FARMERS WET ROOM	MANUAL ON/OFF SWITCH WITH OCCUPANCY SENSOR, MULTI-LEVEL LIGHTING 50% & 100%					
EXTERIOR	PHOTOCELL / BYPASS SWITCH "ON" OVERRIDES PHOTOCELL FOR MAINTENANCE					

MOD LINE ELECTRICAL CONNECTOR

NOTES:	

. ALL CONDUCTORS ARE COPPER WIRES.


AUTOMATION DIRECT STD SERIES


- 2. RATING OF STANDARD PANEL IS 22,000 A.I.C. 3. WIRING METHOD IN METALLIC CONDUIT. (MC CABLE,
- EMT, METALLIC FLEX.
- 4. INSTALL CEE GROUND IN SLAB, TERMINATING IN UTILITY CHASE.
- 5. GREEN GROUNDING CONDUCTOR IN ALL RACEWAYS.

				P	ANE	L SCHE	DUI	LE				
	NOTE: ALL CONDUCTORS	COPPER				MAIN BREAKER				120/24	40V - SINGLE PHASE - 3 WIRE	
СКТ	DESCRIPTION	CIR. BREAKER TRIP AMPS	WIRE SIZE	TOTAL V.A.	_	125 AMP		TOTAL V.A.	WIRE SIZE	CIR. BREAKER TRIP AMPS	DESCRIPTION	CKT
1	EXTERIOR LIGHTS	20	12	50		—		5000	6	60	WATER HEATER	2
3	RESTROOM LIGHTS	20	12	45		—		5000	6	60	" "	4
5	STORAGE / MECH. ROOM LIGHTS	20	12	96		—		1500	12	20	DEDICATED GFCI RECEPTACLE / MOD-2	6
7	FARMERS WET ROOM LIGHTS	20	12	60		—		1500	12	20	DEDICATED GFCI RECEPTACLE / MOD-2	8
9	HAND DRYER / RR-1	20	12	1725		—						10
11	HAND DRYER / RR-2	20	12	1725		—						12
13	HAND DRYER / RR-3	20	12	1725		—						14
15	DEDICATED GFCI RECEPTACLE / MOD-1	20	12	1500		—						16
17	DEDICATED GFCI RECEPTACLE / MOD-1	20	12	1500		—						18
19	DEDICATED GFCI RECEPTACLE / MOD-1	20	12	1500		—						20
21						—						22
23												24

MOD LINE ELECTRICAL CROSSOVER CONNECTOR

	ELE	ECTRICAL LOA	D CALCULATI	IONS				
PANEL: 125 AMP 120/240V - SIN	GLE PHASE -	3 WIRE						
COMPONENT		CONNECTED LOAD (V.A.)	CONNECTED LOAD (V.A.) CALCULATED LOAD (V.A.)					
EXTERIOR LIGHTING		50	CONNECTED LOAD x 1.25		62.50			
INTERIOR LIGHTING		201	CONNECTED LOAD x 1.25		251.25			
WATER HEATER		10000	CONNECTED LOAD x 1.25		12500.00			
(1) HAND DRYER (LARGEST MC	TOR)	1725	CONNECTED LOAD x 1.25		2156.25			
(2) HAND DRYERS		3450	CONNECTED LOAD x 1.00		3450.00			
(5) RECEPTACLES		7500	CONNECTED LOAD x 1.00		7500.00			
TOTAL LOAD		22926	TOTAL LOAD		25920.00			
TOTAL CONNECTED LOAD	KVA	22.926	TOTAL CALCULATED	KVA	25.920			
TOTAL CONNECTED LOAD	AMPS	95.525	LOAD	AMPS	108.000			

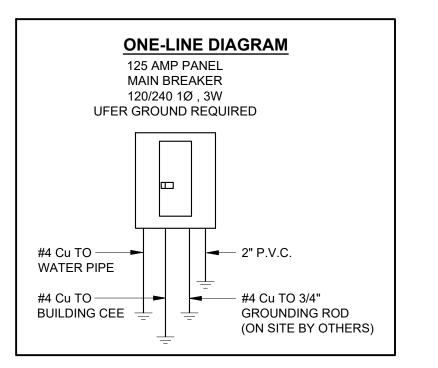

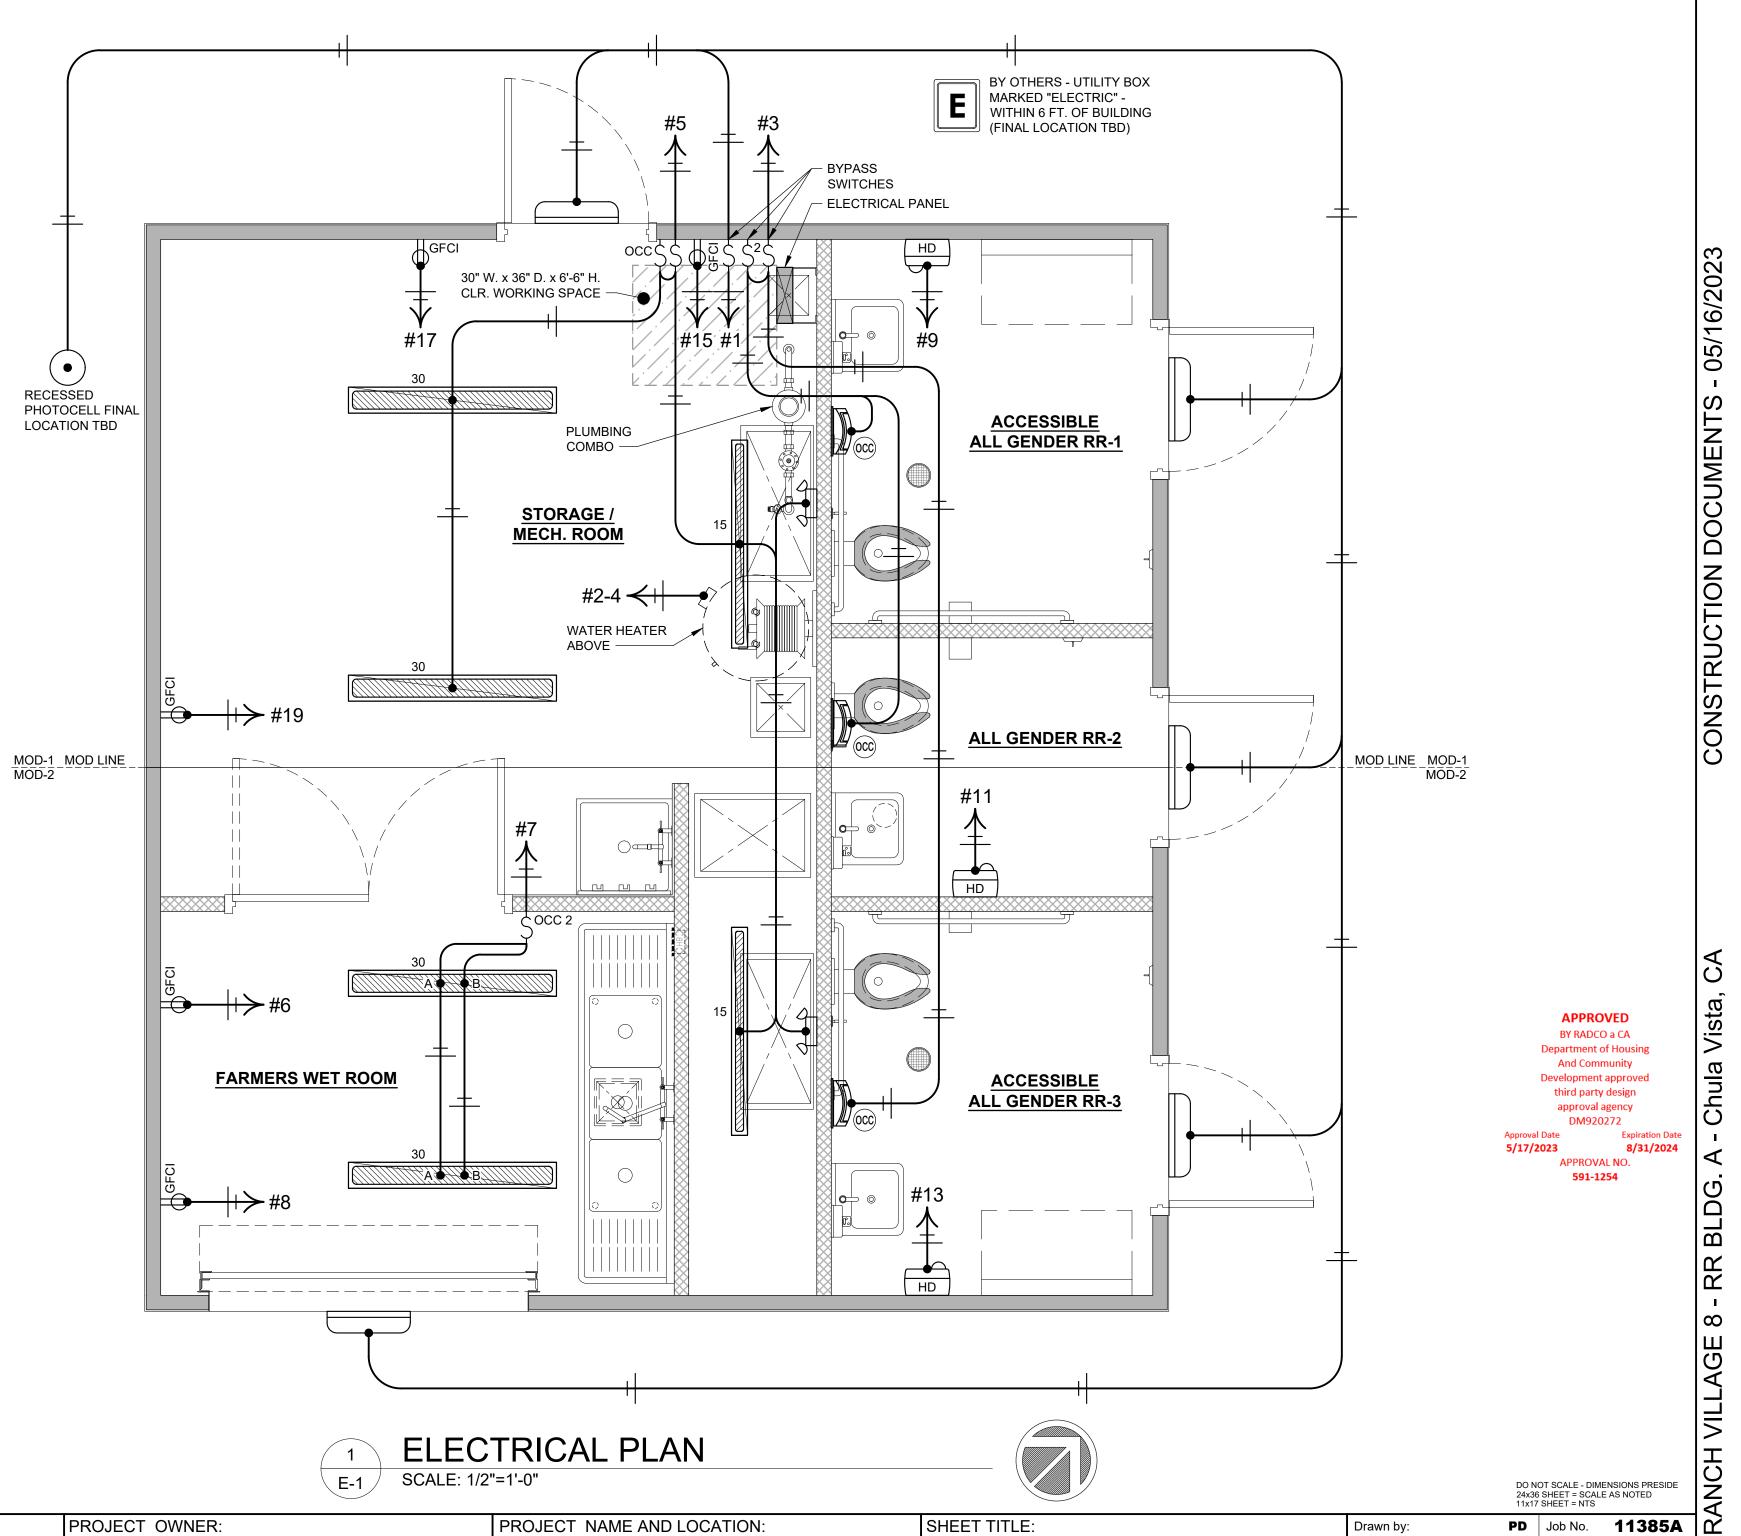

Description

CONSTRUCTION DOCUMENTS 05/16/2023

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HOMEFED CORPORATION Carlsbad, CA

COMPONENTS & QUANTITIES AS NEEDED

PROJECT NAME AND LOCATION: **OTAY RANCH VILLAGE 8** Chula Vista, CA

ELECTRICAL PLAN & SCHEDULES

PD Job No. 11385A Drawn by: Checked by: 05/16/2023 Current Date: 02/22/2023

GENERAL SHEET NOTE:

LOCATION OF ALL ELECTRICAL COMPONENTS IN THE STORAGE / MECHANICAL ROOM ARE SUBJECT TO CHANGE, FINAL LOCATIONS TBD.

OVERSIZED CLEARANCE HOLE IN

LARGER THAN NEEDED @ EACH

ANGLE FOR 1" Ø - 8 BOLT 1/8"


COUPLER NUT - 3/16" FILLET


WELD ALL AROUND

SECTION

COUPLER NUT



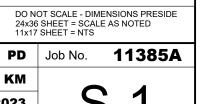

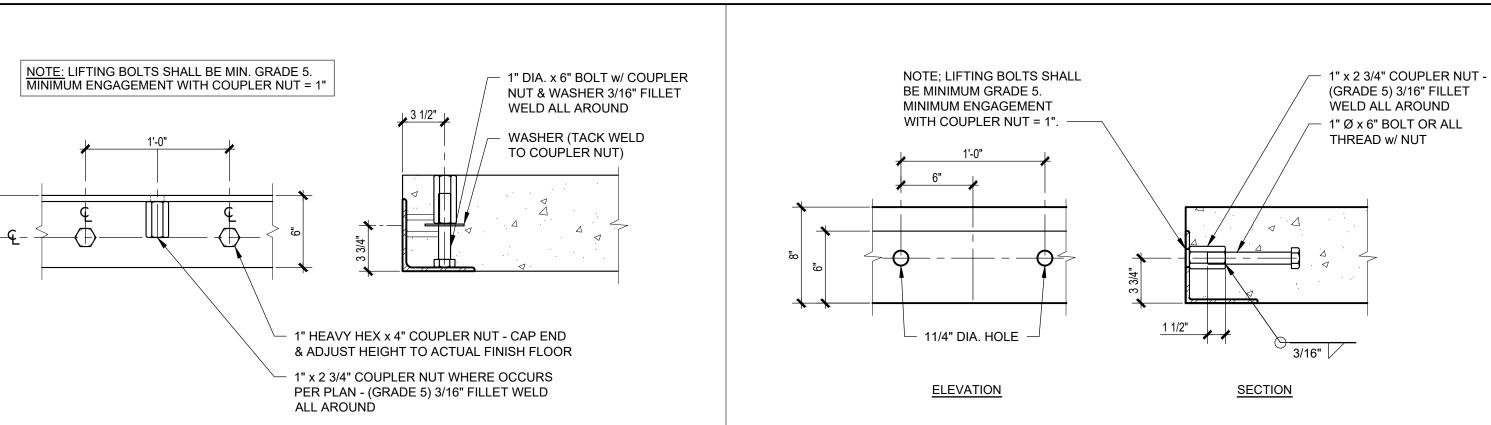

SIDE RIGGING EMBEDDED ANCHOR DET. S-1 SCALE: 1 1/2"=1'-0"

OPTIONAL SLOT CONNECTION PLATE: 4" x 12" x 1/2" STEEL PLATE - 1 1/8" DIA. TYP. - 1" x 2 3/4" COUPLER NUT -(GRADE 5) 3/16" FILLET WELD ALL AROUND FRAME ANGLE L 6 x 6 x 5/16 (HAS GAP) PERIMETER ANGLE L 6 x 6 x 5/16 (NO GAP) 1/2" CONNECTION PLATE - HOLE IN ANGLE (SIZE 1'-0" TO ACCEPT TURNED DOWN COUPLER NUT) — 1" DIA. BOLTS PLAN VIEW

CONCRETE SLAB MOD LINE CONN. DET. S-1 SCALE: 1 1/2"=1'-0"


CONCRETE SLAB EXTERIOR STEEL FRAME @ CORNER DETAIL

STEEL ANGLE

- CAP ENDS TYP.

6" x 6" x 5/16"

S-1 SCALE: 1 1/2"=1'-0"

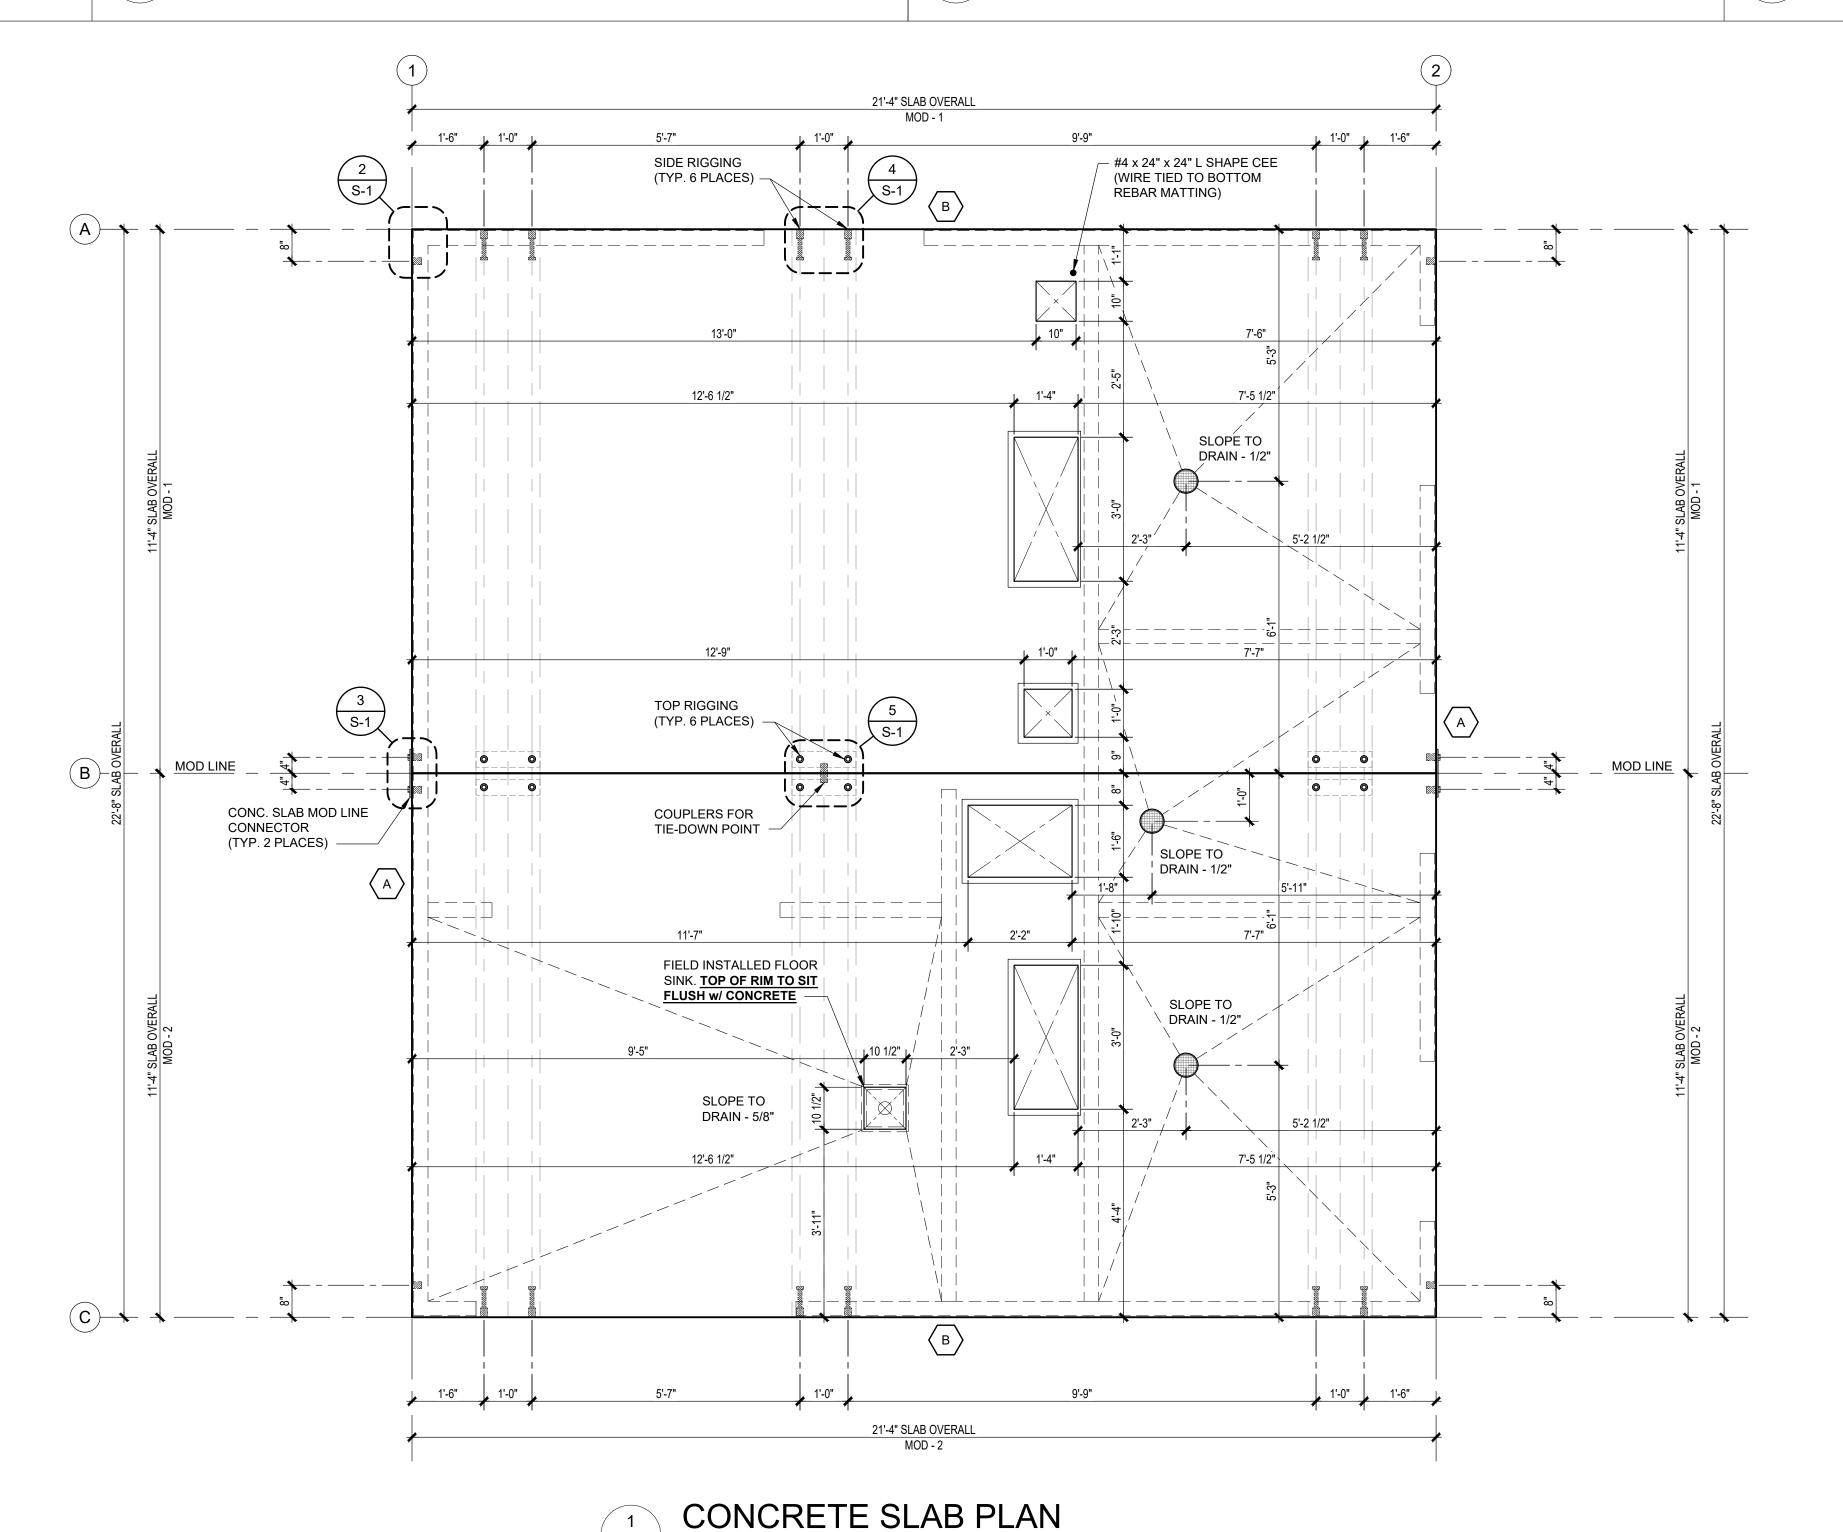



ALL REBAR TO BE GRADE 60.

PLAN VIEW

ALL WELDABLE REINFORCEMENTS TO BE ASTM A706.

ONLY WHERE REQUIRED BY SPECIFIED SLOPES.

PROVIDE (2) #5 BARS @ 8" O.C. TOP & BOTTOM AT PERIMETER OF EACH SLAB & PROVIDE (3) #5 BARS @ 8" O.C. TOP & BOTTOM AT EACH LIFTING LOCATION.

TOP MAT: ADD TRIMMER BARS NEXT TO BLOCK OUTS IF CLEARANCE TO REGULAR LAYOUT IS GREATER THAN 2". TRIMMER BARS EXTEND 18" PAST OPENING, OR TERMINATE WITH 90° HOOK AND 8" EXTENSION. CENTER OF TRIMMER BARS TO BLOCK OUTS TO BE 2", TYP.

PROVIDE (2) DIAGONAL 24" LONG #4 REBARS (1 @ TOP MAT & 1 @ BOTTOM MAT) @ EACH SLAB OPENING.

SMALL BLOCK OUTS (8" x 8" MAX.) MAY BE ADDED AS REQUIRED FOR SERVICES. ADD DIAGONAL TRIMMER BARS IF CLEARANCE TO REGULAR LAYOUT IS GREATER THAN 2".

SPLICES: #4 BARS - 20" LAP #5 BARS - 24" LAP

10. PROTECT PIPE & FLOOR DRAINS THAT WILL BE ENCASED IN THE CONCRETE BY PROVIDING AN APPROVED WRAP.

ONLY WHERE NOTED, IT IS ACCEPTABLE TO NOTCH HORIZONTAL LEG OF PERIMETER ANGLE.

ALL EXPOSED FACES OF SLAB PERIMETER STEEL ANGLES SHALL RECEIVE GALVANIZING PAINT COATING.

SLAB LOADS SCHEDULE VERTICAL LOAD LATERAL LOAD MARK LOCATION

A	WALL LINE (GRID) 1 & 2	1,200 - PLF	1,070 - LBF
В	WALL LINE (GRID) A & C	1,000 - PLF	910 - LBF

NOTE: SCHEDULE VALUES PER ASD LOAD COMBINATION

FLOOR FINISH SCHEDULE:

RESTROOMS - QUARRY TILE / DO NOT SEAL FLOORS STORAGE / MECH. ROOM & FARMERS WET ROOM -POLYMER COATING / DO NOT SEAL FLOORS

> APPROVAL NO. 591-1254





PROJECT OWNER: PROJECT NAME AND LOCATION:

OTAY RANCH VILLAGE 8

SHEET TITLE:

CONCRETE SLAB PLAN & DETAILS

Checked by: Current Date: 05/16/2023 02/22/2023

Description **CONSTRUCTION DOCUMENTS** 05/16/2023

TOP RIGGING EMBEDDED ANCHOR DET.

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Drawn by: