PLUMBING SPECIFICATIONS

- 0.00 GENERAL PROVISIONS
- DEFINITIONS: THE TERMS LISTED BELOW ARE DEFINED AS FOLLOWS WHEN USED IN MECHANICAL AND PLUMBING WORK.
- WORK: LABOR AND MATERIALS OF THE CONTRACTOR AND/OR SUBCONTRACTOR.
- FURNISH: OBTAIN, COORDINATE, SUBMIT THE NECESSARY DRAWINGS. DELIVER TO THE JOBSITE IN NEW CONDITION AND GUARANTEE.
- INSTALL: RECEIVE AT THE JOB-SITE, UNLOAD, STORE, SET IN PLACE, CONNECT, PLACE IN OPERATION AND GUARANTEE.
- PROVIDE: FURNISH AND INSTALL CONNECT: BRING SERVICE TO THE EQUIPMENT AND MAKE FINAL ATTACHMENTS INCLUDING NECESSARY PIPE FITTINGS, DUCTWORK,
- TRANSITIONS, ETC. CONCEALED: HIDDEN FROM SIGHT IN CHASES, FURRED SPACES, SHAFTS, ABOVE CEILING, EMBEDDED IN CONSTRUCTION, IN CRAWL SPACES OR BURIED.
- EXPOSED: NOT INSTALLED UNDERGROUND NOR CONCEALED AS DEFINED ABOVE.
- PERFORMANCE: MECHANICAL CONTRACTOR SHALL PERFORM ALL WORK SPECIFIED, INDICATED AND REQUIRED UNLESS OTHERWISE NOTED, INCLUDING FINAL CONNECTIONS, IN A WORKMANLIKE MANNER USING WORKERS SKILLED AND EXPERIENCED IN THE TRADE.
- SITE EXAMINATION: EXAMINE SITE BEFORE BIDDING. CLAIM NO EXTRAS RESULTING FROM LACK OF KNOWLEDGE OF SITE CONDITIONS. IF SITE CONDITIONS REQUIRE MODIFICATION OF THE SYSTEMS INDICATED IN THESE DOCUMENTS, SO ADVISE ENGINEER, AND IF ACCEPTED BY ENGINEER, INCLUDE COST OF SUCH MODIFICATIONS IN BID.
- JOBSITE CONDITIONS: ACCEPT SOLE AND COMPLETE RESPONSIBILITY FOR CONDITIONS OF THE JOB SITE, INCLUDING SAFETY OF ALL PERSONS AND PROPERTY DURING PERFORMANCE OF THE WORK.
- FULL FUNCTION: PROVIDE ALL MINOR ITEMS NECESSARY FOR A COMPLETE AND FULLY FUNCTIONAL INSTALLATION.
- ADMINISTRATION: PROVIDE EVIDENCE OF LICENSING, BONDING, AND INSURANCE, AND PERFORM OTHER ADMINISTRATIVE FUNCTIONS, AS REQUIRED.
- PERMITS: PROCURE AND PAY FOR ALL REQUIRED PERMITS AND SERVICE CHARGES.
- COORDINATION: CONFORM TO GENERAL CONSTRUCTION CONTRACT DOCUMENTS EXCEPT AS MODIFIED HEREIN. REFER ALSO TO ARCHITECTURAL STRUCTURAL AND ELECTRICAL CONTRACT DOCUMENTS. COORDINATE ALL WORK WITH OTHER TRADES.
- CUTTING AND PATCHING: CUT AND PATCH AS REQUIRED. CUT OR WELD STRUCTURAL MEMBERS ONLY WITH APPROVAL OF STRUCTURAL ENGINEER. PATCHING SUBJECT TO APPROVAL BY ARCHITECT.
- 0.10 EXISTING FLOORS: TRENCH OR CORE BORE EXISTING FLOORS PER LANDLORD REQUIREMENTS.
- 0.11 ROOF PENETRATIONS: COORDINATE WITH LANDLORD.
- 0.12 EQUIPMENT SUBSTITUTIONS: REIMBURSE ELECTRICAL CONTRACTOR, AT NO CHARGE TO TENANT, FOR HIS COSTS INCURRED DUE TO SUBSTITUTION OF MECHANICAL EQUIPMENT HAVING ELECTRICAL REQUIREMENTS DIFFERING FROM THOSE INDICATED.
- ADJUSTMENTS: MAKE MINOR ADJUSTMENTS TO WORK WHERE REQUESTED BY TENANT, WHEN SUCH ADJUSTMENTS ARE NECESSARY TO PROPER OPERATION AND WITHIN THE INTENT OF THE CONTRACT.
- 0.14 REFERENCE STANDARDS: COMPLY WITH APPLICABLE STANDARDS OF NFPA, ANSI, UL, ASHRAE, AND SMACNA, EXCEPT AS SUPERSEDED BY LOCAL AUTHORITY. CONFORM WITH CONTRACT DOCUMENTS WHERE THEY EXCEED CODE MINIMUM REQUIREMENTS.
- 0.15 LOCAL REQUIREMENTS: COMPLY WITH THE REQUIREMENTS OF APPLICABLE CODES, LANDLORD, SERVING UTILITIES, AND THE LOCAL AUTHORITY HAVING JURISDICTION, SECURE APPROVAL OF INSTALLATION BY LANDLORD, LOCAL AUTHORITY, AND OTHERS AS REQUIRED.
- 0.16 MATERIALS AND EQUIPMENT: PROVIDE NEW, UL LISTED, COMMERCIAL GRADE MATERIALS, DEVICES, EQUIPMENT, AND FIXTURES, SUITABLE FOR ENVIRONMENT. REUSE EXISTING ONLY WHEN COMPLIANT WITH THE CONTRACT DOCUMENTS, IN GOOD CONDITION, AND APPROVED BY THE ENGINEER.
- SHOP DRAWINGS: BEFORE ORDERING EQUIPMENT AND MATERIALS, SUBMIT NOT LESS THAN FIVE CERTIFIED COPIES OF ALL SHOP AND EQUIPMENT DRAWINGS FOR ENGINEER'S REVIEW, WHO WILL RETAIN TWO COPIES. ONLY FURNISH SYSTEMS AND EQUIPMENT IN COMPLIANCE WITH ACCEPTED SHOP DRAWINGS.
- 0.18 INSTALLATION: INSTALL ALL MATERIALS, EQUIPMENT AND SYSTEMS IN FULL ACCORD WITH MANUFACTURERS' INSTRUCTIONS.
- 0.19 LAYOUT: INSTALL ALL PIPING AND DUCTWORK TO PRESENT A NEAT AND ORDERLY APPEARANCE. RUN ALL LINES PARALLEL WITH BUILDING CONSTRUCTION. MAINTAIN HEADROOM AND EQUIPMENT CLEARANCE, AND GRADIENT WHERE REQUIRED. ALLOW FOR EXPANSION AND CONTRACTION.
- 0.20 ACCESS DOORS: PROVIDE ACCESS DOORS OR PANELS FOR ALL VALVES, CLEANOUTS, DAMPERS, CONTROLS, DEVICES, AND OTHER ITEMS REQUIRING INSPECTION OR MAINTENANCE. ACCESS PANELS SERVING HVAC COMPONENTS SHALL BE 12-INCHES BY 12-INCHES MINIMUM OR LARGER TO PROVIDE SUFFICIENT WORKING CLEARANCE FOR COMPONENT BEING ACCESSED.
- 0.21 COMMISSIONING: THOROUGHLY TEST AND DEMONSTRATE PROPER OPERATION OF ALL SYSTEMS AND EQUIPMENT FURNISHED OR INSTALLED UNDER THIS CONTRACT.
- 0.22 O & M MANUALS: FOUR COPIES OF OPERATION AND MAINTENANCE MANUAL SHALL BE PROVIDED TO THE BUILDING OWNER OR OPERATOR. THE MANUAL SHALL INCLUDE BASIC DATA RELATING TO THE OPERATION AND MAINTENANCE OF HVAC SYSTEMS AND EQUIPMENT. REQUIRED ROUTINE MAINTENANCE ACTIONS SHALL BE CLEARLY IDENTIFIED. WHERE APPLICABLE, HVAC CONTROLS INFORMATION SUCH AS DIAGRAMS, SCHEMATICS, CONTROL SEQUENCE DESCRIPTIONS, AND MAINTENANCE AND CALIBRATION INFORMATION SHALL BE INCLUDED.
- WARRANTY: UNCONDITIONALLY WARRANT ALL WORK TO BE FREE OF DEFECTS IN MATERIALS AND WORKMANSHIP FOR ONE YEAR FROM DATE OF FINAL ACCEPTANCE, EXCEPT WARRANT AIR CONDITIONING COMPRESSORS FOR FIVE YEARS AND GAS-FIRED HEAT EXCHANGERS FOR TEN YEARS. DURING WARRANTY PERIOD, REPAIR OR REPLACE DEFECTIVE MATERIALS, EQUIPMENT OR WORKMANSHIP WITHOUT COST TO TENANT.
- EQUIPMENT IDENTIFICATION: IDENTIFY ALL APPLICABLE ROOFTOP EQUIPMENT WITH TENANT'S NAME AND SPACE NUMBER, USING 2" PAINTED CHARACTERS OR STAMPED METAL TAG.
- 0.25 DRAWINGS ARE DIAGRAMMATIC: VERIFY ALL DIMENSIONS AND LENGTHS, AND ADJUST EQUIPMENT, PIPE AND DUCT LOCATIONS TO AVOID CONFLICTS WITH OTHER CONSTRUCTION AND TRADES.

- 0.26 DOCUMENT PRIORITY: DRAWING INDICATIONS AND NOTATIONS SUPERSEDE THESE SPECIFICATIONS.
- 0.27 RATINGS: REFER TO DRAWINGS AND SCHEDULES FOR ADDITIONAL RATINGS AND REQUIREMENTS.
- 0.28 PROJECT REQUIREMENTS: REFER TO DRAWINGS FOR PARTICULAR PROJECT REQUIREMENTS, AS NOT ALL ITEMS INCLUDED IN THESE SPECIFICATIONS MAY BE REQUIRED FOR THIS PROJECT.
- 0.29 DOCUMENT ERRORS: NOTIFY THE ENGINEER OF ERRORS, DISCREPANCIES OR OMISSIONS BEFORE CONSTRUCTION OR FABRICATION OF AFFECTED WORK, OR, FAILING OF SUCH NOTICE, BE RESPONSIBLE FOR CORRECTING SAME WITHOUT COST TO THE OWNER, ARCHITECT OR ENGINEER.
- 1.00 PIPE AND FITTINGS
- 1.10 PIPE HANGERS AND SUPPORTS: PROPERLY SUPPORT ALL PIPING FROM JOISTS (TOP CHORD) OR OTHER STRUCTURAL MEMBERS. FOR PIPES UP TO 4" O.D., USE GRINNELL FIG. 260 CLEVIS HANGERS WITH 3/8" ROD, OR FIG. 195 BRACKETS.
- 1.20 INSULATION SHIELDS: PROVIDE 18 GAUGE X 12" LONG GALVANIZED INSULATION SHIELDS AT SUPPORT POINTS FOR INSULATED PIPES.
- 1.30 PIPE SUPPORT SPACING: SUPPORT PIPE NOT LESS THAN 6 FT. ON CENTER FOR COPPER PIPE UP TO 2" O.D., OR NOT LESS THAN 10 FT. ON CENTER FOR STEEL PIPE UP TO 4" O.D.
- 1.40 COPPER CONTACT: PROVIDE COPPER PLATED HANGERS AND SUPPORTS WHERE IN CONTACT WITH COPPER PIPE.
- 1.50 PIPE SLEEVES: SLEEVE ALL HORIZONTAL PIPING WHICH PENETRATES WALLS WITH STANDARD WEIGHT STEEL PIPE OF 1" GREATER DIAMETER THAN PIPE OR INSULATION O.D. CUT SLEEVE FLUSH WITH WALL FINISH
- 1.60 SEALANT: SEAL PIPE SLEEVES WITH ROPE AND EXPANDO NON-SHRINK SEALANT. FIRE/SMOKE SEAL PENETRATIONS OF RATED CONSTRUCTION TO MAINTAIN RATING.
- 1.70 WALL PLATES: FIT UNCOVERED PIPE PASSING THROUGH WALLS WITH WALL PLATES, CRANE NO. 10 OR EQUAL.
- 2.00 THERMAL AND ACOUSTIC INSULATION
- 2.10 VIBRATION ISOLATION: PROVIDE EFFECTIVE VIBRATION ISOLATION DEVICES, AND FLEXIBLE CONNECTIONS, FOR ALL MOVING MACHINERY. PROVIDE DEVICES IN ACCORDANCE WITH THE RECOMMENDATIONS IN THE ASHRAE HANDBOOK, HVAC APPLICATIONS (LATEST EDITION), CHAPTER "NOISE AND VIBRATION
- 2.20 NOISE TRANSMISSION: INSTALL PIPING FREE FROM CONTACT WITH STRUCTURE OR EQUIPMENT TO PREVENT NOISE TRANSMISSION.
- 2.30 INSULATION REQUIREMENTS: INSULATE SYSTEMS AS SPECIFIED ONLY AFTER THEY HAVE BEEN TESTED AND INSPECTED. CLEAN ALL SURFACES THOROUGHLY OF MOISTURE, FOREIGN MATERIAL, GREASE, AND RUST. INSTALL INSULATION CONTINUOUS THROUGH PENETRATIONS.
- 2.31 INSULATION HAZARDS: USE ONLY INSULATION ADHESIVES, SEALERS, AND COATINGS WITH FIRE HAZARD RATING NOT TO EXCEED 25/50/50 FLAME SPREAD, FUEL CONTRIBUTED, AND SMOKE DEVELOPED, IN ACCORDANCE WITH UL 723 AND ASTM E84.
- 2.32 INSULATED PLUMBING SYSTEMS: INSULATE HOT- AND COLD-WATER PIPING, AND HORIZONTAL WASTE PIPING IN CEILING SPACE, WITH 1-IN. THICK CLOSED CELL, SELF SEALING FLEXIBLE TUBING, ARMAFLEX 2000 OR EQUAL.
- 4.00 PLUMBING
- 4.10 DOMESTIC (POTABLE) WATER SUPPLY PIPING: ABOVE GROUND: TYPE L HARD TEMPER COPPER TUBE PER ASTM B88. WITH WROUGHT COPPER FITTINGS PER USASI B16.18. BELOW GROUND: TYPE K SOFT TEMPER COPPER TUBE. USE ONLY 95/5 LEAD-FREE SOLDER IN POTABLE WATER PIPING. PROVIDE DIELECTRIC UNIONS AT EVERY JUNCTION OF TWO DISSIMILAR METAL PIPE MATERIALS.
- 4.20 DRAIN, WASTE AND VENT PIPING: ABOVE GRADE: NO-HUB CAST IRON SANITARY SYSTEM PER CISPI 301-69T WITH CAST IRON DRAINAGE FITTINGS. BELOW GRADE: NO-HUB CAST IRON SANITARY SYSTEM PER CISPI 301-69T OR SERVICE WEIGHT CAST IRON HUB AND SPIGOT WITH

NEOPRENE GASKET, PER CISPI HSN-68T.

- 4.30 NATURAL GAS PIPING UNDERGROUND WITHIN 5 FEET OF BUILDING: SCHEDULE 40 SEAMLESS BLACK STEEL ASTM A53 OR A120 WITH OUTSIDE PROTECTIVE PLASTIC COATING OF POLYETHYLENE, PVC OR EQUAL OF A 10 MIL OR GREATER THICKNESS. FITTINGS SHALL BE ASTM A234, FORGED STEEL WELDING TYPE, WITH AWWA C105 POLYETHYLENE JACKET OR DOUBLE LAYER, HALF-LAPPED 10 MIL POLYETHYLENE TAPE. JOINTS SHALL BE WELDED AND FIELD-WRAPPED WITH AN APPROVED PROTECTIVE PLASTIC COATING EQUAL TO TAPECOAT CT10, OR 3M #50
- 4.40 VALVES: FURNISH AND INSTALL VALVES WHERE INDICATED ON PLAN AND AS NECESSARY FOR PROPER SYSTEM OPERATION AND COMPONENT ISOLATION. PROVIDE VALVES RATED FOR 125 PSI OR GREATER WORKING PRESSURE IN WATER PIPING.

CHECK VALVE UP TO 3" GLOBE VALVE UP TO 3" GATE VALVE UP TO 3" BALL VALVE UP TO 3"

CRANE NO. 428, 1334, OR EQUAL APOLLO SERIES 70-100, 70-200, OR

TEMP. & PRESS. RELIEF VALVE WATTS 10L MODEL M7, OR EQUAL, 3/4"M X 3/4" F

CRANE NO. 37, OR EQUAL

CRANE NO. 1, 17TF, OR EQUAL

- 4.70 PLUMBING FIXTURES AND EQUIPMENT: FURNISH AND INSTALL COMPLETE WITH FITTINGS AND ACCESSORIES AS REQUIRED, SEE PLANS FOR DESCRIPTION.
- 4.95 CLEANING AND TESTING: CLEAN, DISINFECT, AND TEST ALL PLUMBING AND PIPING SYSTEMS, PER CODE REQUIREMENT.

APPLICABLE CODES & STANDARDS | PLUMBING NOTES

2019 CALIFORNIA BUILDING CODE WITH STATEWIDE AMENDMENTS

• 2019 CALIFORNIA PLUMBING CODE WITH STATEWIDE AMENDMENTS

- 2019 CALIFORNIA MECHANICAL CODE WITH STATEWIDE AMENDMENTS
- ICC/ANSI A117.1-09, ACCESSIBLE AND USABLE BUILDINGS AND FACILITIES, WITH
- STATEWIDE AMENDMENTS.
- 2019 CALIFORNIA ENERGY CONSERVATION CODE
- 2019 CALIFORNIA GREEN BUILDING STANDARDS
- NFPA 90A
- UNDERWRITERS LABORATORIES (OR ETL)

HANGERS AND SUPPORTS

MATERIALS	TYPE OF JOINTS	HORIZONTAL	VERTICAL
CAST-IRON HUBLESS	SHIELDED COUPLING	EVERY OTHER JOINT, UNLESS OVER 4 FEET THEN SUPPORT EACH JOINT	BASE AND EACH FLOOR, NOT TO EXCEED 15 FEET
COPPER & COPPER ALLOYS	SWEATED CONN. WITH LEAD-FREE SOLDER	1 1/2 INCHES AND SMALLER, 6 FEET; 2 INCHES AND LARGER, 10 FEET	EACH FLOOR, NOT TO EXCEED 10 FEET ⁵
STEEL PIPE FOR GAS	THREADED OR WELDED	1/2 INCH, 6 FEET; 3/4 INCH AND 1 INCH, 8 FEET; 1 1/4 INCHES & LARGER, 10 FEET	1/2 INCH, 6 FEET; 3/4 INCH AND 1 INCH, 8 FEET; 1 1/4 INCHES EVERY FLOOR LEVEL
SCHEDULE 40 PVC & ABS DWV	SOLVENT CEMENTED	ALL SIZES, 4 FEET; ALLOW FOR EXPENSION EVERY 30 FEET ³	BASE AND EACH FLOOR; PROVIDE MID-STORY GUIDES; PROVIDE FOR EXPANSION EVERY 30 FEET

- 1. CAST IRON HUBLESS SUPPORT ADJACENT TO JOINT, NOT TO EXCEED 18 INCHES.
- 2. BRACE NOT TO EXCEED 40 FOOT INTERVALS TO PREVENT HORIZONTAL MOVEMENT
- 3. SUPPORT AT EACH HORIZONTAL BRANCH CONNECTION.
- 4. HANGERS SHALL NOT BE PLACED ON THE COUPLING.
- 5. VERTICAL WATER LINES SHALL BE PERMITTED TO BE SUPPORTED IN ACCORDANCE WITH RECOGNIZED ENGINEERING PRINCIPLES WITH REGARD TO EXPANSION AND CONTRACTION, WHERE FIRST APPROVED BY THE AUTHORITY HAVING JURISDICTION.

A.D.A. COMPLIANCE NOTES

- 1. INSULATE EXPOSED HOT WATER AND WASTE PIPING WITH NEATLY PRE-FORMED INSULATION COVERS BY McGUIRE "PROWRAP", OR EQUAL.
- 2. FIXTURE MOUNTING HEIGHTS FOR THE PHYSICALLY DISABLED SHALL CONFORM TO THE AMERICANS WITH DISABILITIES ACT AND OTHER AUTHORITIES HAVING JURISDICTION.

PLUMBING FIXTURE NOTES

- ALL FIXTURES, EQUIPMENT, PIPING, FITTINGS AND MATERIALS SHALL BE LISTED
- 2. ALL PLUMBING FIXTURES SHALL MEET THE FLOW REQUIREMENTS SPECIFIED IN THE APPLICABLE CODES & STANDARDS LISTED ON THIS SHEET.
- 3. PUBLIC LAVATORIES SHALL HAVE CONTROLS TO LIMIT THE WATER TEMPERATURE
- 4. WATER PIPE AND FITTINGS WITH A LEAD CONTENT WHICH EXCEEDS 0.25% SHALL BE PROHIBITED IN SYSTEMS CONVEYING POTABLE WATER.

REGULATORY NOTES

- FIRE RESISTIVE BUILDING MATERIALS
- A. INSULATION MATERIALS INSTALLED IN BUILDINGS OF ANY TYPE OF CONSTRUCTION, SHALL HAVE A FLAME-SPREAD RATING OF NOT MORE THAN 25 AND A SMOKE-DEVELOPED INDEX OF NOT MORE THAN 50 IN ACCORDANCE WITH APPLICABLE CODES LISTED ON THIS SHEET OR ON THE PROJECT COVER SHEET.
- B. INSULATION, INSULATION JACKET, ADHESIVES, TAPES, ETC. SHALL BE APPLIED PER MANUFACTURERS WRITTEN INSTALLATION INSTRUCTIONS.

- ALL NOTES, INSTRUCTIONS, DIRECTIVES AND REQUIREMENTS NOTED IN THESE DRAWINGS ARE THE RESPONSIBILITY OF THE GENERAL CONTRACTOR. IN THE ABSENCE OF A GENERAL CONTRACTOR ASSOCIATED WITH THE PROJECT, SAID NOTES, INSTRUCTIONS, DIRECTIVES AND REQUIREMENTS SHALL BECOME THE RESPONSIBILITY OF THE PLUMBING CONTRACTOR.
- ALL EQUIPMENT, DEVICES AND PIPING SHOWN ON THESE DRAWINGS IS NEW UNLESS SPECIFICALLY CALLED OUT AS EXISTING (E) TO REMAIN.
- FOR THE PURPOSE OF CLEARNESS AND LEGIBILITY, THE DRAWINGS ARE ESSENTIALLY DIAGRAMMATIC AND ALTHOUGH SIZES AND LOCATIONS OF EQUIPMENT ARE DRAWN TO SCALE WHEREVER POSSIBLE, THE CONTRACTOR SHALL MAKE USE OF ALL DATA IN THE CONTRACT DOCUMENTS AND VERIFY THIS INFORMATION PRIOR TO ORDERING, FABRICATING OR INSTALLING ANY MATERIALS.
- CONTRACTOR SHALL COORDINATE WORK SHOWN ON THESE DRAWINGS AND SPECIFICATIONS WITH ALL OTHER DISCIPLINES AND TRADES PRIOR TO SUBMITTAL OF BID AND INSTALLATION OF SYSTEM.
- THE PLUMBING CONTRACTOR SHALL GUARANTEE MATERIALS & LABOR (INCLUDING THE COMPLETE PLUMBING SYSTEM) FOR A PERIOD OF ONE YEAR FROM WRITTEN ACCEPTANCE BY THE OWNER. DEFECTS IN MATERIALS AND / OR LABOR FOUND WITHIN THE GUARANTEE PERIOD SHALL BE REMEDIED OR REPAIRED BY THIS CONTRACTOR IN A TIMELY FASHION, AND AT NO COST TO THE OWNER.
- PLUMBING FIXTURE LOCATIONS (WATER CLOSETS, LAVATORIES ETC.) ARE DIAGRAMMATIC. REFER TO ARCHITECTURAL DRAWINGS FOR ADA COMPLIANT FIXTURES, EXACT LOCATIONS, MOUNTING HEIGHTS & COLORS.
- DEVIATIONS FROM THE DRAWINGS OR SPECIFICATIONS SHALL BE BROUGHT TO THE ATTENTION OF THE ARCHITECT AND ENGINEER PRIOR TO INSTALLATION.
- CONTRACTOR SHALL VISIT SITE PRIOR TO SUBMITTAL OF BID AND FAMILIARIZE HIMSELF WITH EXISTING CONDITIONS. SUBMITTAL OF BID WILL BE TAKEN AS CONFIRMATION THAT THE CONTRACTOR HAS VISITED THE SITE.
- PIPING SHALL BE INSTALLED PARALLEL TO BUILDING LINES AND SUPPORTED AND ANCHORED AS REQUIRED TO FACILITATE EXPANSION AND CONTRACTION. THE INSTALLATION SHALL MEET ALL CONSTRUCTION CONDITIONS AND ALLOW FOR THE INSTALLATION OF OTHER TRADES.
- WATER HAMMER ARRESTORS AND TRAP PRIMERS FOR FLOOR DRAINS AND FLOOR SINKS TO BE INSTALLED AS PER THE LISTED PLUMBING CODE AND THE LATEST EDITION OF THE AMERICAN SOCIETY OF SANITARY ENGINEERING (ASSE 1010) SIZING AND INSTALLATION REQUIREMENTS.
- 11. VALVES, TRAP PRIMERS, WATER HAMMER ARRESTORS OR OTHER EQUIPMENT SHOWN IN WALLS OR ABOVE NON-ACCESSIBLE CEILINGS SHALL BE INSTALLED BEHIND AN ACCESS PANEL. LABEL ACCESS PANELS WITH NAME OF DEVICE CONCEALED IN WALL OR ABOVE CEILING.
- 12. SERVICE WATER HEATING EQUIPMENT TO BE IN COMPLIANCE WITH THE STATE ENERGY CODE AND 2018 IECC REQUIREMENTS AND LABELED AS SUCH.
- 13. ITEMS PROJECTING THROUGH THE ROOF SHALL BE FLASHED THROUGH CURBS OR PIPE SEALS A MINIMUM OF 12" ABOVE THE ROOF. THE PIPE CURBS AND SEALS SHALL BE INSTALLED BY THE ROOFING CONTRACTOR. ENSURE THAT AMPLE BOOT OPENINGS ARE PROVIDED TO ACCOMMODATE ANY ELECTRICAL CONDUIT PENETRATIONS REQUIRED FOR POWER.
- REFER TO PLUMBING FIXTURE SCHEDULE FOR INDIVIDUAL WASTE, VENT & WATER CONNECTION SIZES AT EACH PLUMBING FIXTURE.
- 15. CLEANOUTS SHALL BE INSTALLED WHERE READILY ACCESSIBLE AND LOCATED AS PER CODE REQUIREMENTS. COORDINATE CLEAN-OUT LOCATIONS WITH EQUIPMENT, MILLWORK, ETC., PRIOR TO INSTALLATION.
- PLUMBING FIXTURE VENTS TO TERMINATE A MINIMUM OF 12 INCHES FROM ANY VERTICAL SURFACE AND 10'-0" FROM OR 3'-0" ABOVE ANY MECHANICAL EQUIPMENT
- VALVES, UNIONS, ETC. SHALL BE SAME SIZE AS CONNECTED SUPPLY LINE UNLESS OTHERWISE NOTED ON DRAWINGS.
- 18. UNIONS SHALL BE PROVIDED AND INSTALLED AFTER EACH SCREW-TYPE VALVE AND PRIOR TO EQUIPMENT CONNECTIONS.
- UNDERGROUND METALLIC PIPE AND FITTINGS SHALL BE PROTECTED IN ACCORDANCE WITH THE SOILS ENGINEER'S RECOMMENDATIONS, AS APPLICABLE.
- 20. NO PIPING SHALL BE DIRECTLY EMBEDDED IN CONCRETE, MASONRY WALLS, OR CONCRETE FOOTINGS.
- 21. COORDINATE REQUIREMENTS FOR POINTS OF CONNECTION AND OTHER TRADES PRIOR TO START OF WORK.
- 22. VERIFY EXACT LOCATIONS, DEPTH AND SIZE OF ALL PIPING TO WHICH CONNECTIONS ARE REQUIRED. COORDINATE CONNECTIONS WITH SITE CONDITIONS AND SITE UTILITY
- CONTRACTOR/ REPRESENTATIVE. 23. HORIZONTAL PIPING LINES EXTENDED AND CONNECTED TO EQUIPMENT SHALL BE RUN AT THE HIGHEST POSSIBLE ELEVATIONS AND NOT LESS THAN 6" ABOVE THE FLOOR TO

PROVIDE CLEARANCE FOR CLEANING AND PROPER SUPPORT.

- 24. CUTTING OF EXISTING PAVING, WALKS AND/OR FLOORS SHALL UTILIZE MACHINE SAW CUTTING EQUIPMENT. HOLES FOR PIPES IN CONCRETE WALLS OR FLOORS SHALL UTILIZE CORE DRILLING EQUIPMENT, COORDINATE WITH ARCHITECTURAL DETAILS FOR FLOOR CUTTING AND PATCHING.
- 25. PROVIDE ADDITIONAL STEEL, HANGER MATERIALS, RODS AND CLAMPS AS REQUIRED FOR COORDINATION WITH WORK OF OTHER TRADES.
- 26. PIPING LAYOUT IS SCHEMATIC ONLY, EXACT ROUTING AND INSTALLATION OF PIPES TO BE COORDINATED WITH THE BUILDING STRUCTURE AND THE WORK OF OTHER CONTRACTORS.
- NO PLUMBING PIPING SHALL BE INSTALLED ABOVE ELECTRICAL SWITCH GEAR, EQUIPMENT, OR PANELS. MAKE ADJUSTMENTS NECESSARY TO REPOUTE PIPING FOR ACTUAL INSTALLATION OF ELECTRIC EQUIPMENT.
- 28. WHENEVER FOUNDATION WALLS, EXTERIOR WALLS, ROOFS, ETC. ARE PENETRATED FOR THE INSTALLATION OF PLUMBING SYSTEMS, THEY SHALL BE PATCHED TO MATCH EXISTING CONSTRUCTION AND SEALED WEATHER TIGHT. PROVIDE FIREPROOFING, AS REQUIRED PER WALL CONSTRUCTION TYPE.
- 29. PLUMBING CONTRACTOR SHALL BE ON SITE AND PRESENT AT THE DATE OF TURNOVER. 30. EXTERIOR EXPOSED WATER PIPING SHALL BE INSULATED AND PVC JACKETED. SEAL
- JACKET PER MANUFACTURER'S REQUIREMENTS. 31. ALL ATTEMPTS WERE MADE DURING THE DESIGN PERIOD TO GATHER DATA REGARDING DOMESTIC WATER PRESSURE AT THE SITE. HOWEVER, SYSTEM PRESSURE MUST STILL BE VERIFIED ON-SITE AS EARLY AS POSSIBLE TO DETERMINE IF BOOSTER

PUMPS ARE REQUIRED.

PLUMBING LEGEND

SYMBOL	ABBREVIATION	DESCRIPTION	
— GW ——	GW	GRAY WATER SEWER	
	SS	SANITARY SEWER	-
	SS	(EXPOSED) SANITARY SEWER	
	V	SANITARY VENT ABOVE GROUND	
— – UV — — —	UV	SANITARY VENT BELOW GROUND	
— - GV — — —	GV	GREASE VENT BELOW GRADE	
	CW	DOMESTIC COLD WATER	
	HW	DOMESTIC HOT WATER	INA
	HWR	DOMESTIC HOT WATER RETURN	ENGINEERII
G	G	LOW PRESSURE GAS	30 THOMAS PHONE: (949)
MPG	MPG	medium pressure gas	STAMP:
—— HPG ———	HPG	HIGH PRESSURE GAS	
CD	CD	CONDENSATE DRAIN	
SD	SD	STORM DRAIN	REG1572
OD	OD	OVERFLOW STORM DRAIN	
CA	CA	COMPRESSED AIR	
	VTR	VENT THRU ROOF	
<u></u>	AAV	AIR ADMITTANCE VALVE	COPYRIGHT:
	PRV	PRESSURE REDUCING VALVE	C O P Y R COPYRIGHT
	SOV	SHUT-OFF VALVE	ENGINEERING DATE OF ISSU DUPLICATION
<u> </u>	BV	BALL VALVE	BUILT-WORK PROHIBITED V
<u> </u>	CV	CHECK VALVE	CONSENT N
	U	UNION	CLIENT.
T	WHA	WATER HAMMER ARRESTER WITH ACCESS PANEL	CLIENT:
	TP	TRAP PRIMER WITH ACCESS PANEL	JAI
-0-		PIPE UP	OF C
-\$-		PIPE DOWN	1050 S.
<u> </u>		ELBOW UP	LOS
C—		ELBOW DOWN	1
-	A	CVPC TO PEX PIPE MATERIAL TRANSITION	PROJECT:
Ø	FCO OR GCO	FLOOR OR GRADE CLEAN OUT	28.
ØØ	\$CO	2-WAY SERVICE CLEAN OUT	
I—	WCO	WALL CLEAN OUT	LOS AN
+	НВ	HOSE BIBB	1
<u> </u>		CAPPED PIPE	1
•	POC	POINT OF CONNECTION	
<u> </u>	POD	POINT OF DISCONNECT	# DE
	B.F.F.	BELOW FINISHED FLOOR	UTILITY (
	B.F.G.	BELOW FINISHED GRADE	A PC F
	FD-X	FLOOR DRAIN	PC F
	FS-X	FLOOR SINK, GRATE PER PLAN	HC A
	AP	ACCESS PANEL	PC
	FFE	FINISHED FLOOR ELEVATION	A HCD
	IE	INVERT ELEVATION	A PC
	FU	FIXTURE UNIT	& CLIE
	VBF	VENT BELOW FLOOR	CLIE
	TMV	THERMOSTATIC MIXING VALVE	PC RES
	GPF	GALLONS PER FLUSH	CLIE
	S.F.	SQUARE FEET	1 🖴
	U.O.N.	unless otherwise noted	Plot Date:
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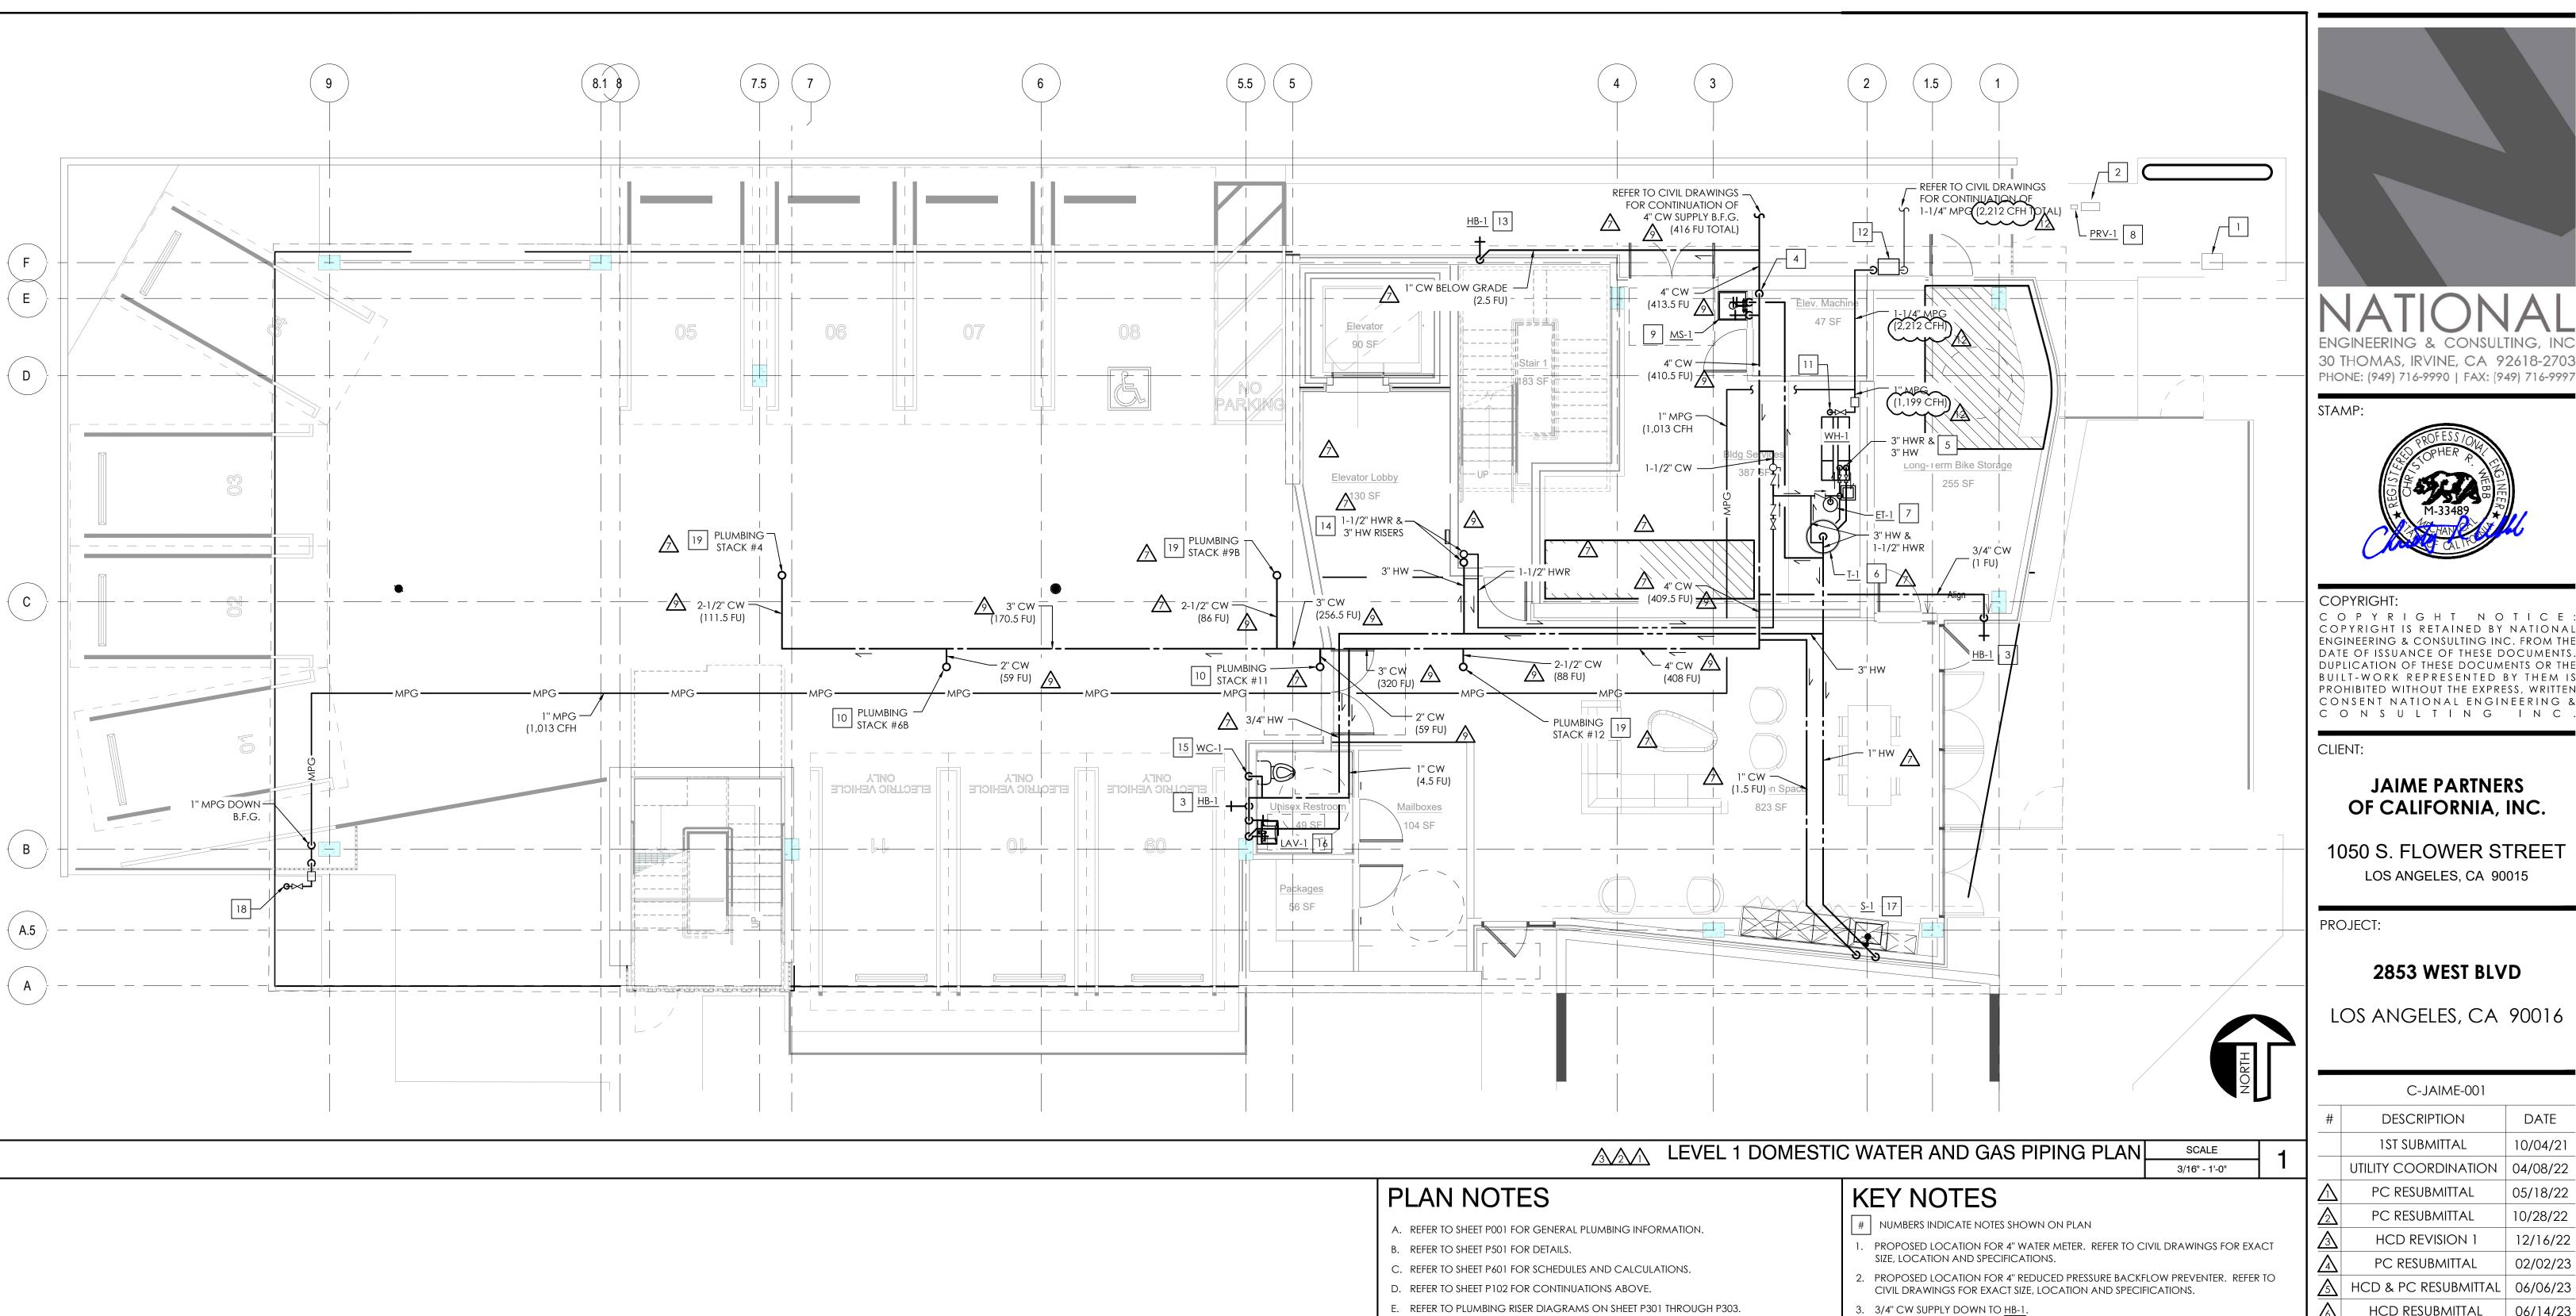
1050 S. FLOWER STREET LOS ANGELES, CA 90015

2853 WEST BLVD

LOS ANGELES, CA 90016

	C-JAIME-001	
#	DESCRIPTION	DATE
	1ST SUBMITTAL	10/04/21
	UTILITY COORDINATION	04/08/22
$\overline{\Lambda}$	PC RESUBMITTAL	05/18/22
2	PC RESUBMITTAL	10/28/22
3	HCD REVISION 1	12/16/22
4	PC RESUBMITTAL	02/02/23
<u></u>	HCD & PC RESUBMITTAL	06/06/23
	HCD RESUBMITTAL	06/14/23
$\overline{\mathbb{A}}$	PC RESUBMITTAL	07/10/23
8	CLIENT REVISIONS	07/11/23
	CLIENT REVISIONS	08/04/23
10	PC RESUBMITTAL (ELEC)	09/12/23
$\overline{\mathbb{A}}$	PC RESUBMITTAL (ELEC)	10/05/23
<u>13</u>	CLIENT REVISIONS	10/12/23
Plot	Date: 10/11/2023	4:58:28 PM

PLUMBING **GENERAL** INFORMATION



- F. COORDINATE WITH UTILITY PROVIDERS FOR ALL NECESSARY ADJUSTMENTS, INSPECTIONS
- AND INSTALLATIONS. G. \triangleright MEDIUM PRESSURE GAS PIPING SIZED AT INLET PRESSURE OF 2 PSI AND MAX LENGTH OF . 175 FT TO FURTHEST GAS APPLIANCE, PER CPC TABLE 1215.2(4).
- H. MAINTAIN EQUIPMENT CLEARANCE PER MANUFACTURER'S GUIDELINES.
- I. INSTALL ALL HOSE BIBBS 18" CLEAR ABOVE FLOOR U.O.N.
- 4. 3" CW MAIN SUPPLY UP ALONG WALL AS SHOWN. EXTEND HORIZONTALLY TIGHT TO 3 UNDERSIDE OF PODIUM.
- 5. 3" HW AND 3" HWR DOWN TO CIRCULATING WATER HEATER. REFER TO MANUFACTURER'S GUIDELINES FOR PROPER INSTALLATION. SEE PIPING DETAIL ON
- 6. HOT WATER STORAGE TANK. SEE PIPING DETAIL ON 9/P501.
- 7. PROVIDE EXPANSION TANK <u>ET-1</u> FOR CENTRAL HOT WATER SYSTEM.
- 8. PROVIDE PRV DOWNSTREAM OF REDUCED PRESSURE BACKFLOW PREVENTER. SET TO
- 9. 1" H&CW DOWN FOR MS-1.
- 10. 2" CW RISER TO SERVE UPPER LEVELS. REFER TO SHEET P102 FOR CONTINUATION.
- 11. 1" MPG DOWN TO SUPPLY WH-1. PROVIDE WITH LOW-PRESSURE GAS REGULATOR AND
- 12. PROPOSED LOCATION FOR 1-1/4" MEDIUM-PRESSURE GAS METER (2 PSIG). COORDINATE EXACT SIZE, LOCATION, ROUTING AND PRESSURE WITH GAS UTILITY PROVIDER AND SITE CONDITIONS.
- 13. 1" CW BELOW GRADE UP TO SERVE HB-1.
- 14. 3" HW & 1-1/2" HWR RISERS SERVE ALL UPPER LEVEL FLOORS.
- 15. 1" CW DOWN TO WATER CLOSET.
- 16. 3/4" H&CW DOWN TO LAVATORY.
- 17. 1" H&CW DOWN TO HAND SINK.
- 18. 1" MPG SUPPLY (1,013 CFH) TO GAS GENERATOR. PROVIDE WITH LOW-PRESSURE GAS REGULATOR AND SOV.
- 19. 2-1/2" CW RISER TO SERVE UPPER LEVELS. REFER TO SHEET P102 FOR CONTINUATION.



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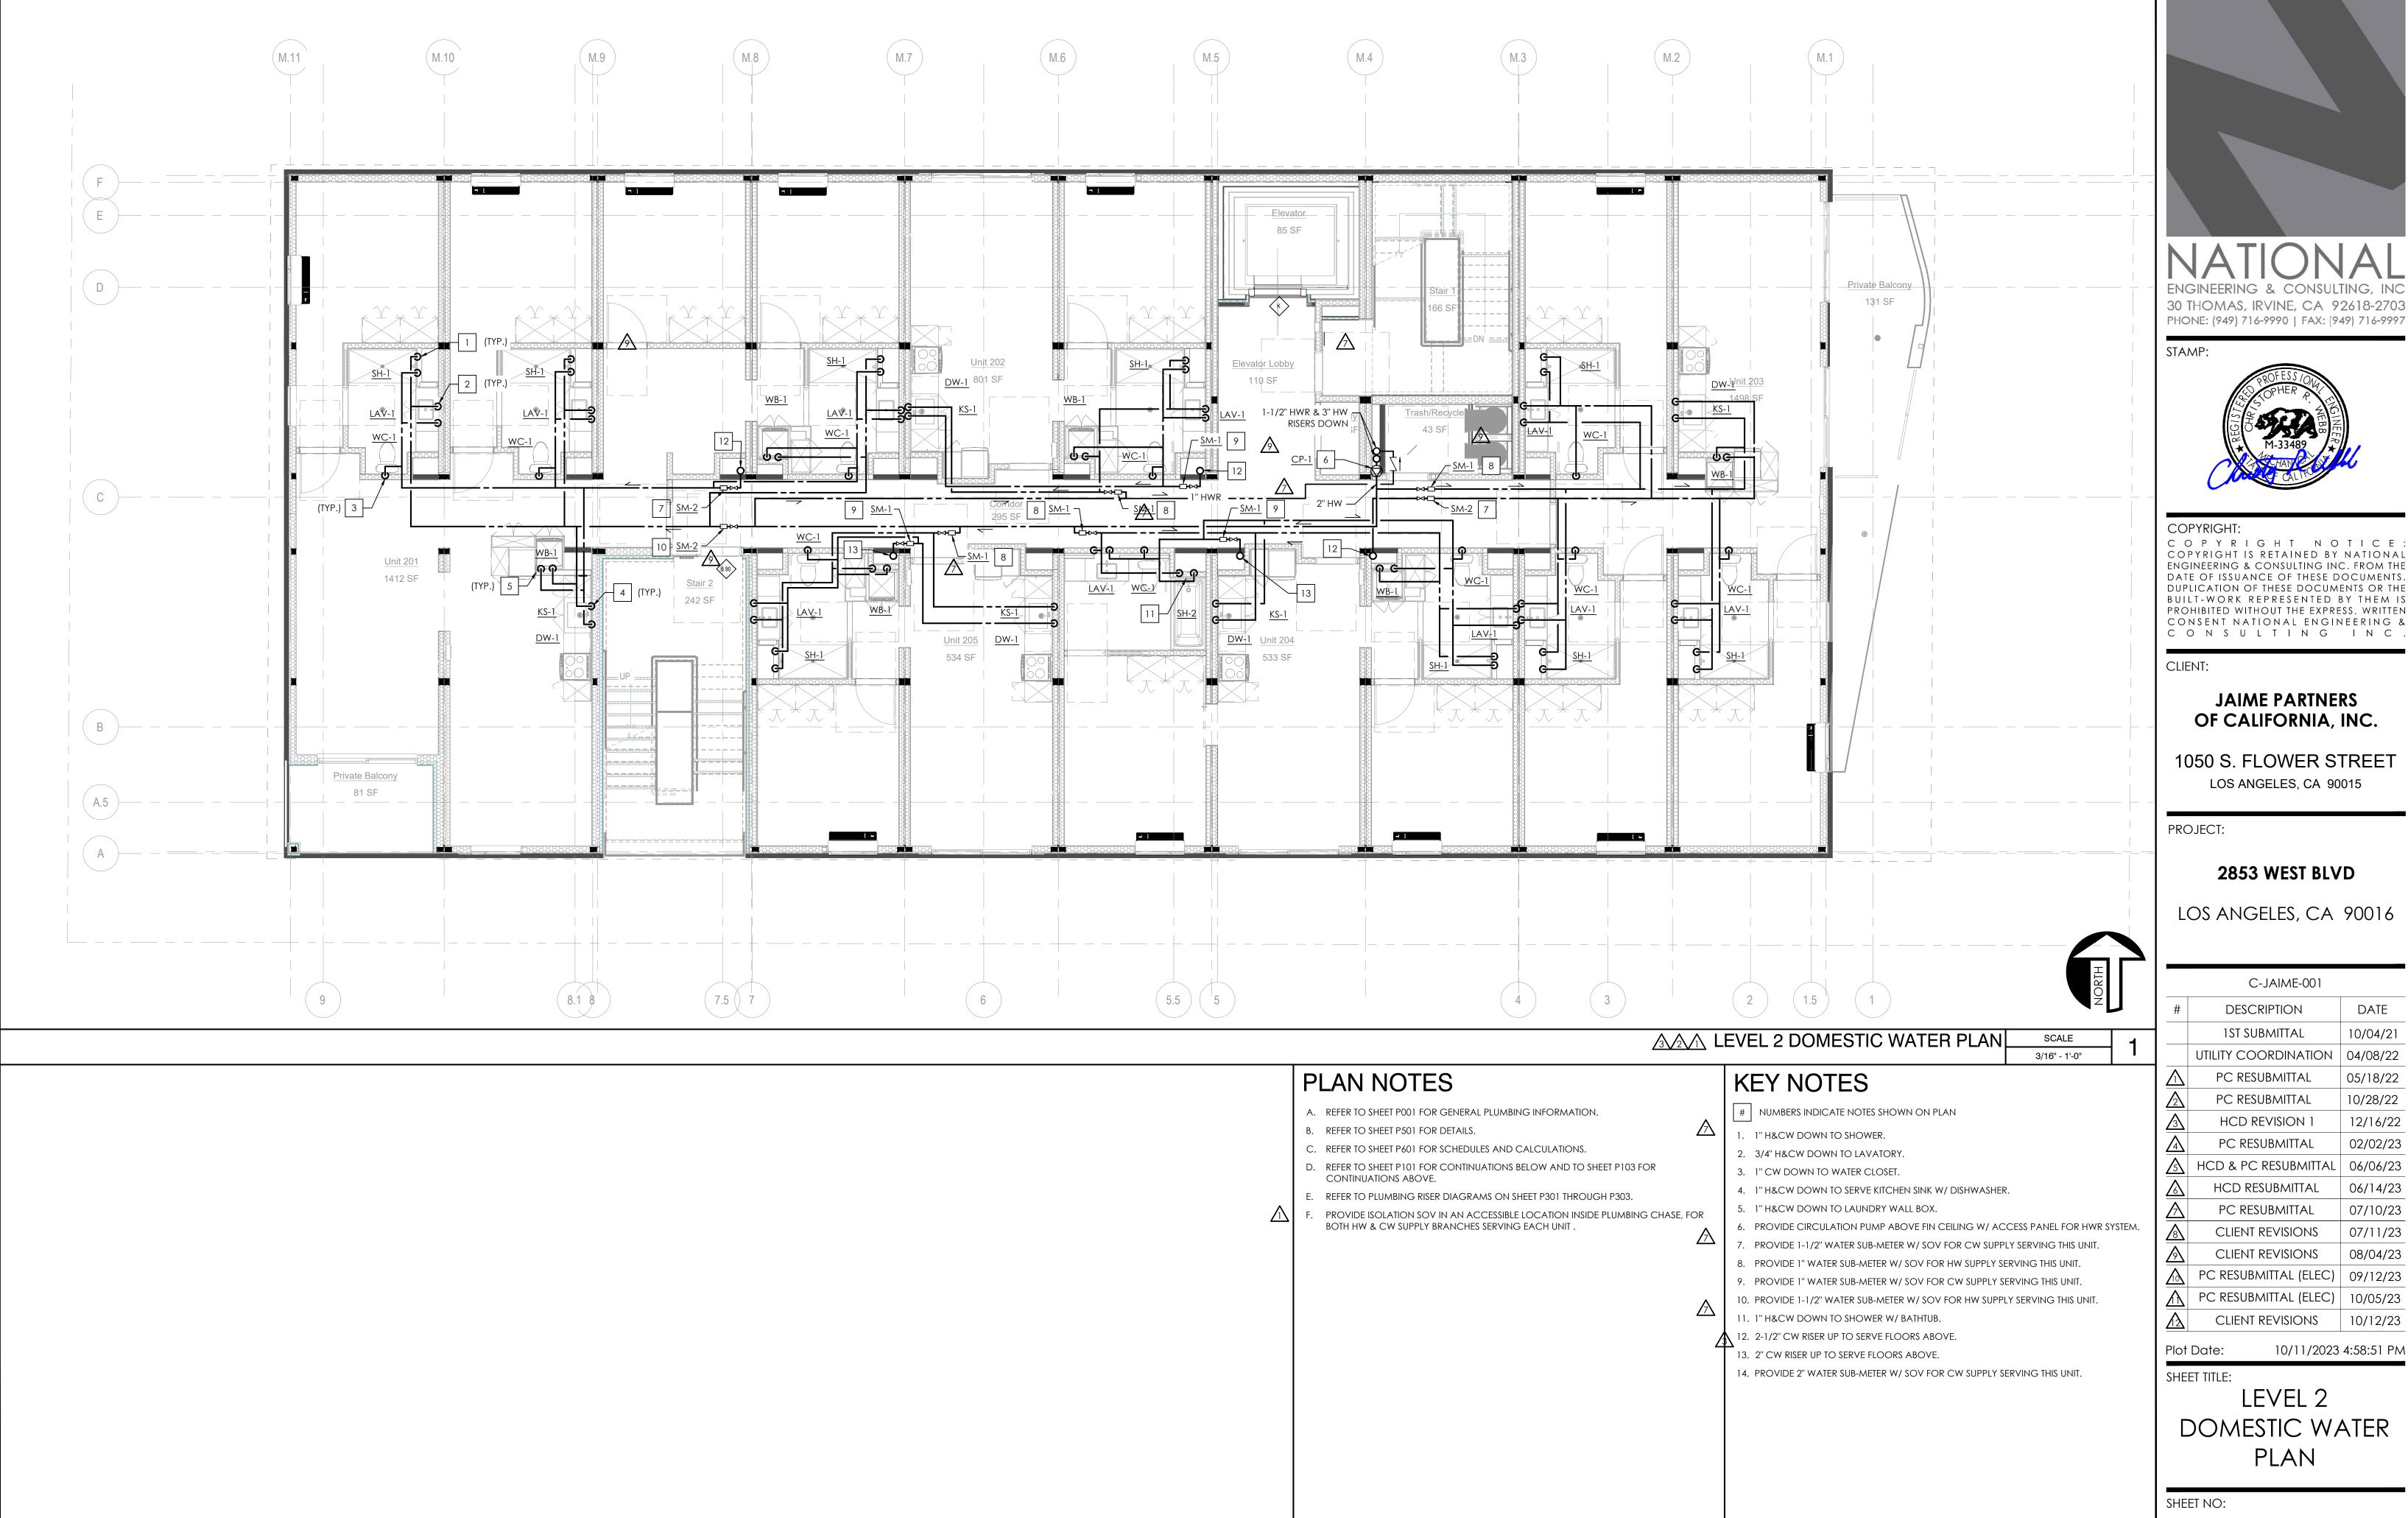
2853 WEST BLVD

LOS ANGELES, CA 90016

DESCRIPTION	
1ST SUBMITTAL	DATE 10/04/21
	04/08/22
PC RESUBMITTAL	05/18/22
PC RESUBMITTAL	10/28/22
HCD REVISION 1	12/16/22
PC RESUBMITTAL	02/02/23
HCD & PC RESUBMITTAL	06/06/23
HCD RESUBMITTAL	06/14/23
PC RESUBMITTAL	07/10/23
CLIENT REVISIONS	07/11/23
CLIENT REVISIONS	08/04/23
PC RESUBMITTAL (ELEC)	09/12/23
PC RESUBMITTAL (ELEC)	10/05/23
CLIENT REVISIONS	10/12/23
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SHEET TITLE:

LEVEL 1 DOMESTIC WATER & GAS PIPING PLAN



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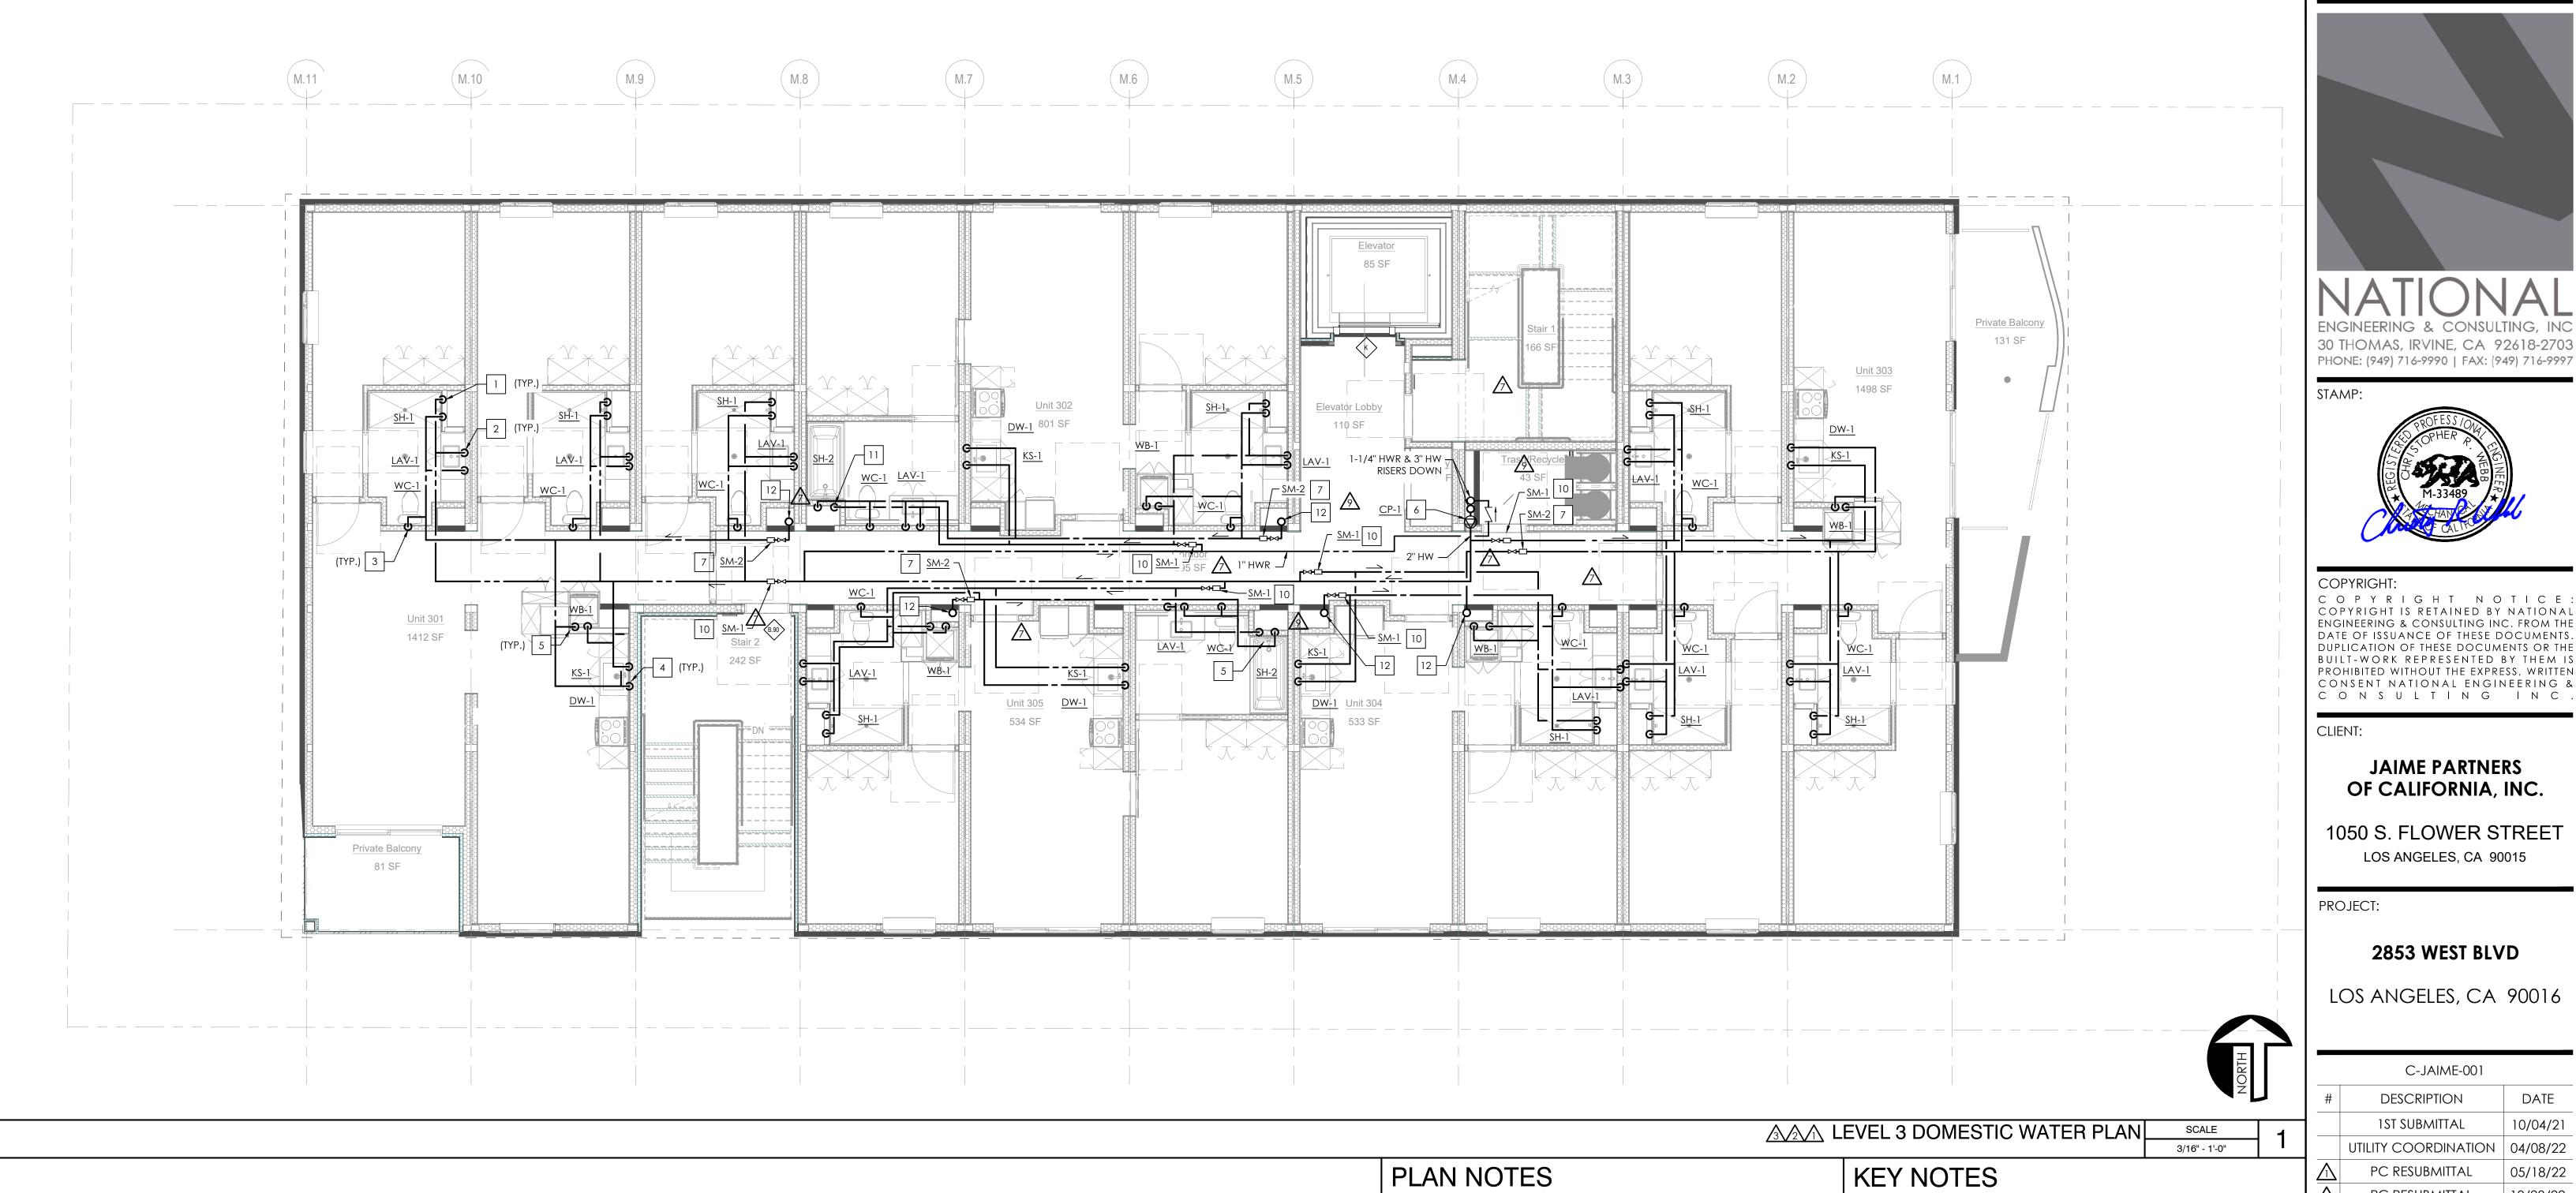
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#	DESCRIPTION	DATE
	1ST SUBMITTAL	10/04/21
	UTILITY COORDINATION	04/08/22
$\overline{\Lambda}$	PC RESUBMITTAL	05/18/22
2	PC RESUBMITTAL	10/28/22
3	HCD REVISION 1	12/16/22
4	PC RESUBMITTAL	02/02/23
<u></u>	HCD & PC RESUBMITTAL	06/06/23
<u></u>	HCD RESUBMITTAL	06/14/23
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8	CLIENT REVISIONS	07/11/23
$\overline{\mathbb{A}}$	CLIENT REVISIONS	08/04/23
10	PC RESUBMITTAL (ELEC)	09/12/23
$\overline{\mathbb{A}}$	PC RESUBMITTAL (ELEC)	10/05/23
<u> </u>	CLIENT REVISIONS	10/12/23

LEVEL 2 DOMESTIC WATER



A. REFER TO SHEET P001 FOR GENERAL PLUMBING INFORMATION.

B. REFER TO SHEET P501 FOR DETAILS.

C. REFER TO SHEET P601 FOR SCHEDULES AND CALCULATIONS.

BOTH HW & CW SUPPLY BRANCHES SERVING EACH UNIT .

D. REFER TO SHEET P102 FOR CONTINUATIONS BELOW AND TO SHEET P104 FOR CONTINUATIONS ABOVE.

E. REFER TO PLUMBING RISER DIAGRAMS ON SHEET P301 THROUGH P303.

PROVIDE ISOLATION SOV IN AN ACCESSIBLE LOCATION INSIDE PLUMBING CHASE, FOR

NUMBERS INDICATE NOTES SHOWN ON PLAN

1. 1" H&CW DOWN TO SHOWER.

2. 3/4" H&CW DOWN TO LAVATORY.

3. 1" CW DOWN TO WATER CLOSET. 4. 1" H&CW DOWN TO SERVE KITCHEN SINK W/ DISHWASHER.

5. 1" H&CW DOWN TO LAUNDRY WALL BOX.

6. PROVIDE CIRCULATION PUMP ABOVE FIN CEILING W/ ACCESS PANEL FOR HWR SYSTEM

7. PROVIDE 1-1/2" WATER SUB-METER W/ SOV FOR CW SUPPLY SERVING THIS UNIT.

8. PROVIDE 1-1/2" WATER SUB-METER W/ SOV FOR HW SUPPLY SERVING THIS UNIT.

9. PROVIDE 1" WATER SUB-METER W/ SOV FOR CW SUPPLY SERVING THIS UNIT. 10. PROVIDE 1" WATER SUB-METER W/ SOV FOR HW SUPPLY SERVING THIS UNIT.

11. 1" H&CW DOWN TO SHOWER W/ BATHTUB.

12. 2" CW RISER UP TO SERVE FLOORS ABOVE.

13. PROVIDE 2' WATER SUB-METER W/ SOV FOR CW SUPPLY SERVING THIS UNIT.



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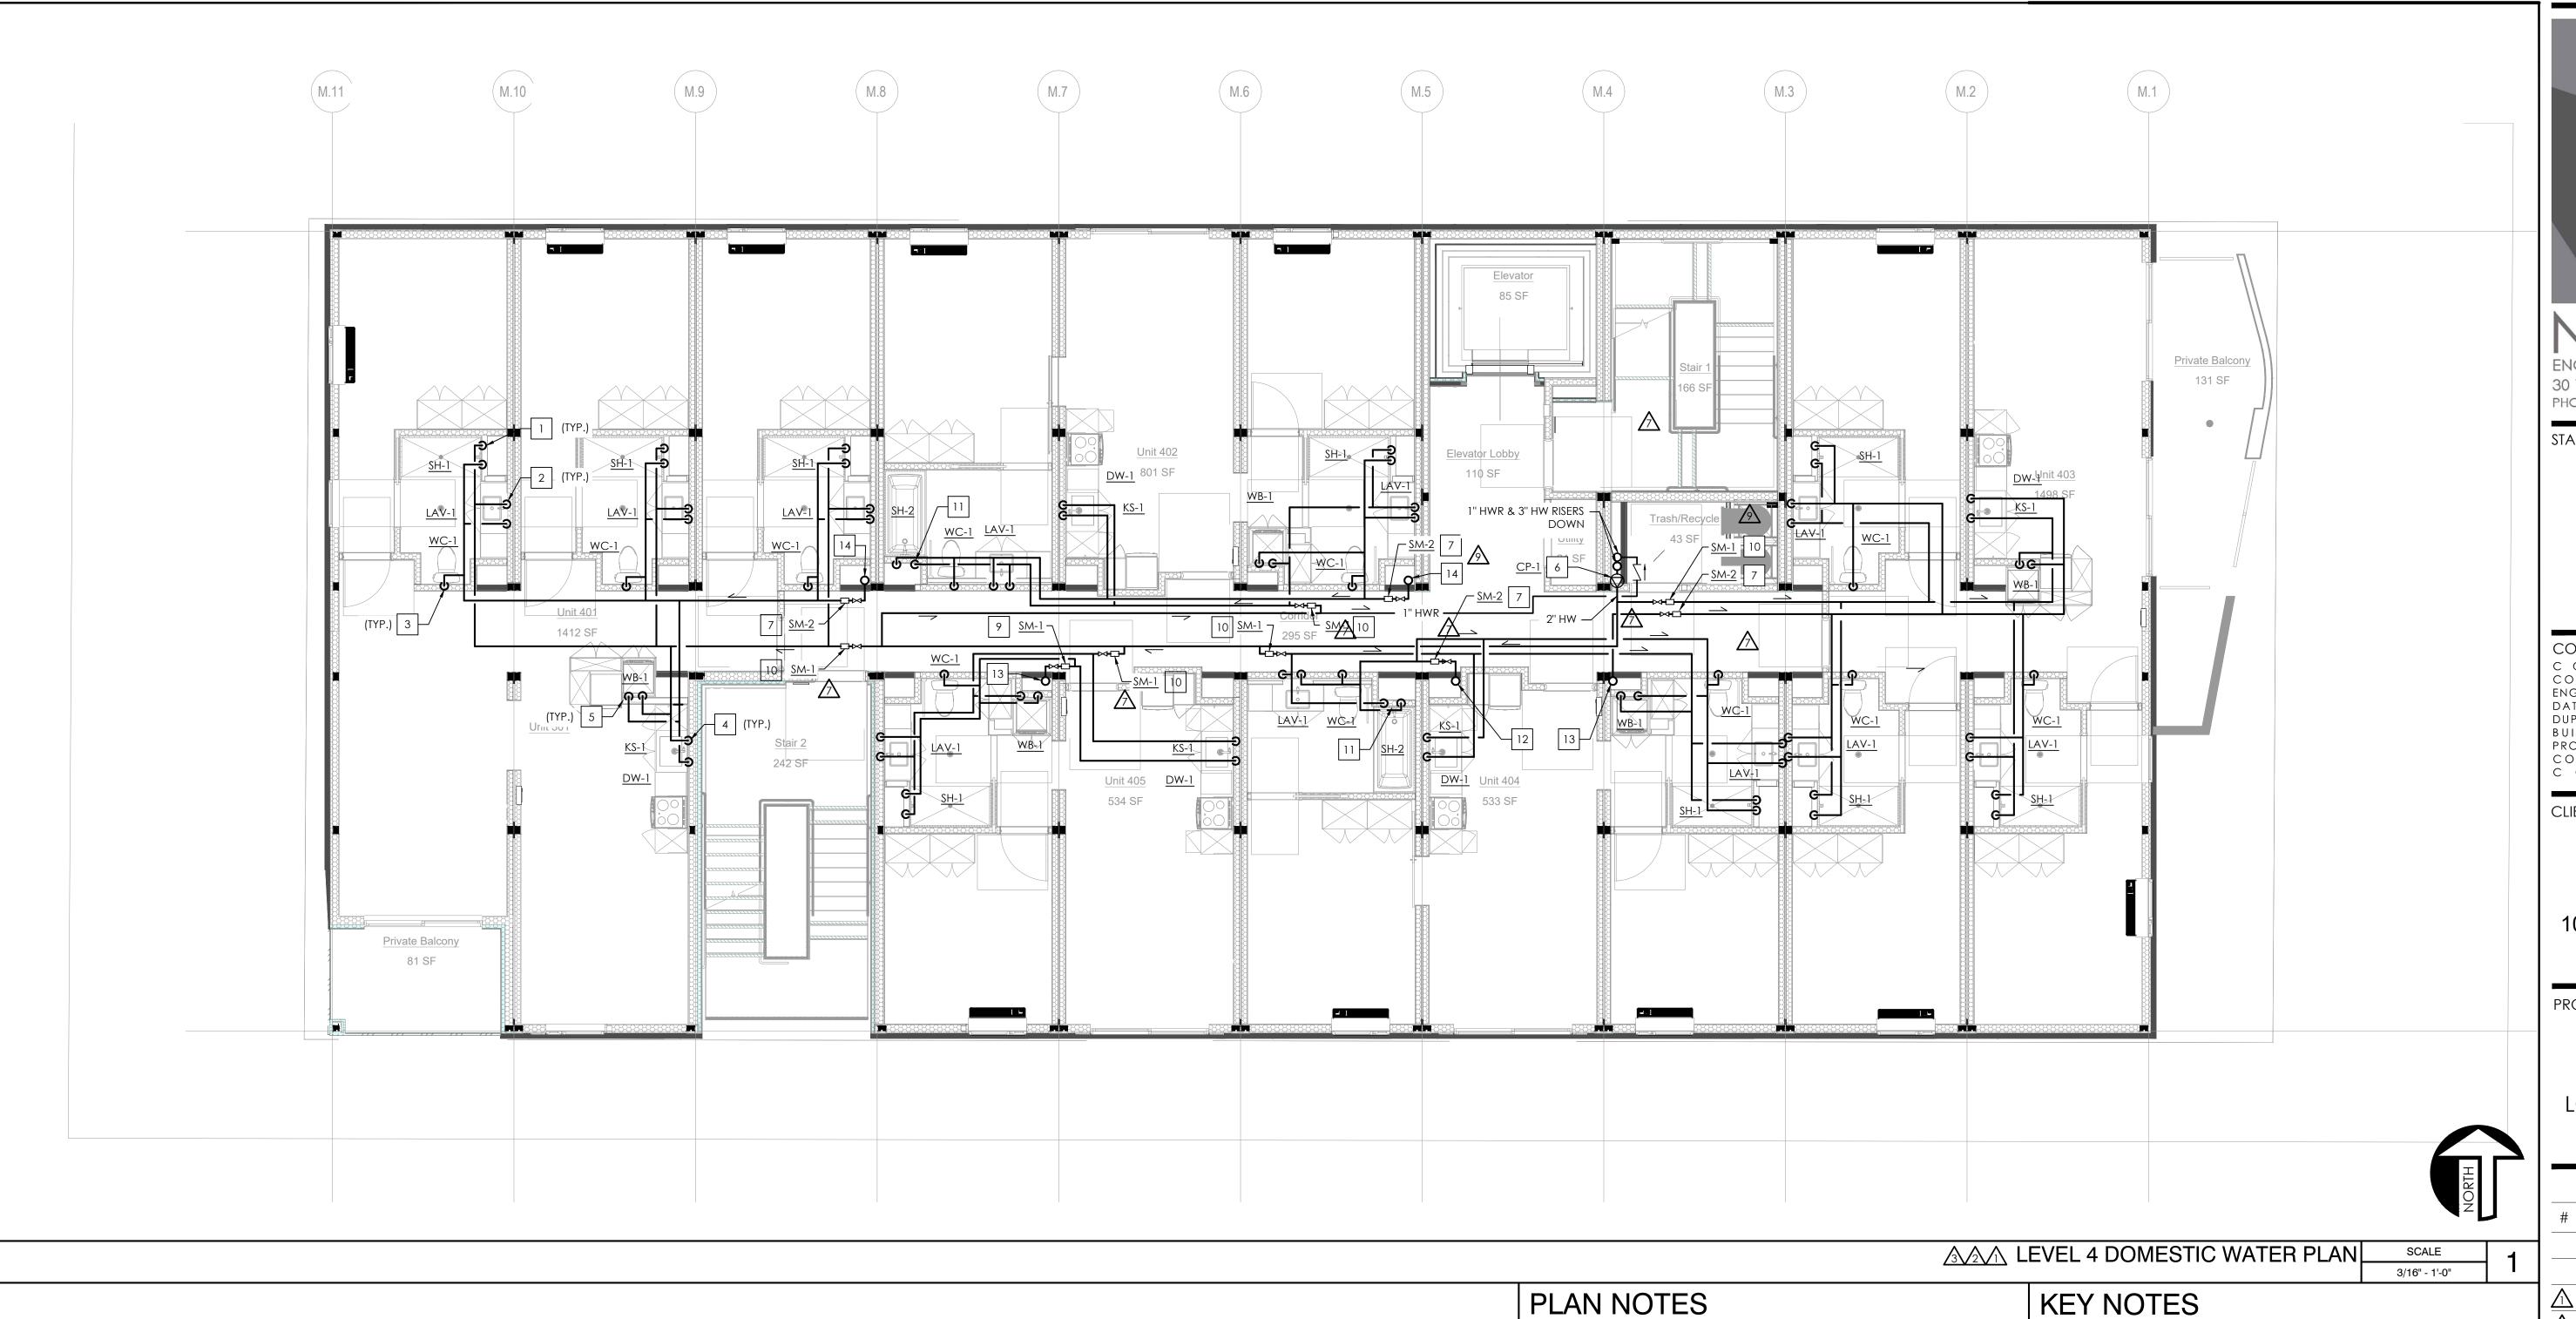
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	#	DESCRIPTION	DATE
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		UTILITY COORDINATION	04/08/22
	$\overline{\Lambda}$	PC RESUBMITTAL	05/18/22
	2	PC RESUBMITTAL	10/28/22
	3	HCD REVISION 1	12/16/22
	4	PC RESUBMITTAL	02/02/23
	<u></u>	HCD & PC RESUBMITTAL	06/06/23
		HCD RESUBMITTAL	06/14/23
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	8	CLIENT REVISIONS	07/11/23
	<u></u>	CLIENT REVISIONS	08/04/23
	10	PC RESUBMITTAL (ELEC)	09/12/23
	\triangle	PC RESUBMITTAL (ELEC)	10/05/23
	1	CLIENT REVISIONS	10/12/23

SHEET TITLE:

LEVEL 3 DOMESTIC WATER PLAN



1. 1" H&CW DOWN TO SHOWER.

- A. REFER TO SHEET P001 FOR GENERAL PLUMBING INFORMATION.
- B. REFER TO SHEET P501 FOR DETAILS.
- C. REFER TO SHEET P601 FOR SCHEDULES AND CALCULATIONS.
- D. REFER TO SHEET P103 FOR CONTINUATIONS BELOW AND TO SHEET P105 FOR CONTINUATIONS ABOVE.
- E. REFER TO PLUMBING RISER DIAGRAMS ON SHEET P301 THROUGH P303.

BOTH HW & CW SUPPLY BRANCHES SERVING EACH UNIT.

PROVIDE ISOLATION SOV IN AN ACCESSIBLE LOCATION INSIDE PLUMBING CHASE, FOR

2. 3/4" H&CW DOWN TO LAVATORY.

3. 1" CW DOWN TO WATER CLOSET.

NUMBERS INDICATE NOTES SHOWN ON PLAN

- 4. 1" H&CW DOWN TO SERVE KITCHEN SINK W/ DISHWASHER. 5. 1" H&CW DOWN TO LAUNDRY WALL BOX.
- 6. PROVIDE CIRCULATION PUMP ABOVE FIN CEILING W/ ACCESS PANEL FOR HWR SYSTEM. 7. PROVIDE 1-1/2" WATER SUB-METER W/ SOV FOR CW SUPPLY SERVING THIS UNIT.
- 8. PROVIDE 1-1/2" WATER SUB-METER W/ SOV FOR HW SUPPLY SERVING THIS UNIT.
- 9. PROVIDE 1" WATER SUB-METER W/ SOV FOR CW SUPPLY SERVING THIS UNIT.
- 10. PROVIDE 1" WATER SUB-METER W/ SOV FOR HW SUPPLY SERVING THIS UNIT.
- 11. 1" H&CW DOWN TO SHOWER W/ BATHTUB.
- 12. 1-1/4" CW RISER UP TO SERVE FLOORS ABOVE.
- 13. 1-1/2" CW RISER UP TO SERVE FLOORS ABOVE.
- 14. 2" CW RISER UP TO SERVE FLOORS ABOVE.

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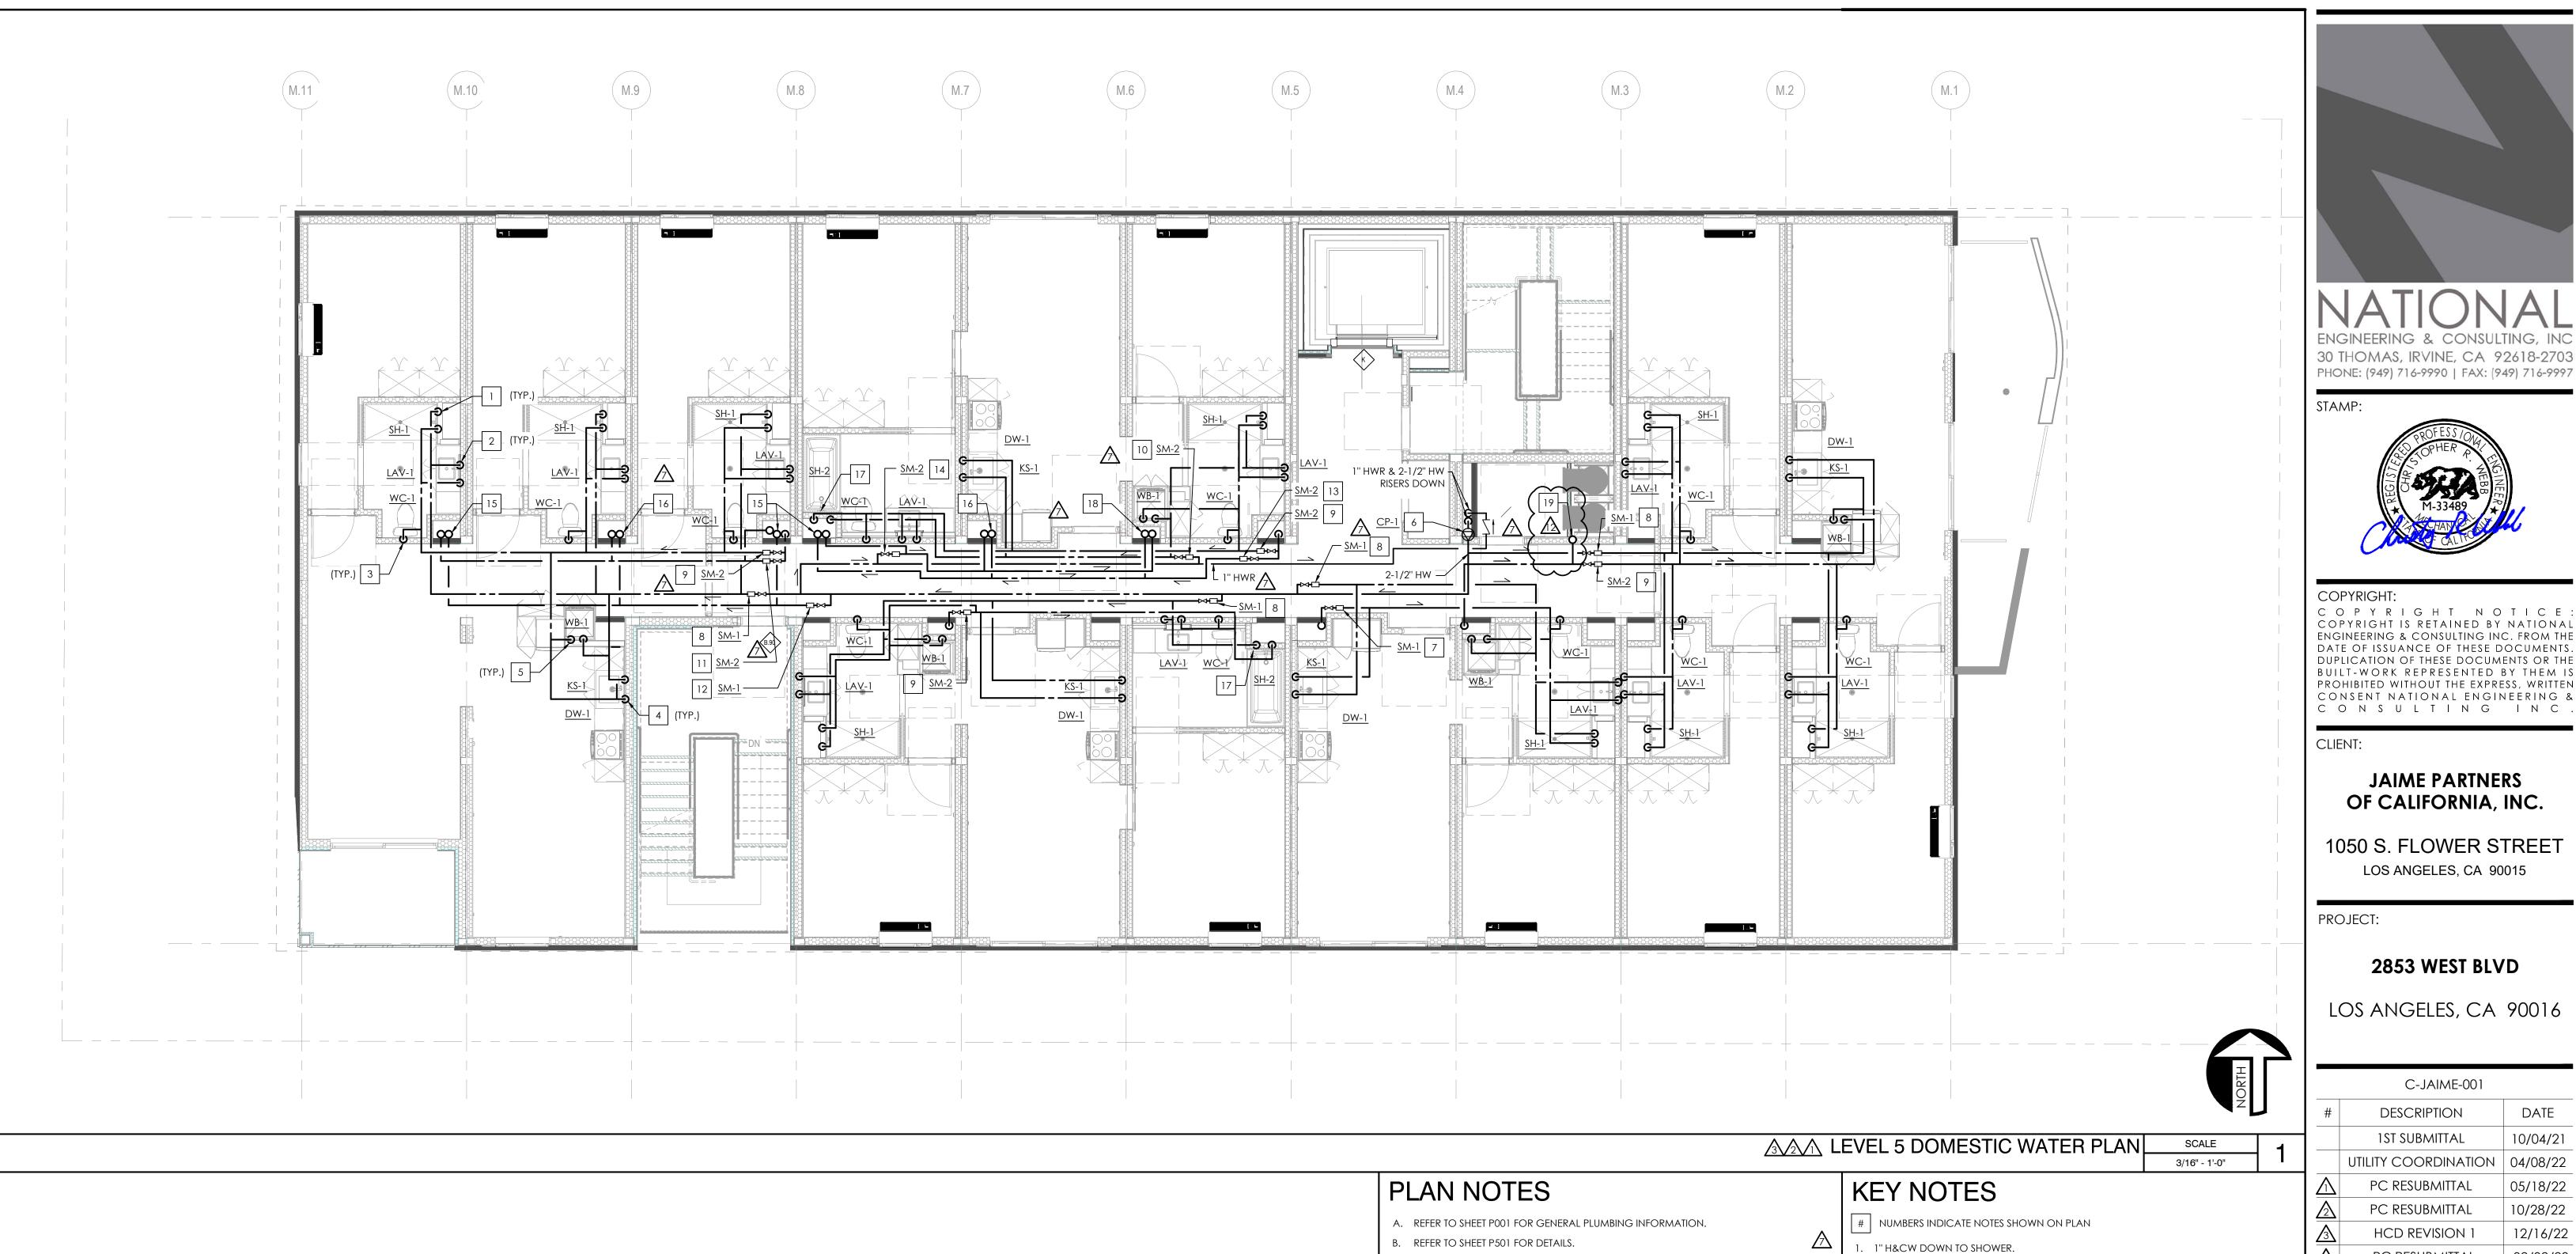
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	2	PC RESUBMITTAL	10/28/22
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	4	PC RESUBMITTAL	02/02/23
	<u></u>	HCD & PC RESUBMITTAL	06/06/23
	<u>^</u>	HCD RESUBMITTAL	06/14/23
	$\overline{\mathbb{A}}$	PC RESUBMITTAL	07/10/23
۱.	8	CLIENT REVISIONS	07/11/23
	<u></u>	CLIENT REVISIONS	08/04/23
	10	PC RESUBMITTAL (ELEC)	09/12/23
	$\overline{\Lambda}$	PC RESUBMITTAL (ELEC)	10/05/23
	12	CLIENT REVISIONS	10/12/23
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SHEET TITLE:

LEVEL 4 DOMESTIC WATER PLAN



2. 3/4" H&CW DOWN TO LAVATORY.

C. REFER TO SHEET P601 FOR SCHEDULES AND CALCULATIONS.

BOTH HW & CW SUPPLY BRANCHES SERVING EACH UNIT .

CONTINUATIONS ABOVE.

D. REFER TO SHEET P104 FOR CONTINUATIONS BELOW AND TO SHEET P106 FOR

PROVIDE ISOLATION SOV IN AN ACCESSIBLE LOCATION INSIDE PLUMBING CHASE, FOR

E. REFER TO PLUMBING RISER DIAGRAMS ON SHEET P301 THROUGH P303.

- 3. 1" CW DOWN TO WATER CLOSET.
- 4. 1" H&CW DOWN TO SERVE KITCHEN SINK W/ DISHWASHER.
- 5. 1" H&CW DOWN TO LAUNDRY WALL BOX.
- 6. PROVIDE CIRCULATION PUMP ABOVE FIN CEILING W/ ACCESS PANEL FOR HWR SYSTEM
- 7. PROVIDE 1" WATER SUB-METER W/ SOV FOR CW SUPPLY SERVING THIS UNIT.
- 8. PROVIDE 1" WATER SUB-METER W/ SOV FOR HW SUPPLY SERVING THIS UNIT. 9. PROVIDE 1-1/2" WATER SUB-METER W/ SOV FOR CW SUPPLY SERVING THIS UNIT.
- 10. PROVIDE 1-1/2" WATER SUB-METER W/ SOV FOR HW SUPPLY SERVING THIS UNIT.
- 11. PROVIDE 1-1/2" WATER SUB-METER W/ SOV FOR CW SUPPLY UP TO SERVE UNIT #601.
- 12. PROVIDE 1" WATER SUB-METER W/ SOV FOR HW SUPPLY UP TO SERVE UNIT #601.
- 13. PROVIDE 1-1/2" WATER SUB-METER W/ SOV FOR CW SUPPLY UP TO SERVE UNIT #602.
- 14. PROVIDE 1" WATER SUB-METER W/ SOV FOR HW SUPPLY UP TO SERVE UNIT #602. √3. 1-1/4" H&CW RISER UP TO SERVE UNIT ABOVE.
- 16. 1" H&CW RISER UP TO SERVE UNIT ABOVE.
- 17. 1" H&CW DOWN TO SHOWER W/ BATHTUB.
- 18. 1-1/4" HW & 1-1/2" CW RISER UP TO SERVE UNIT ABOVE.

 19. 3/4" CW SUPPLY UP TO SERVE TRASH CHUTE CLEANING SYSTEM ON 6TH FLOOR.



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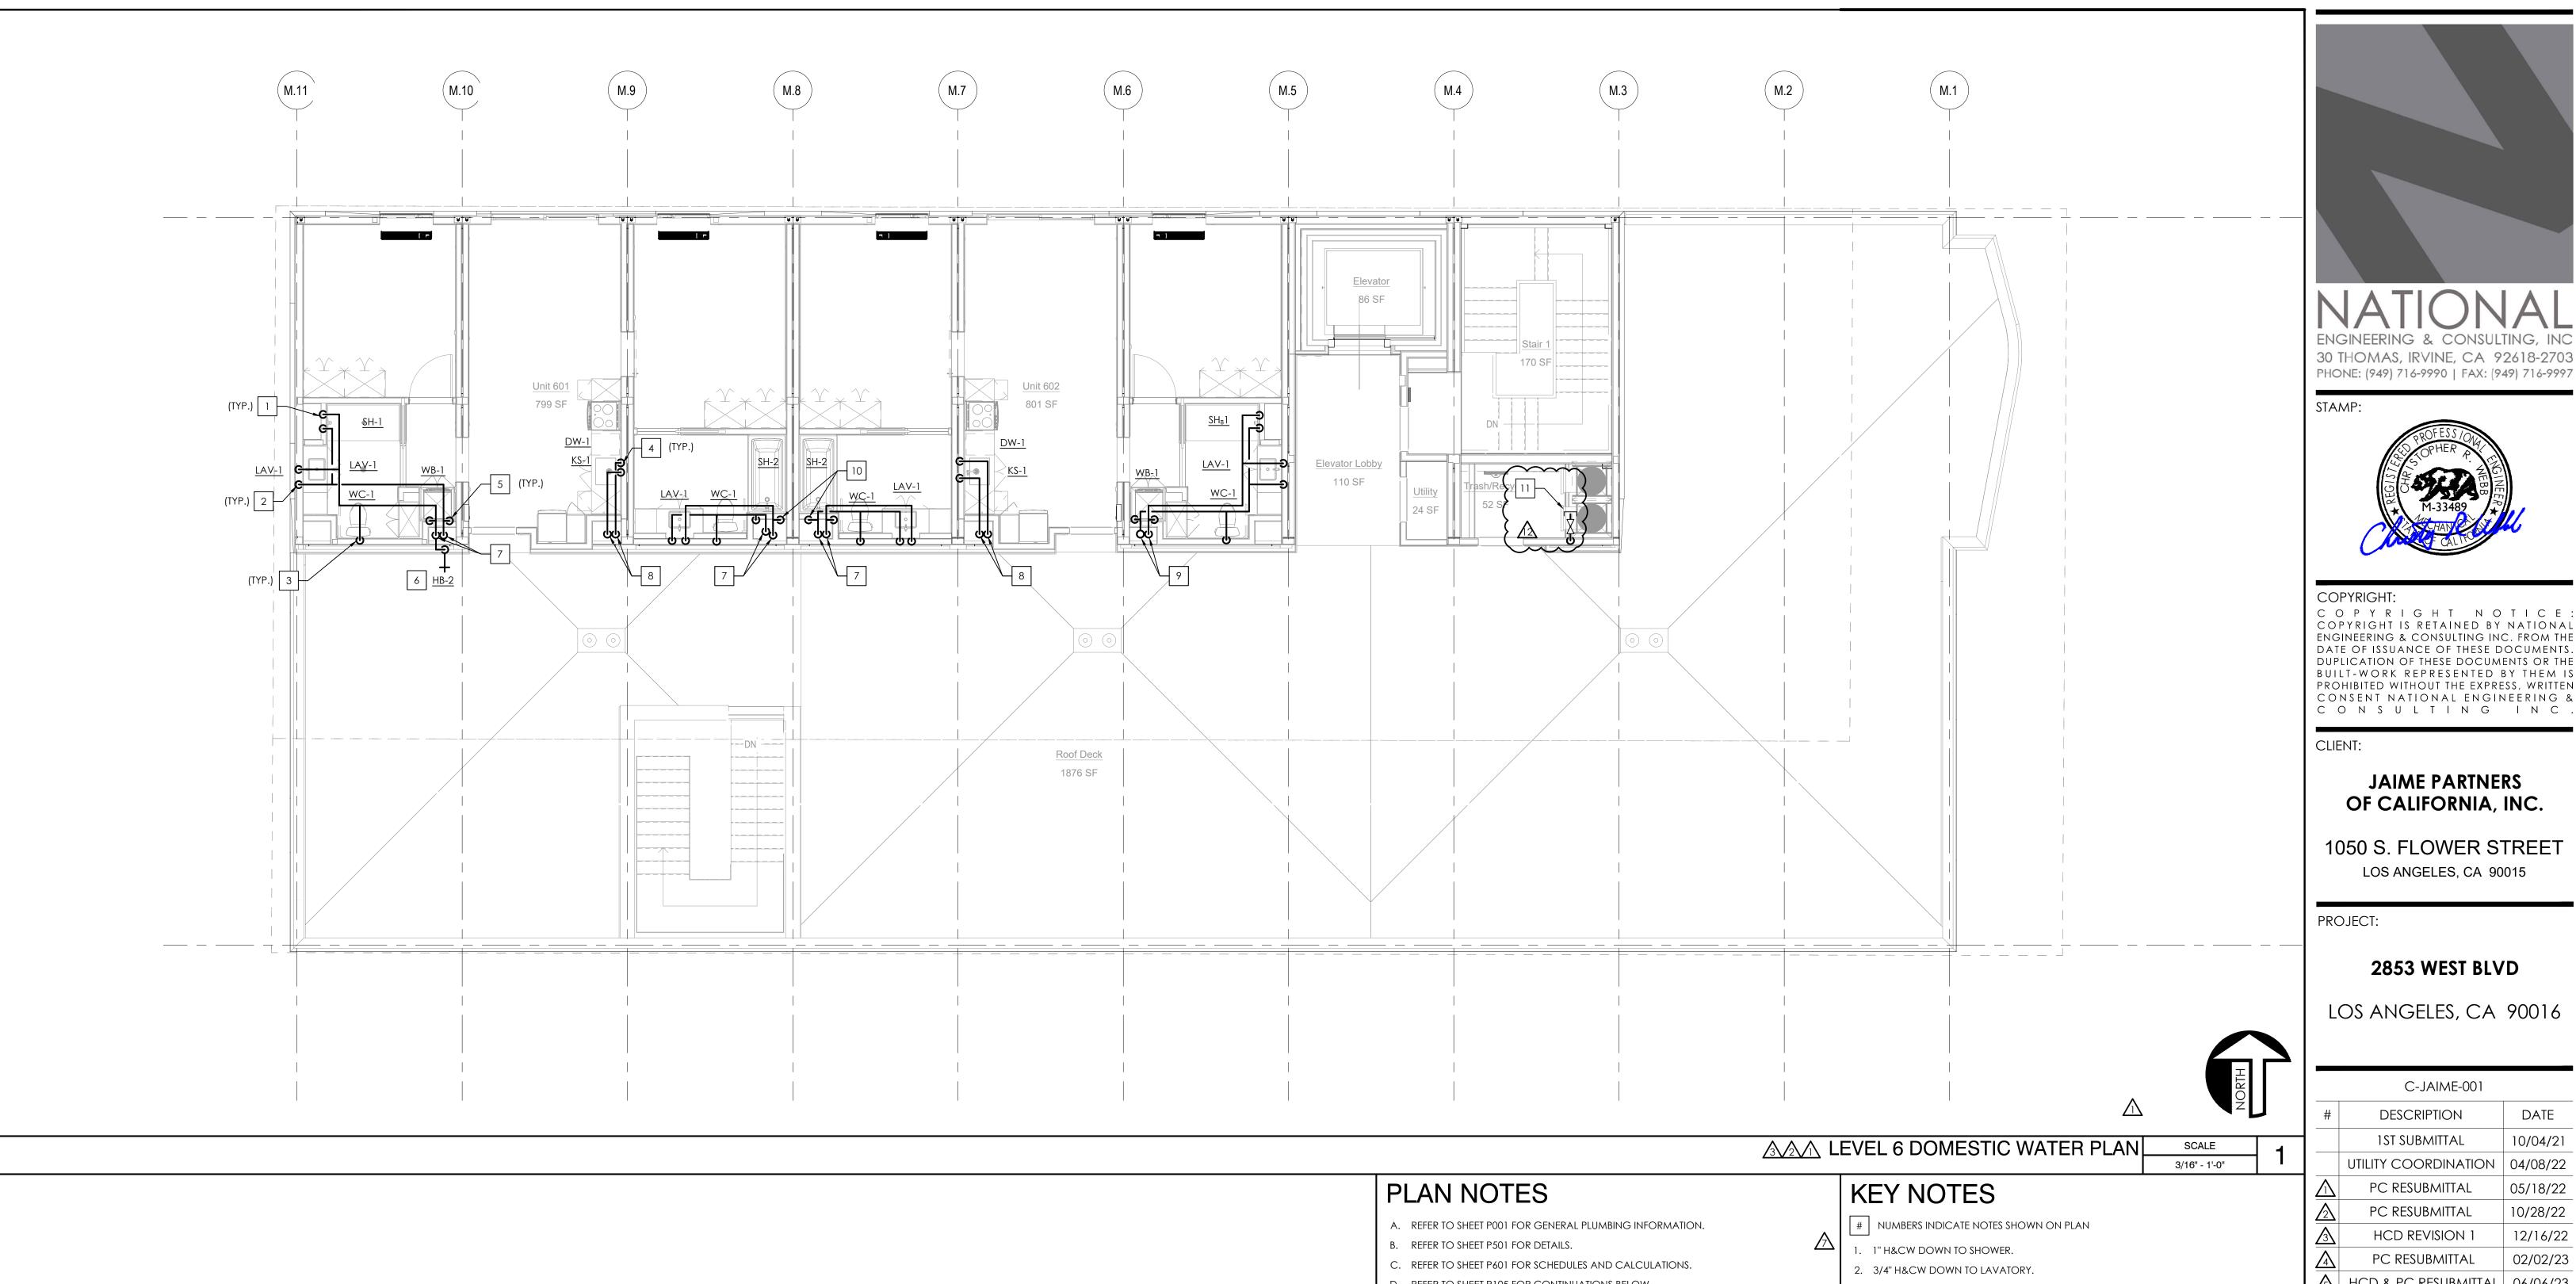
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	UTILITY COORDINATION	04/08/22
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2	PC RESUBMITTAL	10/28/22
3	HCD REVISION 1	12/16/22
4	PC RESUBMITTAL	02/02/23
<u> </u>	HCD & PC RESUBMITTAL	06/06/23
<u></u>	HCD RESUBMITTAL	06/14/23
$\overline{\wedge}$	PC RESUBMITTAL	07/10/23
8	CLIENT REVISIONS	07/11/23
<u></u>	CLIENT REVISIONS	08/04/23
<u> </u>	PC RESUBMITTAL (ELEC)	09/12/23
$\overline{\mathbb{A}}$	PC RESUBMITTAL (ELEC)	10/05/23
12	CLIENT REVISIONS	10/12/23
Plot	Date: 10/11/2023	4:59:30 PM

SHEET TITLE:

LEVEL 5 DOMESTIC WATER PLAN



- D. REFER TO SHEET P105 FOR CONTINUATIONS BELOW.
- E. REFER TO PLUMBING RISER DIAGRAMS ON SHEET P301 THROUGH P303.
- PROVIDE ISOLATION SOV IN AN ACCESSIBLE LOCATION INSIDE PLUMBING CHASE, FOR BOTH HW & CW SUPPLY BRANCHES SERVING EACH UNIT .
- 3. 1" CW DOWN TO WATER CLOSET.
- 4. 1" H&CW DOWN TO SERVE KITCHEN SINK W/ DISHWASHER.
- 5. 1" H&CW DOWN TO LAUNDRY WALL BOX.
- 6. 3/4" CW SUPPLY DOWN TO HB-2. 7. 1-1/4" H&CW RISER DOWN
- 8. 1" H&CW RISER DOWN.
- 9. 1-1/4" HW & 1-1/2" CW RISER DOWN. PROVIDE 3/4" CW UP TO SERVE <u>HB-2</u> ON ROOF
- 10. 1" H&CW DOWN TO SHOWER W/ BATHTUB.

 11. 3/4" CW SUPPLY TO SERVE TRASH CHUTE CLEANING SYSTEM (DESIGN-BUILD BY OTHERS).



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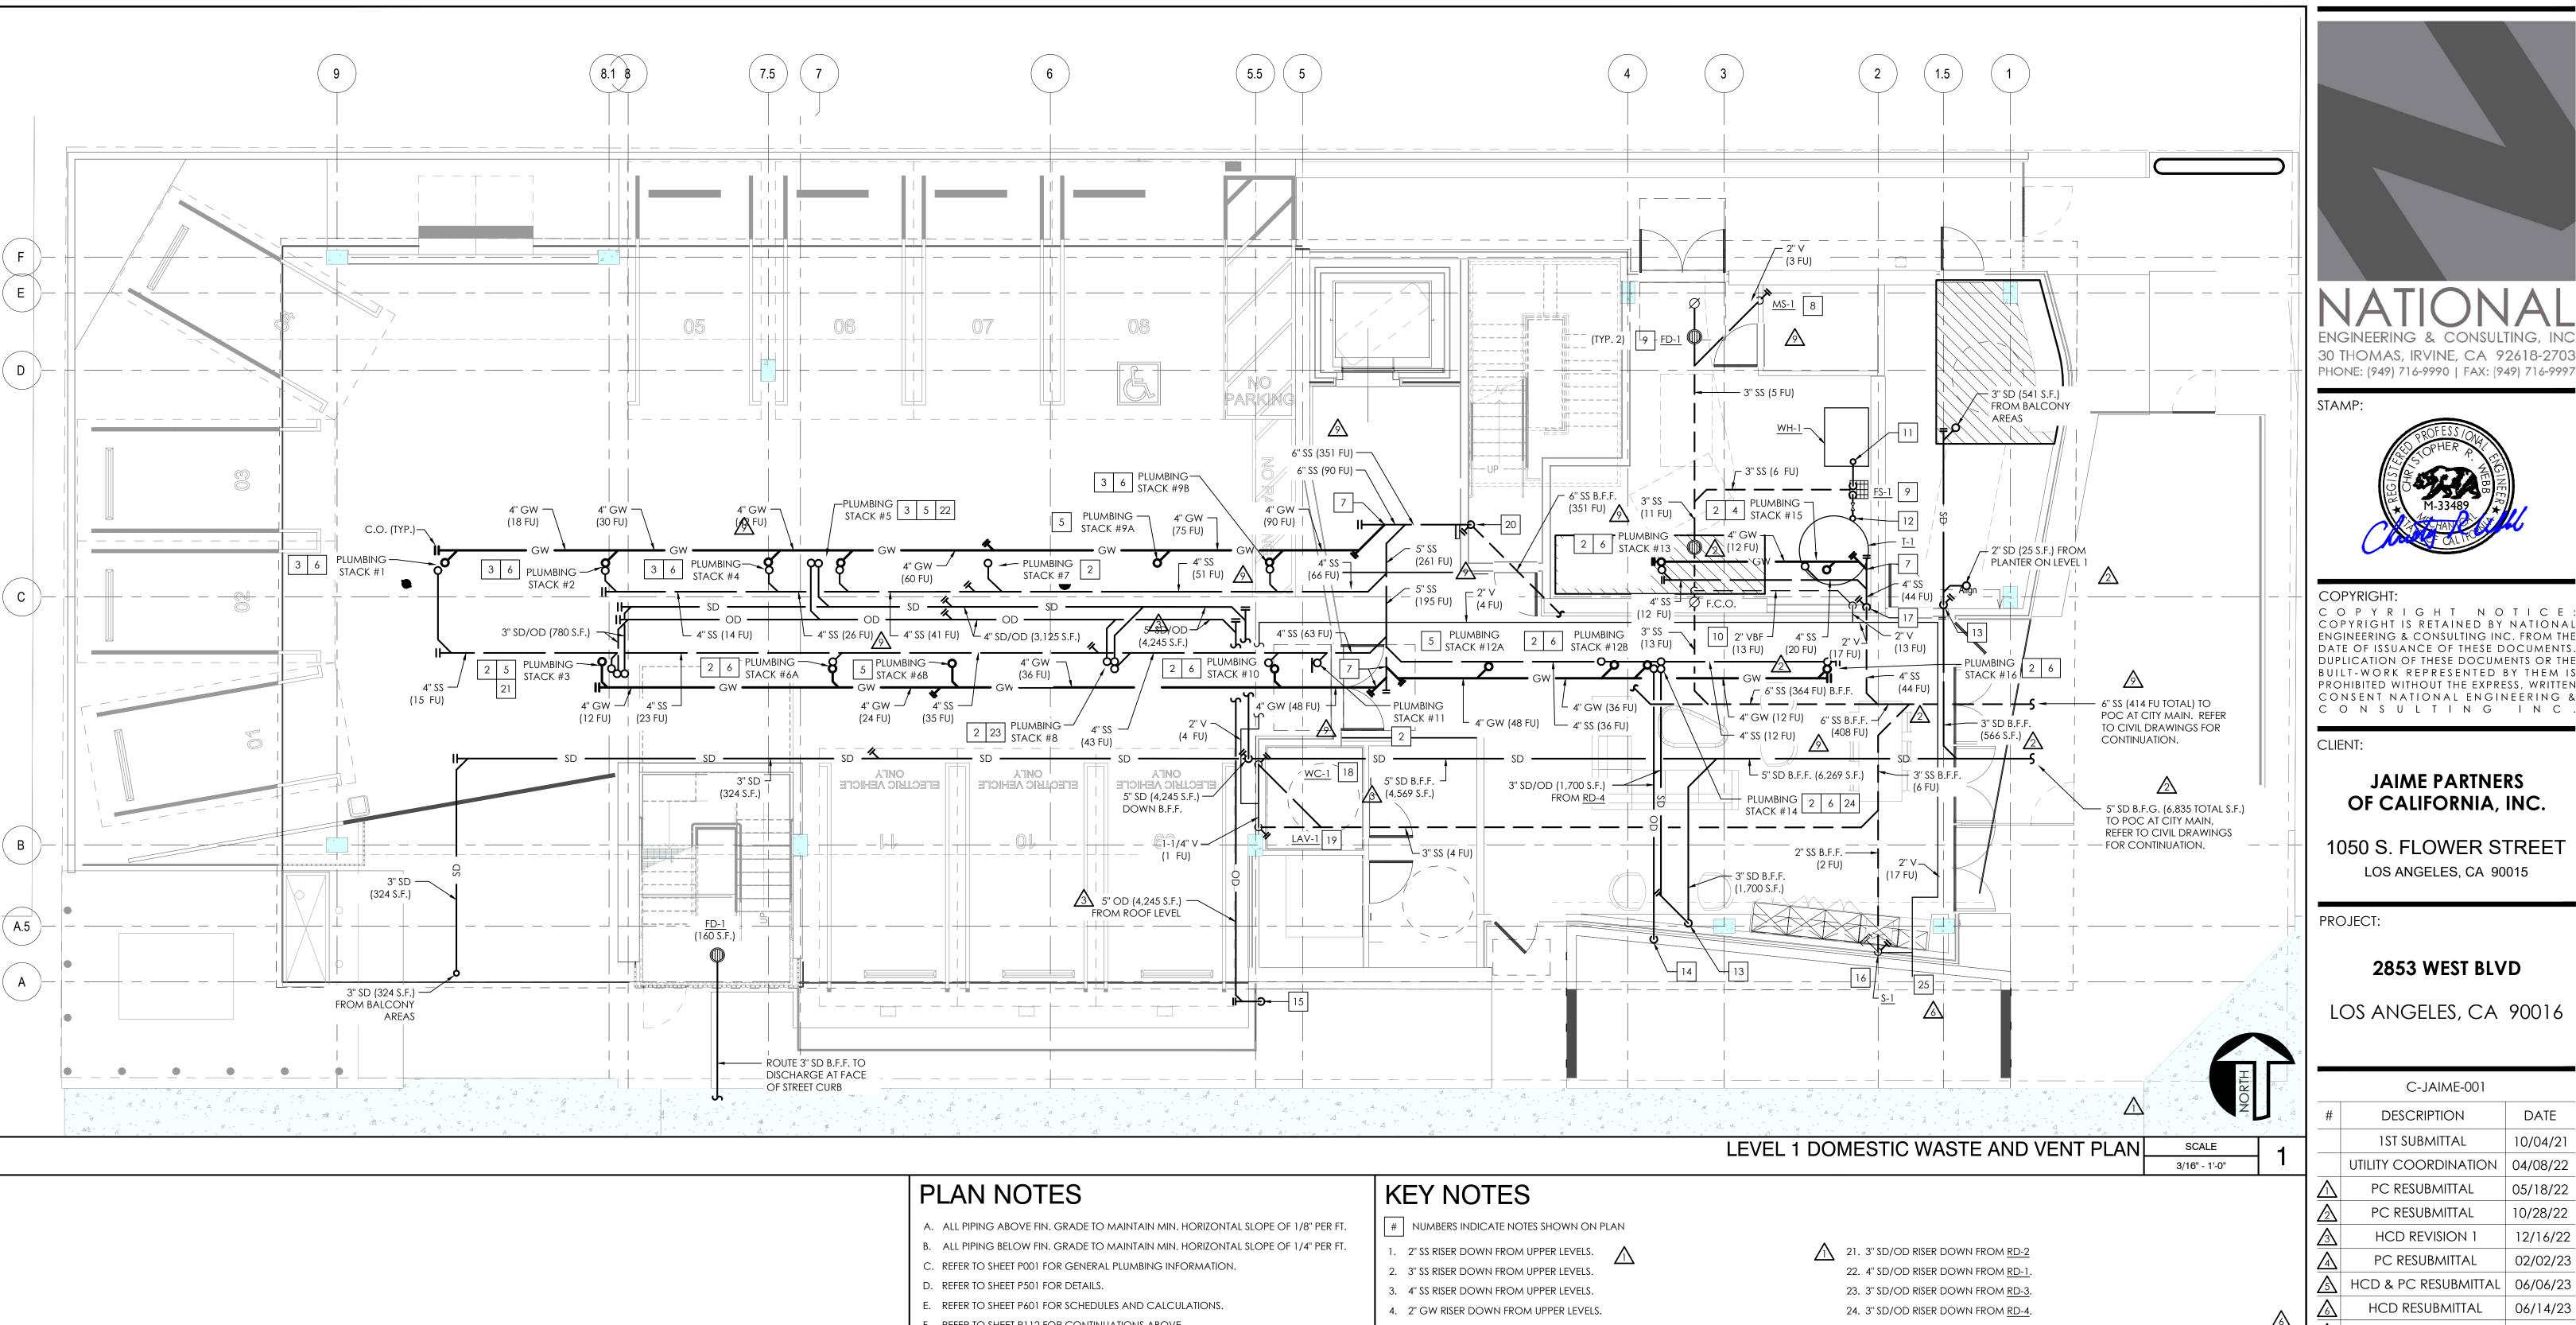
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	1ST SUBMITTAL	10/04/21
	UTILITY COORDINATION	04/08/22
$\overline{\mathbb{A}}$	PC RESUBMITTAL	05/18/22
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4	PC RESUBMITTAL	02/02/23
<u></u>	HCD & PC RESUBMITTAL	06/06/23
<u></u>	HCD RESUBMITTAL	06/14/23
\triangle	PC RESUBMITTAL	07/10/23
8	CLIENT REVISIONS	07/11/23
$\overline{\Diamond}$	CLIENT REVISIONS	08/04/23
<u>19</u>	PC RESUBMITTAL (ELEC)	09/12/23
$\overline{\mathbb{A}}$	PC RESUBMITTAL (ELEC)	10/05/23
<u>12</u>	CLIENT REVISIONS	10/12/23

SHEET TITLE:

LEVEL 6 DOMESTIC WATER PLAN



- F. REFER TO SHEET P112 FOR CONTINUATIONS ABOVE.
- G. REFER TO PLUMBING RISER DIAGRAMS ON SHEET P304 THROUGH P307.
- H. ALL STORM DRAIN AND OVERFLOW PIPING SIZED PER CPC TABLE 1101.7 (RAINFALL RATE OF 2 IN/HR).
- THE POINT OF CONNECTION BETWEEN THE GRAY WATER PIPING AND OTHER WASTE PIPING SHALL BE ACCESSIBLE (AS DEFINED BY LADBC 2.202) AND PROVIDED WITH SIGNAGE THAT IS SATISFACTORY TO THE DEPARTMENT.
- 5. 3" GW RISER DOWN FROM UPPER LEVELS.
- 6. 4" GW RISER DOWN FROM UPPER LEVELS.
- SEPARATE GRAY WATER PIPING CONNECTS TO BLACKWATER PIPING AT THIS LOCATION. ENSURE SUFFICIENT SPACE AT POC TO ALLOW FOR FUTURE DISCONNECTION OF GRAY WATER PIPING FROM BLACKWATER PIPING, CAPPING OF BLACKWATER PIPING AT POD AND EXTENSION OF GRAY WATER PIPING TO POTENTIAL FUTURE GRAY WATER TREATMENT SYSTEM (DESIGN-BUILD BY OTHERS).
- 8. 3" SS DOWN FROM MOP SINK.
- 9. 3" SS DOWN FROM FLOOR SINK/DRAIN.
- 10. ROUTE 2" VBF TO DAYLIGHT AT CORNER OF ROOM AND EXTEND UP FOR COMBINED WASTE AND VENT SYSTEM. COORDINATE FINAL LOCATION IN FIELD TO AVOID ANY NEARBY OBSTRUCTIONS AND MAINTAIN PROPER EQUIPMENT CLEARANCES.
- I 1. PROVIDE 1" CD PIPING W/ NEGATIVE P-TRAP FROM WATER HEATER TO DISCHARGE \bigwedge INTO FLOOR SINK WITH MIN. 1" AIR GAP.
- 12. PROVIDE 1" DRAIN W/ SOV FROM STORAGE TANK TO DISCHARGE INTO FLOOR SINK WITH MIN. 1" AIR GAP.
- 13. ROUTE 3" SD PIPING DOWN BELOW FIN. GRADE TO CONNECT TO BUILDING STORM DRAIN SYSTEM.
- 14. ROUTE 3" OD DOWN TO DISCHARGE INTO PLANTER AREA W/ DOWNSPOUT NOZZLE.
- 15. ROUTE 5" OD DOWN TO DISCHARGE INTO PLANTER AREA W/ DOWNSPOUT NOZZLE. 16. 2" SS DOWN AND 2" V CAPPED WITH AIR ADMITTANCE VALVE FROM HAND SINK.
- 17. ROUTE 4" SS MAIN RISER DOWN BELOW FIN. GRADE TO CITY MAIN POC.
- 18. 3" SS DOWN AND 2" V UP FROM WATER CLOSET.
- 19. 2" SS DOWN AND 1-1/4" V UP FROM LAVATORY.
- 20. ROUTE 6" SS MAIN RISER DOWN BELOW FIN. GRADE TO CITY MAIN POC.

25. 2" V STUBBED THROUGH EXTERIOR WALL BENEATH OVERHANG. SEAL PIPE PENETRATION THROUGH WALL WEATHER-TIGHT. ENSURE MINIMUM 3' CLERANCE FROM OPERABLE WINDOWS.



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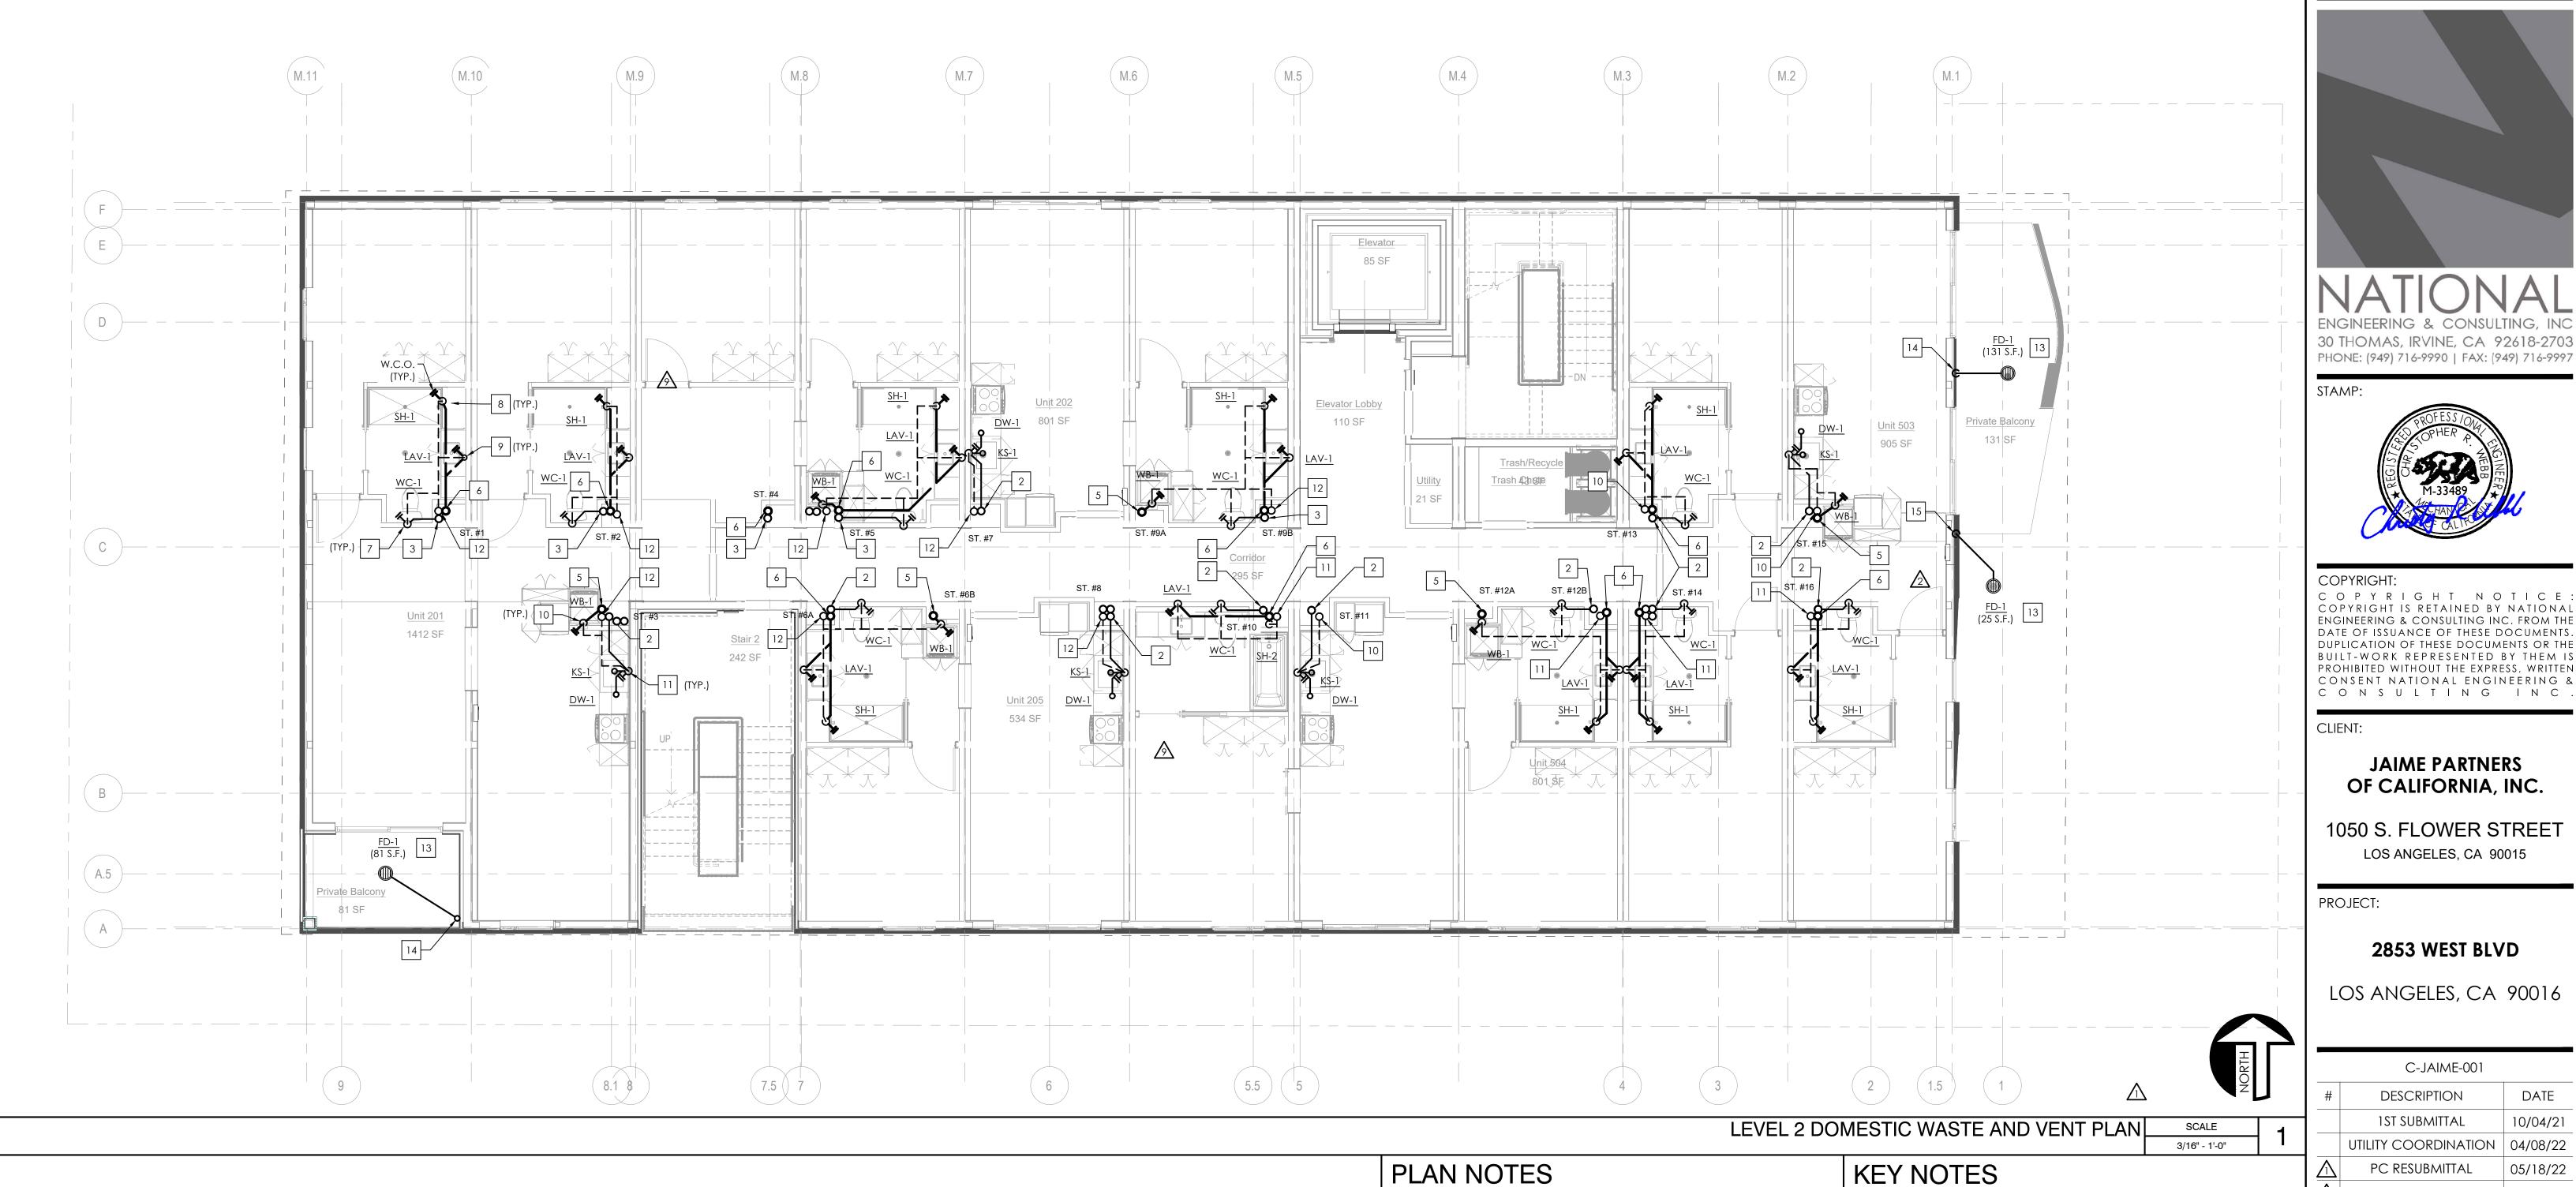
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`		1ST SUBMITTAL	10/04/21
		UTILITY COORDINATION	04/08/22
	$\overline{\Lambda}$	PC RESUBMITTAL	05/18/22
	<u>2</u>	PC RESUBMITTAL	10/28/22
	3	HCD REVISION 1	12/16/22
	4	PC RESUBMITTAL	02/02/23
	<u> </u>	HCD & PC RESUBMITTAL	06/06/23
	<u>^</u>	HCD RESUBMITTAL	06/14/23
7	\triangle	PC RESUBMITTAL	07/10/23
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	$\overline{\mathbb{A}}$	PC RESUBMITTAL (ELEC)	10/05/23
	13	CLIENT REVISIONS	10/12/23
	Plot	Date: 10/11/2023	4:59:55 PM

SHEET TITLE: LEVEL 1 DOMESTIC WASTE AND VENT PLAN



- A. HORIZONTAL SANITARY SEWER PIPING TO MAINTAIN MIN. SLOPE OF 1/4" PER FT. AT ALL TIMES.
- B. REFER TO SHEET P001 FOR GENERAL PLUMBING INFORMATION.
- C. REFER TO SHEET P501 FOR DETAILS.
- D. REFER TO SHEET P601 FOR SCHEDULES AND CALCULATIONS.

BACKWATER VALVES, OR ENGINEER-APPROVED EQUAL.

- E. REFER TO SHEET P111 FOR CONTINUATIONS BELOW AND TO SHEET P113 FOR CONTINUATIONS ABOVE.
- F. REFER TO PLUMBING RISER DIAGRAMS ON SHEET P304 THROUGH P307.
- G. UNITS THAT HAVE SHOWERS W/ BATHTUBS MUST BE PROVIDED W/ ZURN Z1090

- # NUMBERS INDICATE NOTES SHOWN ON PLAN
- 1. ROUTE 2" SS RISER DOWN TIGHT TO UNDERSIDE OF LEVEL 1 PODIUM.
- 2. ROUTE 3" SS RISER DOWN TIGHT TO UNDERSIDE OF LEVEL 1 PODIUM.
- 3. ROUTE 4" SS RISER DOWN TIGHT TO UNDERSIDE OF LEVEL 1 PODIUM.
- 4. ROUTE 2" GW RISER DOWN TIGHT TO UNDERSIDE OF LEVEL 1 PODIUM.
- 5. ROUTE 3" GW RISER DOWN TIGHT TO UNDERSIDE OF LEVEL 1 PODIUM. 6. ROUTE 4" GW RISER DOWN TIGHT TO UNDERSIDE OF LEVEL 1 PODIUM.
- 7. 3" SS DOWN AND 2" V UP FROM WATER CLOSET.
- 8. 2" SS DOWN AND 2" V UP FROM SHOWER.
- 9. 2" SS DOWN AND 1-1/2" V UP FROM LAVATORY.
- 10. 2" SS DOWN AND 2" V UP FROM LAUNDRY WALL BOX. PROVIDE WITH ZURN Z1090 BACKWATER VALVE, OR ENGINEER-APPROVED EQUAL. REFER TO MANUFACTURER'S GUIDELINES FOR INSTALLATION.
- 11. 2" SS DOWN AND 2" V UP FROM KITCHEN SINK W/ DISHWASHER.
- 12. 2" V RISER UP TO SERVE UPPER LEVELS.
- 13. 2" SD DOWN FROM FLOOR DRAIN.
- 14. ROUTE 3" SD RISER DOWN TIGHT TO UNDERSIDE OF LEVEL 1 PODIUM.





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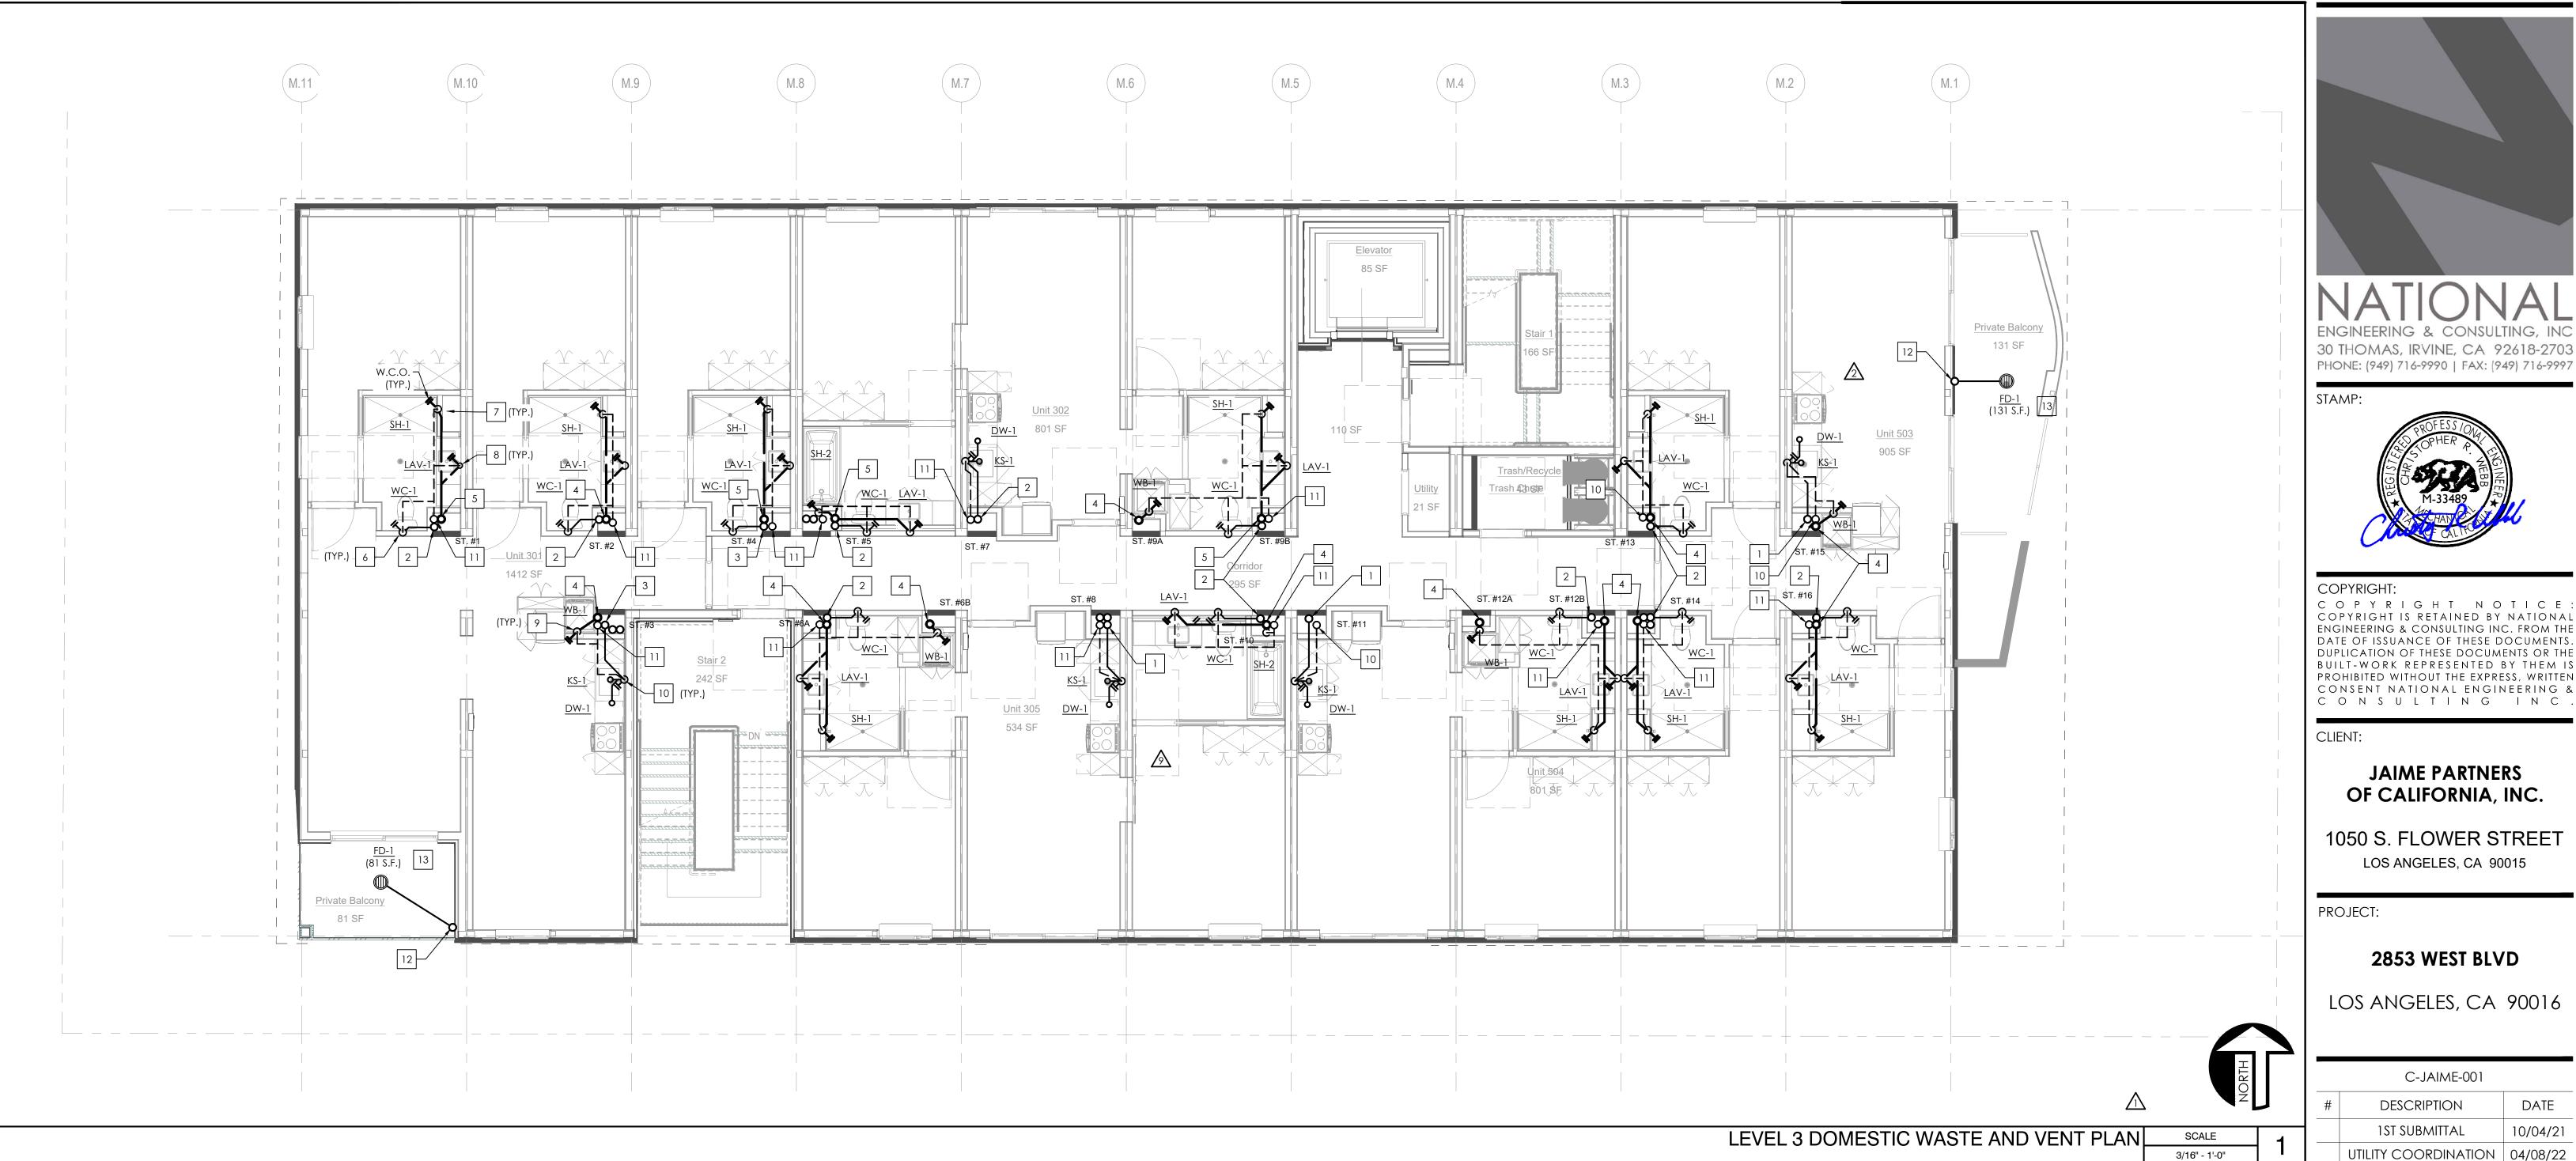
2853 WEST BLVD

LOS ANGELES, CA 90016

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		C-JAIME-001	
	#	DESCRIPTION	DATE
		1ST SUBMITTAL	10/04/21
		UTILITY COORDINATION	04/08/22
	$\overline{\Lambda}$	PC RESUBMITTAL	05/18/22
	2	PC RESUBMITTAL	10/28/22
	3	HCD REVISION 1	12/16/22
	4	PC RESUBMITTAL	02/02/23
	5	HCD & PC RESUBMITTAL	06/06/23
		HCD RESUBMITTAL	06/14/23
	\triangle	PC RESUBMITTAL	07/10/23
	8	CLIENT REVISIONS	07/11/23
		CLIENT REVISIONS	08/04/23
	10	PC RESUBMITTAL (ELEC)	09/12/23
	$\overline{\mathbb{A}}$	PC RESUBMITTAL (ELEC)	10/05/23
7	<u>13</u>	CLIENT REVISIONS	10/12/23
	Plot	Date: 10/11/2023	5:00:07 PM

SHEET TITLE:

LEVEL 2 DOMESTIC WASTE AND VENT PLAN



PLAN NOTES

- A. HORIZONTAL SANITARY SEWER PIPING TO MAINTAIN MIN. SLOPE OF 1/4" PER FT. AT ALL TIMES.
- B. REFER TO SHEET P001 FOR GENERAL PLUMBING INFORMATION.
- C. REFER TO SHEET P501 FOR DETAILS.
- D. REFER TO SHEET P601 FOR SCHEDULES AND CALCULATIONS.
- E. REFER TO SHEET P112 FOR CONTINUATIONS BELOW AND TO SHEET P114 FOR CONTINUATIONS ABOVE.
- F. REFER TO PLUMBING RISER DIAGRAMS ON SHEET P304 THROUGH P307.
- G. UNITS THAT HAVE SHOWERS W/ BATHTUBS MUST BE PROVIDED W/ ZURN Z1090 BACKWATER VALVES, OR ENGINEER-APPROVED EQUAL.

KEY NOTES

- # NUMBERS INDICATE NOTES SHOWN ON PLAN
- 1. 2" SS RISER DOWN TO SERVE LOWER LEVELS.
- 2. 3" SS RISER DOWN TO SERVE LOWER LEVELS.
- 3. 4" SS RISER DOWN TO SERVE LOWER LEVELS.
- 4. 3" GW RISER DOWN TO SERVE LOWER LEVELS.
- 5. 4" GW RISER DOWN TO SERVE LOWER LEVELS.
- 6. 3" SS DOWN AND 2" V UP FROM WATER CLOSET.
- 7. 2" SS DOWN AND 2" V UP FROM SHOWER. 8. 2" SS DOWN AND 1-1/2" V UP FROM LAVATORY.
- 9. 2" SS DOWN AND 2" V UP FROM LAUNDRY WALL BOX. PROVIDE WITH ZURN Z1090 BACKWATER VALVE, OR ENGINEER-APPROVED EQUAL. REFER TO MANUFACTURER'S GUIDELINES FOR INSTALLATION.
- 10. 2" SS DOWN AND 2" V UP FROM KITCHEN SINK W/ DISHWASHER.
- 11. 2" V RISER UP TO SERVE UPPER LEVELS.
- 12. 3" SD RISER DOWN TO SERVE LOWER LEVELS.
- 13. 2" SD DOWN FROM FLOOR DRAIN.
- 14. 2" GW RISER DOWN TO SERVE LOWER LEVELS.

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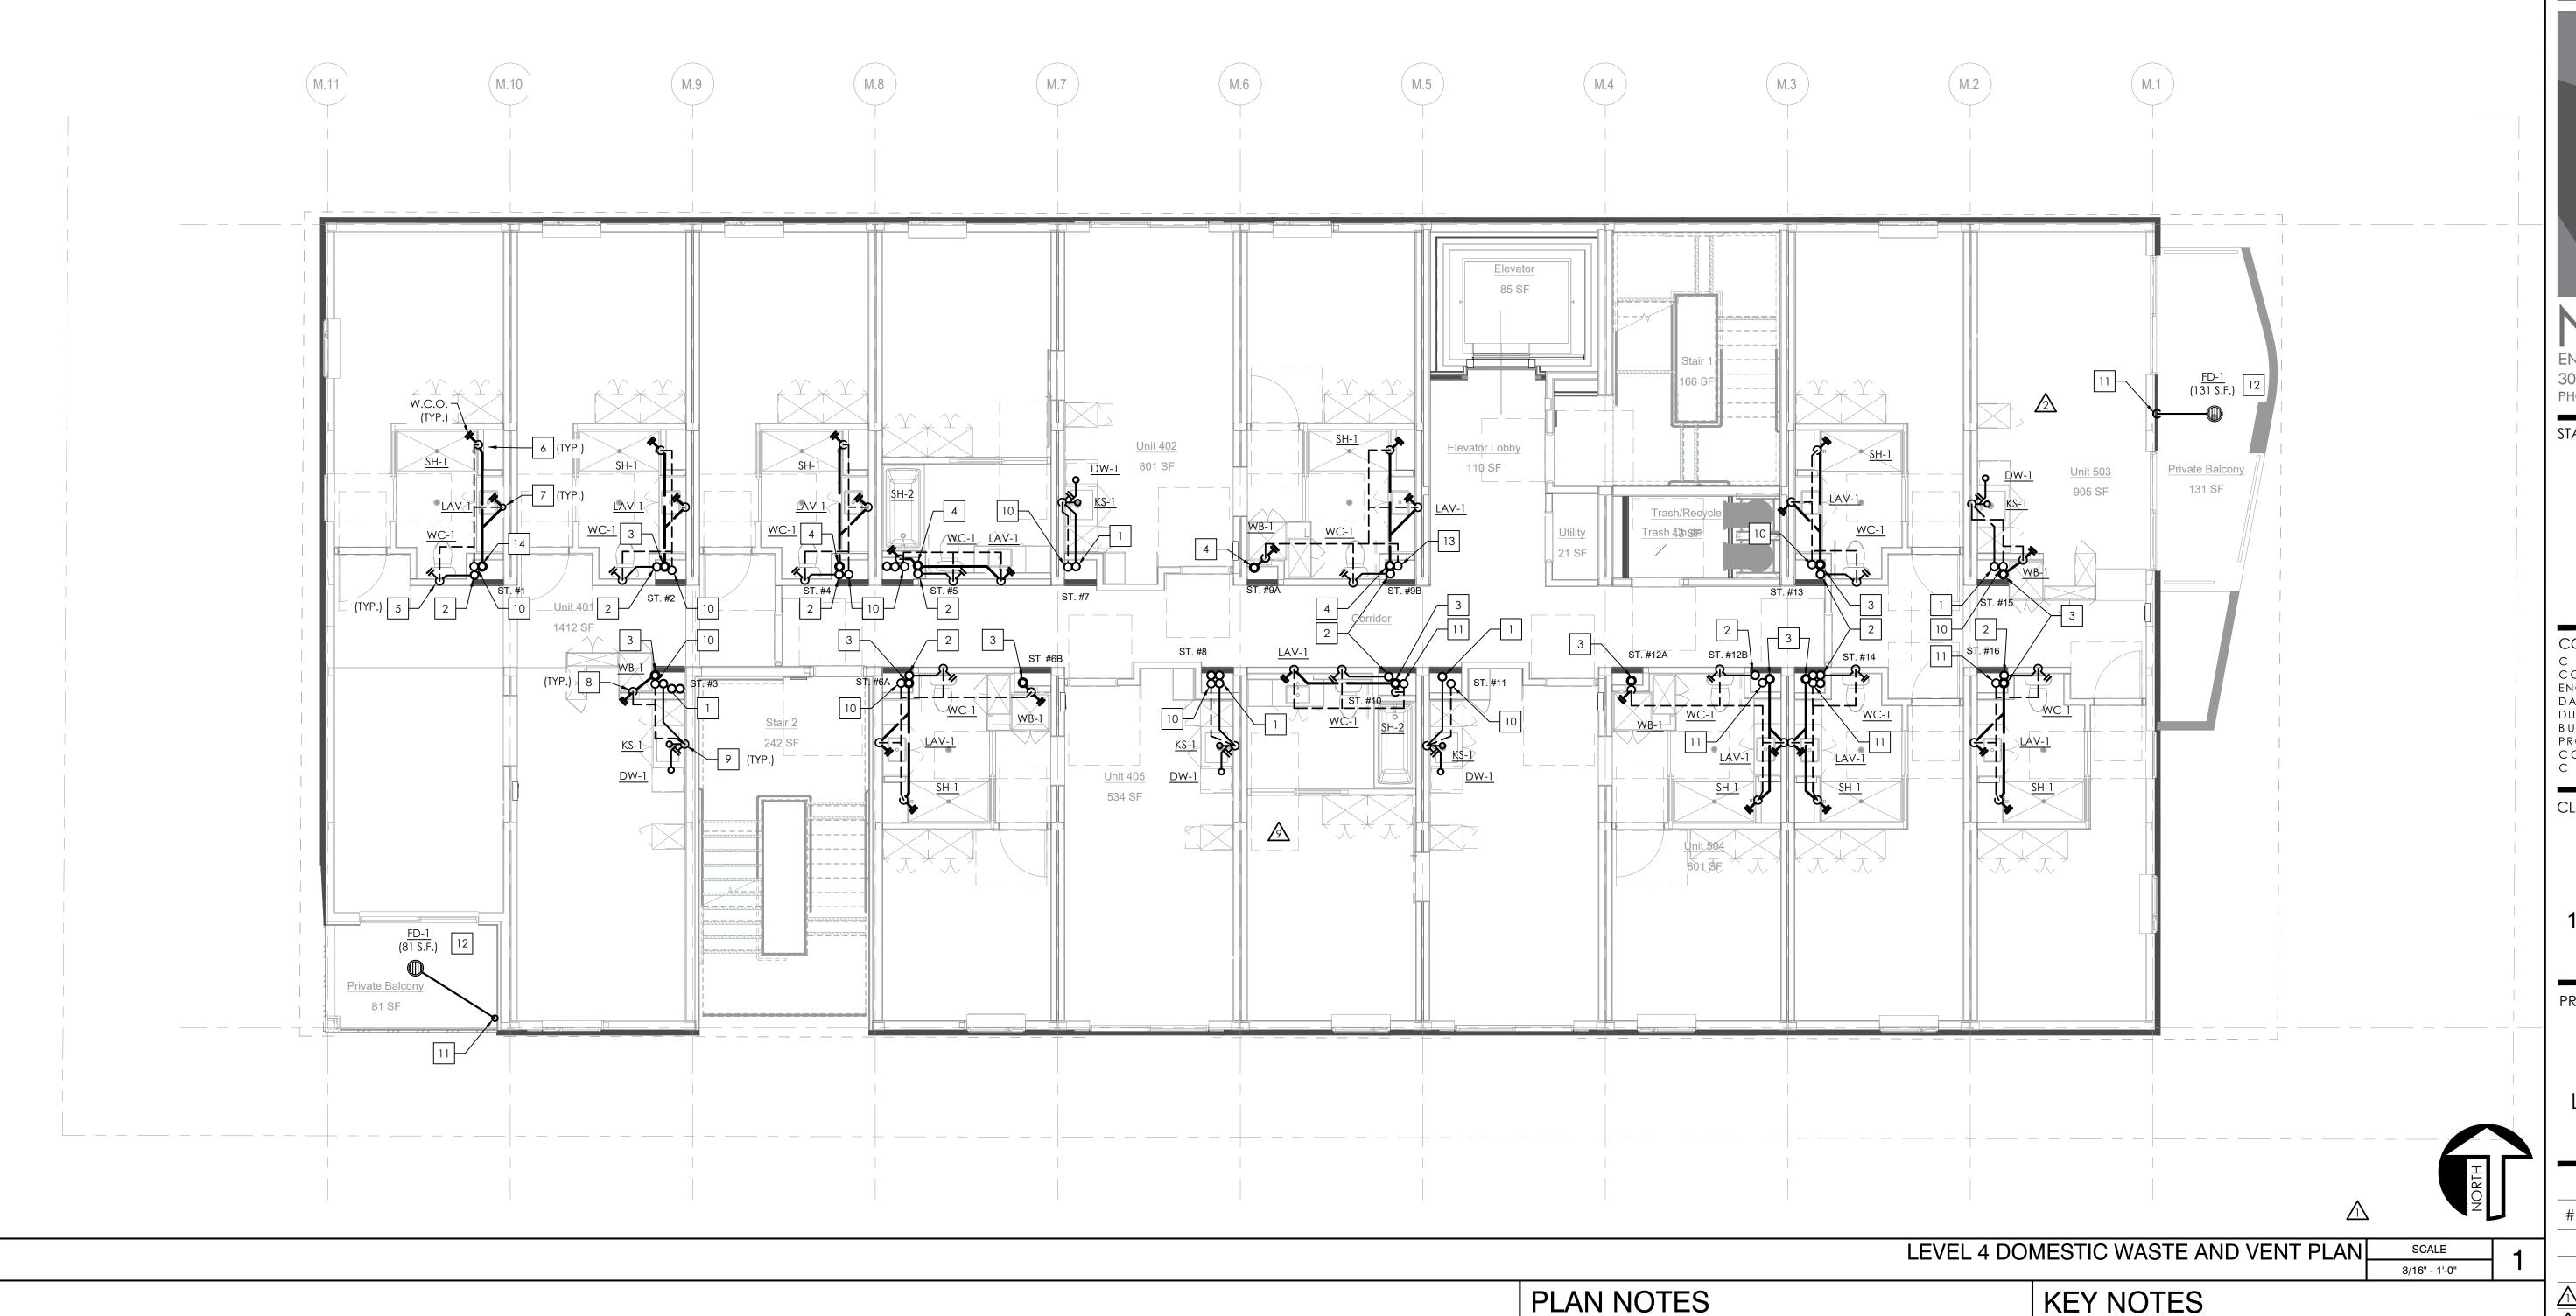
2853 WEST BLVD

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	2	PC RESUBMITTAL	10/28/22
	3	HCD REVISION 1	12/16/22
	4	PC RESUBMITTAL	02/02/23
	<u></u>	HCD & PC RESUBMITTAL	06/06/23
	<u>^</u>	HCD RESUBMITTAL	06/14/23
	\triangle	PC RESUBMITTAL	07/10/23
	8	CLIENT REVISIONS	07/11/23
	<u></u>	CLIENT REVISIONS	08/04/23
	10	PC RESUBMITTAL (ELEC)	09/12/23
	$\overline{\mathbb{A}}$	PC RESUBMITTAL (ELEC)	10/05/23
7	12	CLIENT REVISIONS	10/12/23
	Plot	Date: 10/11/2023	5:00:16 PM

SHEET TITLE:

LEVEL 3 DOMESTIC WASTE AND VENT PLAN



A. HORIZONTAL SANITARY SEWER PIPING TO MAINTAIN MIN. SLOPE OF 1/4" PER FT.

- AT ALL TIMES.
- B. REFER TO SHEET P001 FOR GENERAL PLUMBING INFORMATION.
- C. REFER TO SHEET P501 FOR DETAILS.
- D. REFER TO SHEET P601 FOR SCHEDULES AND CALCULATIONS.
- E. REFER TO SHEET P113 FOR CONTINUATIONS BELOW AND TO SHEET P115 FOR CONTINUATIONS ABOVE.
- F. REFER TO PLUMBING RISER DIAGRAMS ON SHEET P304 THROUGH P307.

G. UNITS THAT HAVE SHOWERS W/ BATHTUBS MUST BE PROVIDED W/ ZURN Z1090 BACKWATER VALVES, OR ENGINEER-APPROVED EQUAL.

KEY NOTES

- # NUMBERS INDICATE NOTES SHOWN ON PLAN
- 1. 2" SS RISER DOWN TO SERVE LOWER LEVELS.
- 2. 3" SS RISER DOWN TO SERVE LOWER LEVELS.
- 3. 2" GW RISER DOWN TO SERVE LOWER LEVELS.
- 4. 3" GW RISER DOWN TO SERVE LOWER LEVELS. 5. 3" SS DOWN AND 2" V UP FROM WATER CLOSET.
- 6. 2" SS DOWN AND 2" V UP FROM SHOWER.
- 7. 2" SS DOWN AND 1-1/2" V UP FROM LAVATORY.
- 8. 2" SS DOWN AND 2" V UP FROM LAUNDRY WALL BOX. PROVIDE WITH ZURN Z1090 BACKWATER VALVE, OR ENGINEER-APPROVED EQUAL. REFER TO MANUFACTURER'S GUIDELINES FOR INSTALLATION.
- 9. 2" SS DOWN AND 2" V UP FROM KITCHEN SINK W/ DISHWASHER.
- 10. 2" V RISER UP TO SERVE UPPER LEVELS.
- 11. 3" SD RISER DOWN TO SERVE LOWER LEVELS.
- 12. 2" SD DOWN FROM FLOOR DRAIN.
- 13. 3" V RISER UP TO SERVE UPPER LEVELS.
- 14. 4" GW RISER DOWN TO SERVE LOWER LEVELS.



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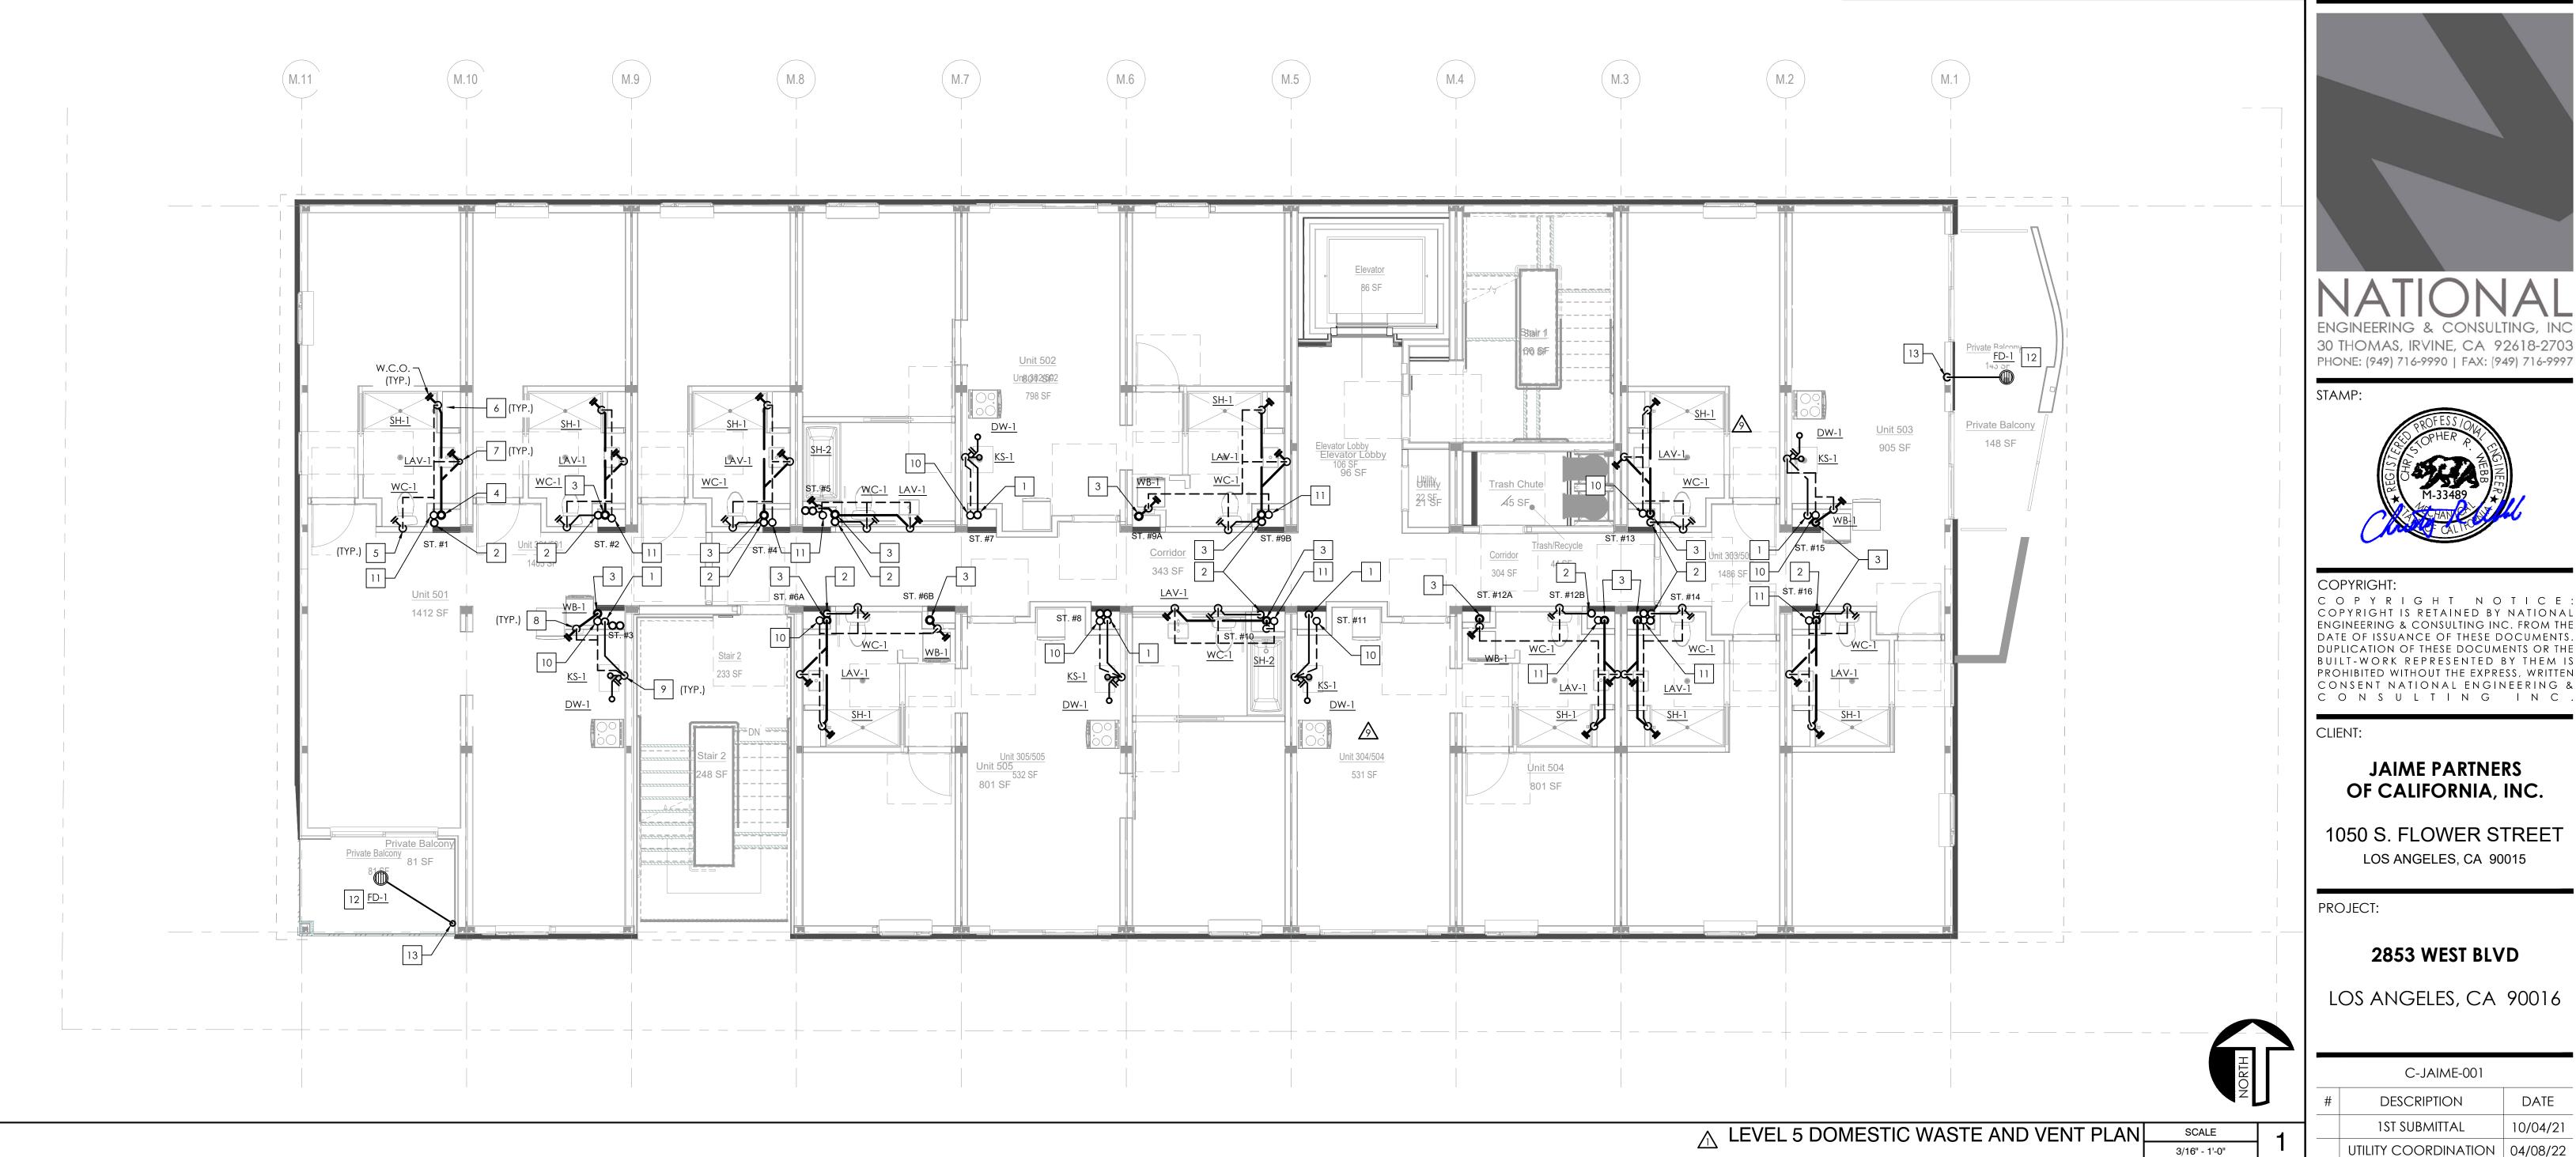
2853 WEST BLVD

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	2	PC RESUBMITTAL	10/28/22
	3	HCD REVISION 1	12/16/22
	4	PC RESUBMITTAL	02/02/23
	<u> </u>	HCD & PC RESUBMITTAL	06/06/23
	<u></u>	HCD RESUBMITTAL	06/14/23
	\triangle	PC RESUBMITTAL	07/10/23
	8	CLIENT REVISIONS	07/11/23
	<u></u>	CLIENT REVISIONS	08/04/23
	<u>M</u>	PC RESUBMITTAL (ELEC)	09/12/23
7	$\overline{\mathbb{A}}$	PC RESUBMITTAL (ELEC)	10/05/23
	13	CLIENT REVISIONS	10/12/23
	Plot	Date: 10/11/2023	4:59:45 PM

SHEET TITLE:

LEVEL 4 DOMESTIC WASTE AND VENT PLAN



PLAN NOTES

- A. HORIZONTAL SANITARY SEWER PIPING TO MAINTAIN MIN. SLOPE OF 1/4" PER FT. AT ALL TIMES.
- B. REFER TO SHEET P001 FOR GENERAL PLUMBING INFORMATION.
- C. REFER TO SHEET P501 FOR DETAILS.
- D. REFER TO SHEET P601 FOR SCHEDULES AND CALCULATIONS.

BACKWATER VALVES, OR ENGINEER-APPROVED EQUAL.

- E. REFER TO SHEET P114 FOR CONTINUATIONS BELOW AND TO SHEET P116 FOR CONTINUATIONS ABOVE.
- F. REFER TO PLUMBING RISER DIAGRAMS ON SHEET P304 THROUGH P307.
- G. UNITS THAT HAVE SHOWERS W/ BATHTUBS MUST BE PROVIDED W/ ZURN Z1090

KEY NOTES

- # NUMBERS INDICATE NOTES SHOWN ON PLAN
- 1. 2" SS RISER DOWN TO SERVE LOWER LEVELS.
- 2. 3" SS RISER DOWN TO SERVE LOWER LEVELS.
- 3. 2" GW RISER DOWN TO SERVE LOWER LEVELS. 4. 3" GW RISER DOWN TO SERVE LOWER LEVELS.
- 5. 3" SS DOWN AND 2" V UP FROM WATER CLOSET.
- 6. 2" SS DOWN AND 2" V UP FROM SHOWER.
- 7. 2" SS DOWN AND 1-1/2" V UP FROM LAVATORY.
- 8. 2" SS DOWN AND 2" V UP FROM LAUNDRY WALL BOX. PROVIDE WITH ZURN Z1090 BACKWATER VALVE, OR ENGINEER-APPROVED EQUAL. REFER TO MANUFACTURER'S GUIDELINES FOR INSTALLATION.
- 9. 2" SS DOWN AND 2" V UP FROM KITCHEN SINK W/ DISHWASHER.
- 10. 2" V RISER UP TO SERVE UPPER LEVELS.
- 11. 3" V RISER UP TO SERVE UPPER LEVELS.
- 12. 2" SD DOWN FROM FLOOR DRAIN.
- 13. 2" SD RISER DOWN TO SERVE LOWER FLOORS.



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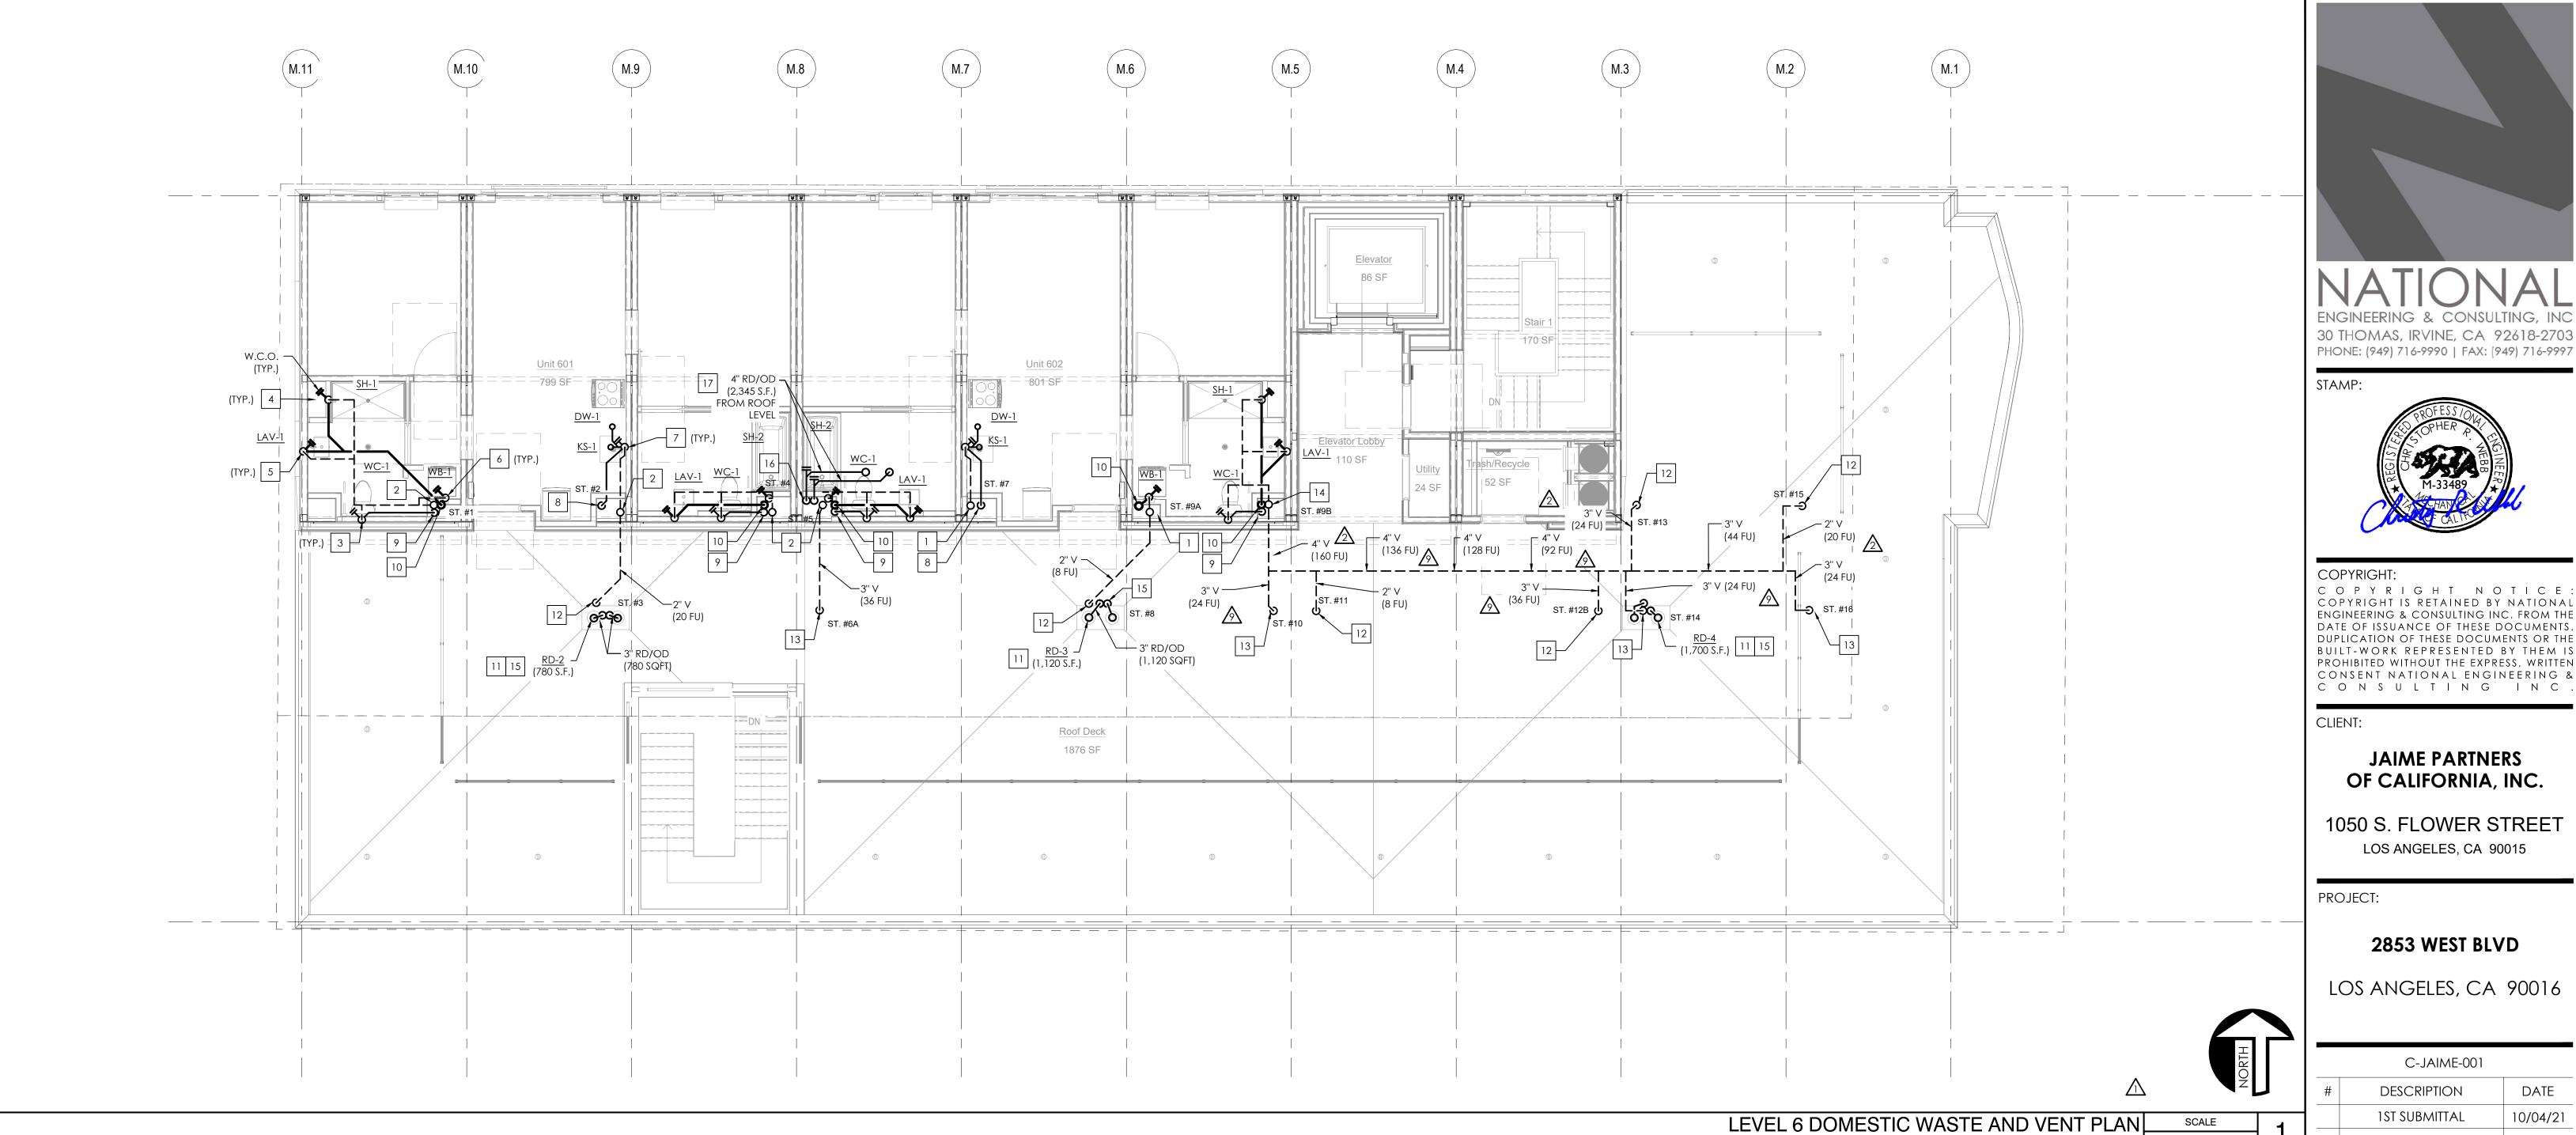
2853 WEST BLVD

LOS ANGELES, CA 90016

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		C-JAIME-001	
	#	DESCRIPTION	DATE
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		UTILITY COORDINATION	04/08/22
	$\overline{\triangle}$	PC RESUBMITTAL	05/18/22
	2	PC RESUBMITTAL	10/28/22
	3	HCD REVISION 1	12/16/22
	4	PC RESUBMITTAL	02/02/23
	<u>\(\frac{1}{5} \)</u>	HCD & PC RESUBMITTAL	06/06/23
		HCD RESUBMITTAL	06/14/23
	$\overline{\mathbb{A}}$	PC RESUBMITTAL	07/10/23
	8	CLIENT REVISIONS	07/11/23
		CLIENT REVISIONS	08/04/23
	10	PC RESUBMITTAL (ELEC)	09/12/23
7	$\overline{\mathbb{A}}$	PC RESUBMITTAL (ELEC)	10/05/23
	1	CLIENT REVISIONS	10/12/23
	Plot	Date: 10/11/2023	5:00:26 PM

SHEET TITLE:

LEVEL 5 DOMESTIC WASTE AND VENT PLAN



PLAN NOTES

- A. HORIZONTAL SANITARY SEWER PIPING TO MAINTAIN MIN. SLOPE OF 1/4" PER FT. AT ALL TIMES.
- B. ALL ROOF DRAIN AND OVERFLOW PIPING SIZED PER CPC TABLE 1101.7 (RAINFALL RATE OF 2 IN/HR).
- C. REFER TO SHEET P001 FOR GENERAL PLUMBING INFORMATION.
- D. REFER TO SHEET P501 FOR DETAILS.
- E. REFER TO SHEET P601 FOR SCHEDULES AND CALCULATIONS.
- F. REFER TO SHEET P115 FOR CONTINUATIONS BELOW.
- G. REFER TO PLUMBING RISER DIAGRAMS ON SHEET P304 THROUGH P307.
- H. UNITS THAT HAVE SHOWERS W/ BATHTUBS MUST BE PROVIDED W/ ZURN Z1090 BACKWATER VALVES, OR ENGINEER-APPROVED EQUAL.



KEY NOTES

- # NUMBERS INDICATE NOTES SHOWN ON PLAN
- 1. 2" VENT THRU ROOF. REFER TO ROOF PLAN ON SHEET P107 FOR CONTINUATION.

3/16" - 1'-0"

- 2. 3" VENT THRU ROOF. REFER TO ROOF PLAN ON SHEET P107 FOR CONTINUATION.
- 3. 3" SS DOWN AND 2" V UP FROM WATER CLOSET.
- 4. 2" SS DOWN AND 2" V UP FROM SHOWER.
- 5. 2" SS DOWN AND 1-1/2" V UP FROM LAVATORY.
- 6. 2" SS DOWN AND 2" V UP FROM LAUNDRY WALL BOX. PROVIDE W/ ZURN Z1090 BACKWATER VALVE, OR ENGINEER-APPROVED EQUAL. REFER TO MANUFACTURER'S GUIDELINES FOR INSTALLATION.
- 7. 2" SS DOWN AND 2" V UP FROM KITCHEN SINK W/ DISHWASHER.
- 8. 2" SS RISER DOWN TO SERVE LOWER LEVELS.
- 9. 3" SS RISER DOWN TO SERVE LOWER LEVELS.
- 10. 2" GW RISER DOWN TO SERVE LOWER LEVELS.
- 11. ROUTE 3" SD/OD DOWN INSIDE LEVEL 6 MECHANICAL CHASE.
- 12. ROUTE 2" V RISER FROM LOWER LEVELS, INSIDE CAVITY SPACE ABOVE LEVEL 5 CEILING, TO CONNECT TO COMMON VTR INSIDE LEVEL 6 MECHANICAL CHASE. DO NOT PENETRATE LOWER ROOF.
- 13. ROUTE 3" V RISER UP FROM LOWER LEVELS, INSIDE CAVITY SPACE ABOVE LEVEL 5 CEILING, TO CONNECT TO COMMON VTR INSIDE LEVEL 6 MECHANICAL CHASE. DO NOT PENETRATE LOWER ROOF.
- 14. 4" VENT THRU ROOF. REFER TO ROOF PLAN ON SHEET P107 FOR CONTINUATION.
- 15. 3" SD/OD RISER DOWN TIGHT TO UNDERSIDE OF LEVEL1 PODIUM. REFER TO SHEET P111 FOR CONTINUATION.
- 16. 4" SD/OD RISER DOWN TIGHT TO UNDERSIDE OF LEVEL1 PODIUM. REFER TO SHEET P111 FOR CONTINUATION.
- 17. ROUTE 4" SD/OD DOWN INSIDE LEVEL 6 MECHANICAL CHASE.



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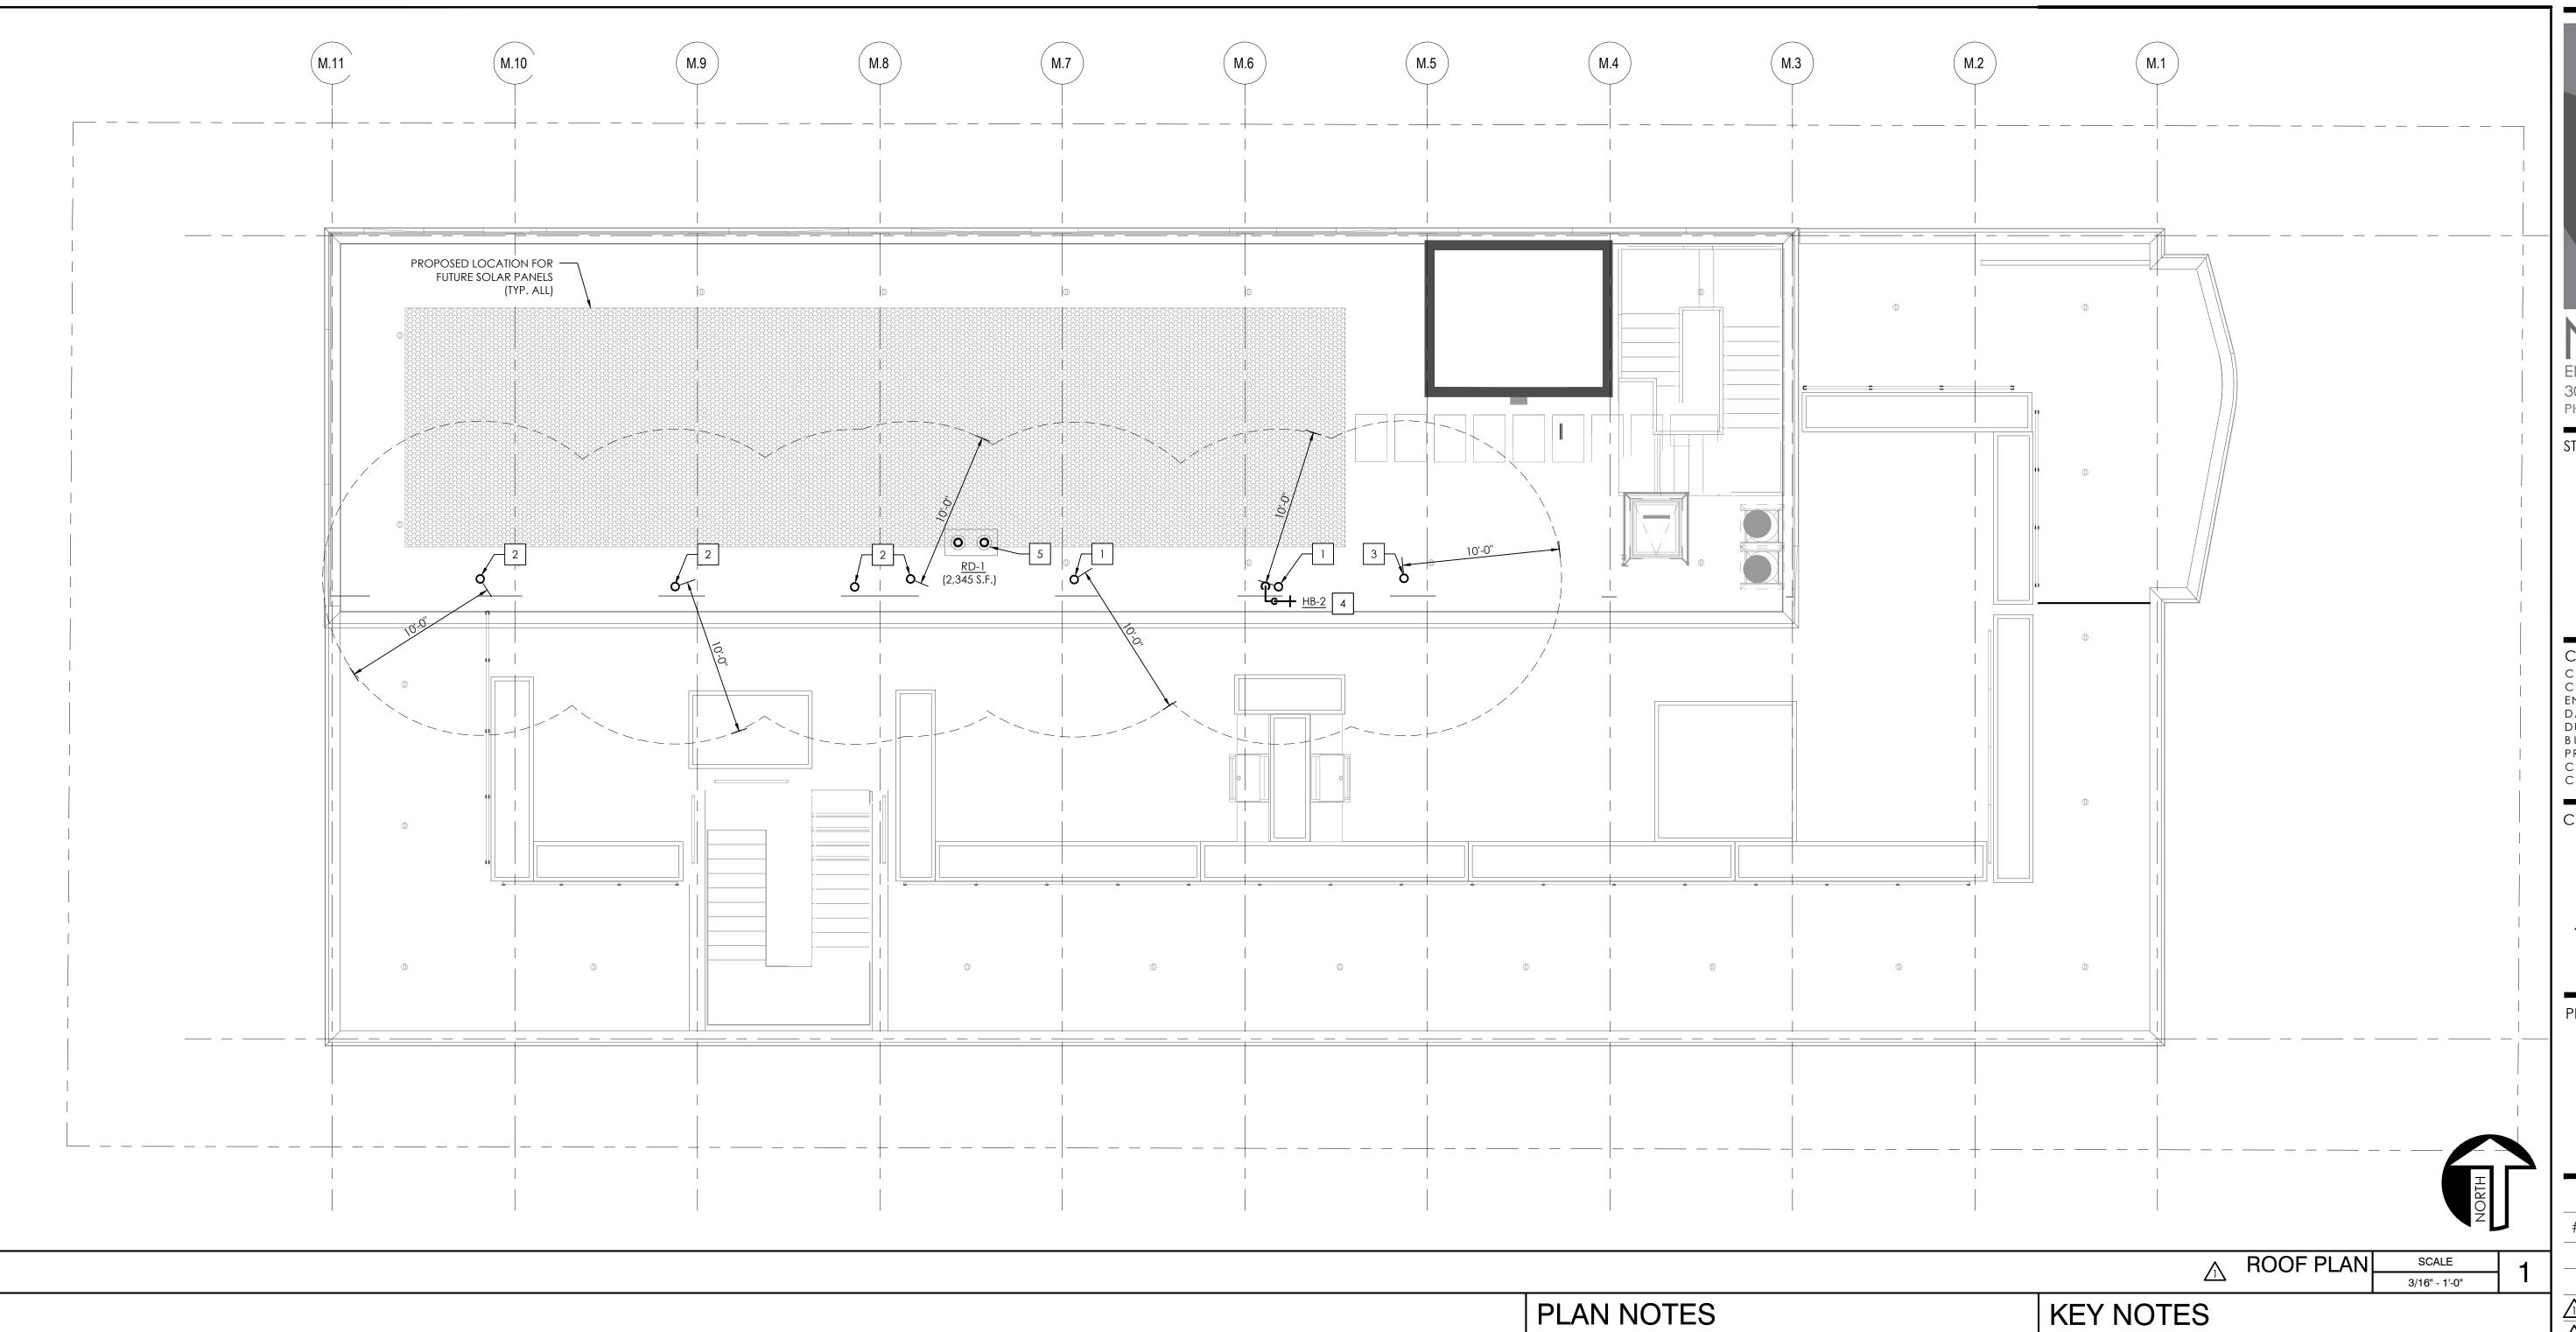
2853 WEST BLVD

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		UTILITY COORDINATION	04/08/22
	$\overline{\Lambda}$	PC RESUBMITTAL	05/18/22
	2	PC RESUBMITTAL	10/28/22
	3	HCD REVISION 1	12/16/22
	4	PC RESUBMITTAL	02/02/23
	<u></u>	HCD & PC RESUBMITTAL	06/06/23
		HCD RESUBMITTAL	06/14/23
	$\overline{\mathbb{A}}$	PC RESUBMITTAL	07/10/23
	8	CLIENT REVISIONS	07/11/23
7		CLIENT REVISIONS	08/04/23
	10	PC RESUBMITTAL (ELEC)	09/12/23
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	1	CLIENT REVISIONS	10/12/23
10 7	Plot	Date: 10/11/2023	5:00:32 PM

SHEET TITLE:

LEVEL 6 DOMESTIC WASTE AND VENT PLAN



A. ALL VENTS THRU ROOF TO MAINTAIN MIN. 10 FT. CLEARANCE FROM ANY OUTSIDE AIR

- B. ALL STORM DRAIN AND OVERFLOW PIPING SIZED PER CPC TABLE 1101.7 (RAINFALL RATE OF 2 IN/HR).
- I. INSTALL ALL HOSE BIBBS 18" CLEAR ABOVE ROOF SURFACE U.O.N.
- # NUMBERS INDICATE NOTES SHOWN ON PLAN
- 1. 2" VENT THRU ROOF. REFER TO DETAIL 1/P501. MAINTAIN 12" MIN. CLEARANCE FROM future solar panels as shown.

- FUTURE SOLAR PANELS AS SHOWN.
- 5. ROUTE 3" SD/OD DOWN INSIDE LEVEL 6 MECHANICAL CHASE. SEE SHEET P116 FOR
- 2. 3" VENT THRU ROOF. REFER TO DETAIL 1/P501. MAINTAIN 12" MIN. CLEARANCE FROM FUTURE SOLAR PANELS AS SHOWN.
- 3. 4" VENT THRU ROOF. REFER TO DETAIL 1/P501. MAINTAIN 12" MIN. CLEARANCE FROM
- 4. 1/2" CW SUPPLY FOR <u>HB-2</u>.
- CONTINUATION.



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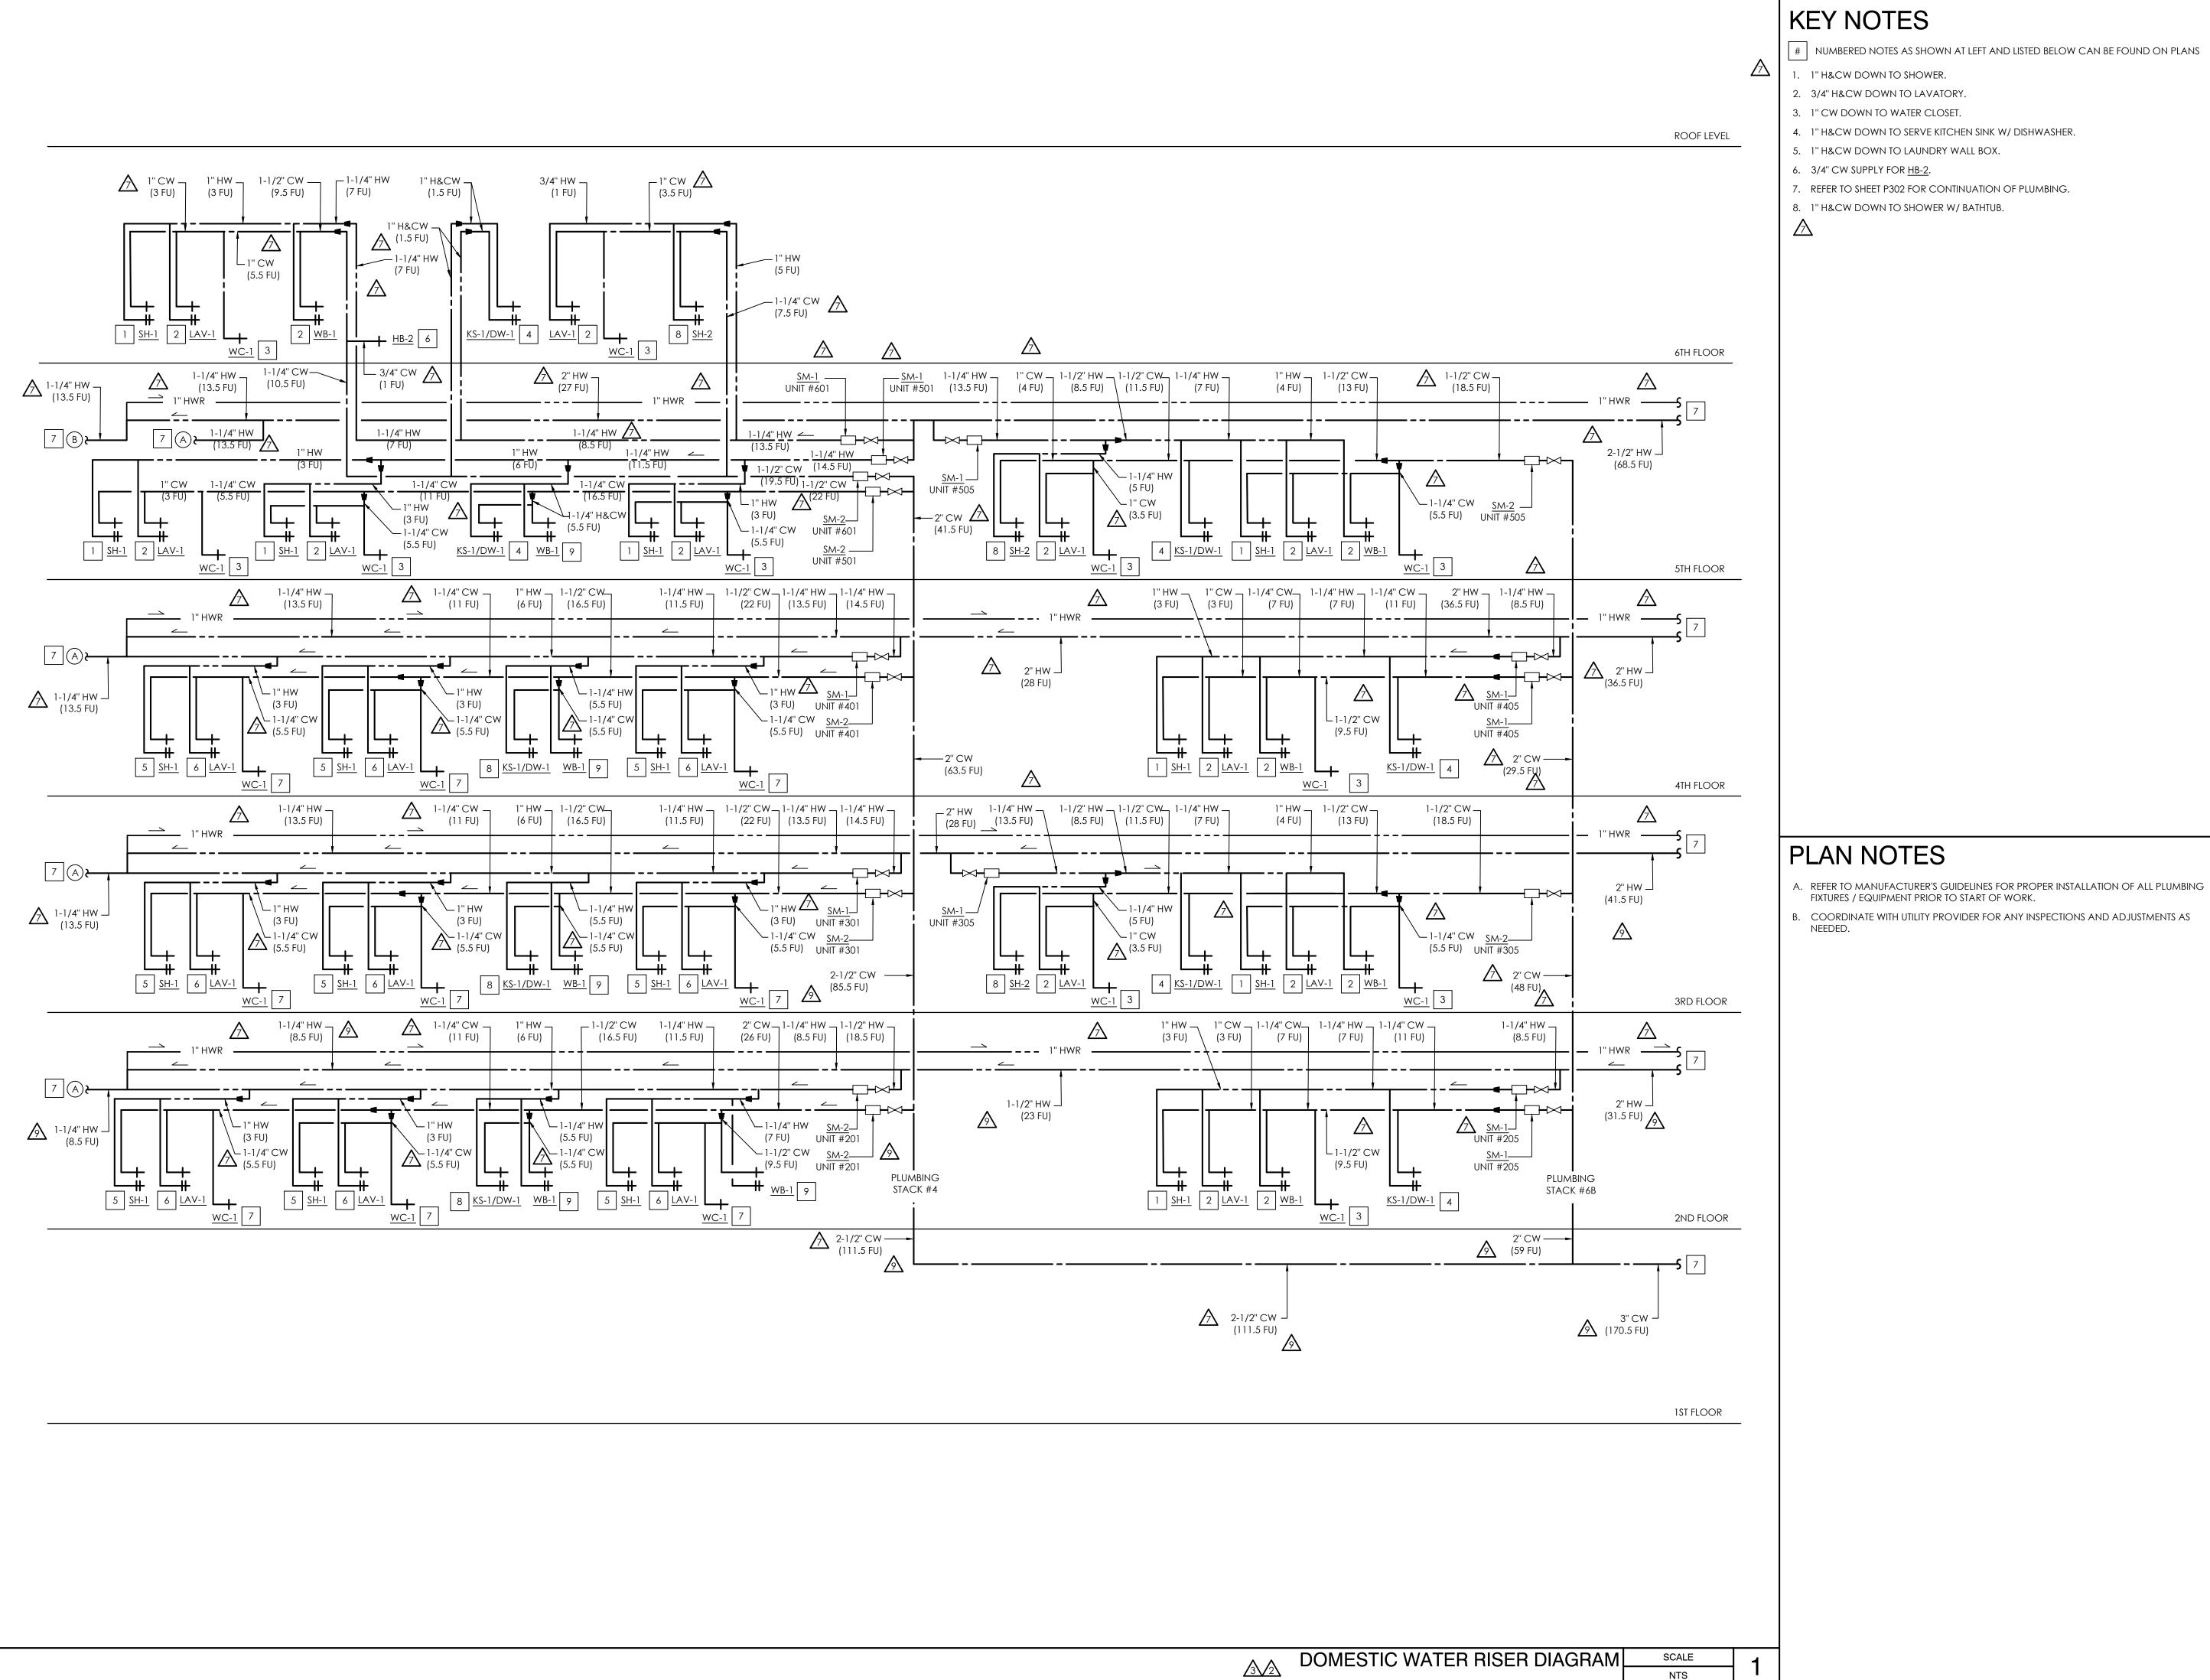
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#	DESCRIPTION	DATE
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	UTILITY COORDINATION	04/08/22
$\overline{\Lambda}$	PC RESUBMITTAL	05/18/22
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19	PC RESUBMITTAL (ELEC)	09/12/23
$\overline{\mathbb{A}}$	PC RESUBMITTAL (ELEC)	10/05/23
<u>12</u>	CLIENT REVISIONS	10/12/23

ROOF PLAN



| NUMBERED NOTES AS SHOWN AT LEFT AND LISTED BELOW CAN BE FOUND ON PLANS

- 1. 1" H&CW DOWN TO SHOWER.
- 2. 3/4" H&CW DOWN TO LAVATORY.
- 3. 1" CW DOWN TO WATER CLOSET.
- 4. 1" H&CW DOWN TO SERVE KITCHEN SINK W/ DISHWASHER.
- 5. 1" H&CW DOWN TO LAUNDRY WALL BOX.
- 6. 3/4" CW SUPPLY FOR HB-2.
- 7. REFER TO SHEET P302 FOR CONTINUATION OF PLUMBING.
- 8. 1" H&CW DOWN TO SHOWER W/ BATHTUB.





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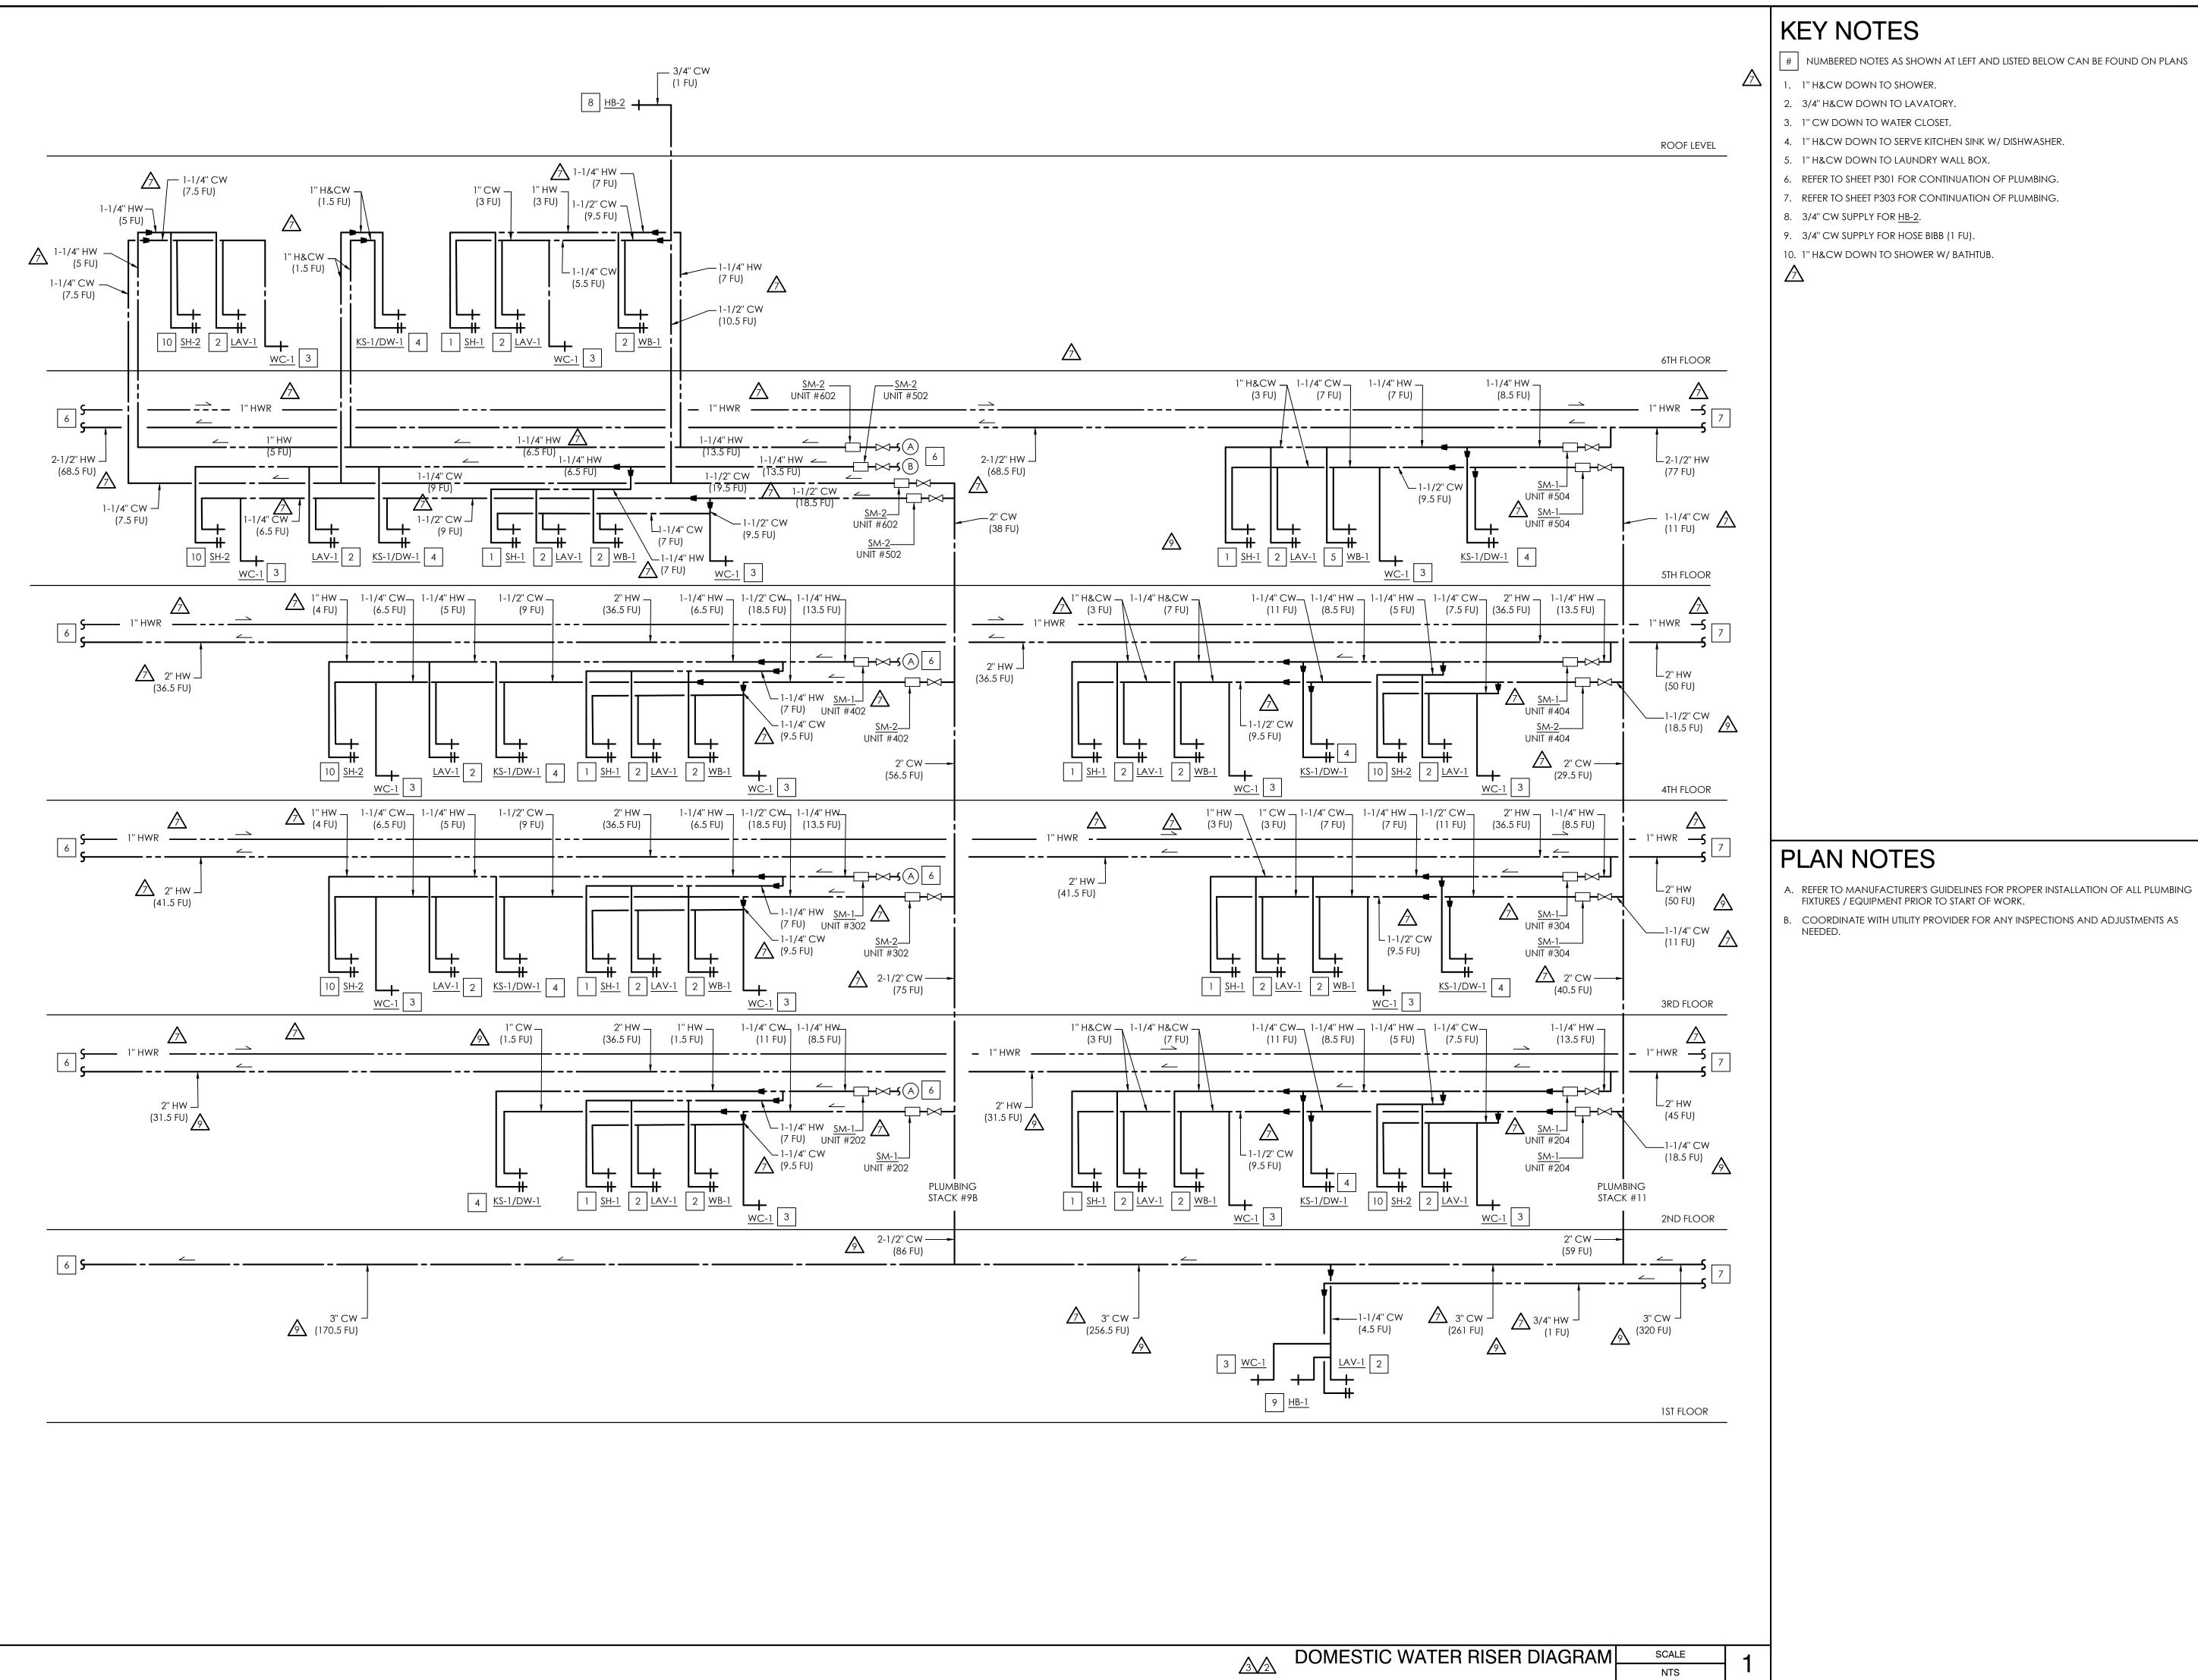
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Ø\	CLIENT REVISIONS	08/04/23
10	PC RESUBMITTAL (ELEC)	09/12/23
$\overline{\mathbb{A}}$	PC RESUBMITTAL (ELEC)	10/05/23
<u>12</u>	CLIENT REVISIONS	10/12/23
Plot	Date: 10/11/2023	4:59:04 PN

RISER DIAGRAMS

SHEET NO:

SHEET TITLE:



| NUMBERED NOTES AS SHOWN AT LEFT AND LISTED BELOW CAN BE FOUND ON PLANS

- 1. 1" H&CW DOWN TO SHOWER.
- 2. 3/4" H&CW DOWN TO LAVATORY.
- 3. 1" CW DOWN TO WATER CLOSET.
- 4. 1" H&CW DOWN TO SERVE KITCHEN SINK W/ DISHWASHER.
- 5. 1" H&CW DOWN TO LAUNDRY WALL BOX.
- 6. REFER TO SHEET P301 FOR CONTINUATION OF PLUMBING.
- 7. REFER TO SHEET P303 FOR CONTINUATION OF PLUMBING.
- 8. 3/4" CW SUPPLY FOR <u>HB-2</u>.
- 9. 3/4" CW SUPPLY FOR HOSE BIBB (1 FU).
- 10. 1" H&CW DOWN TO SHOWER W/ BATHTUB.

FIXTURES / EQUIPMENT PRIOR TO START OF WORK.





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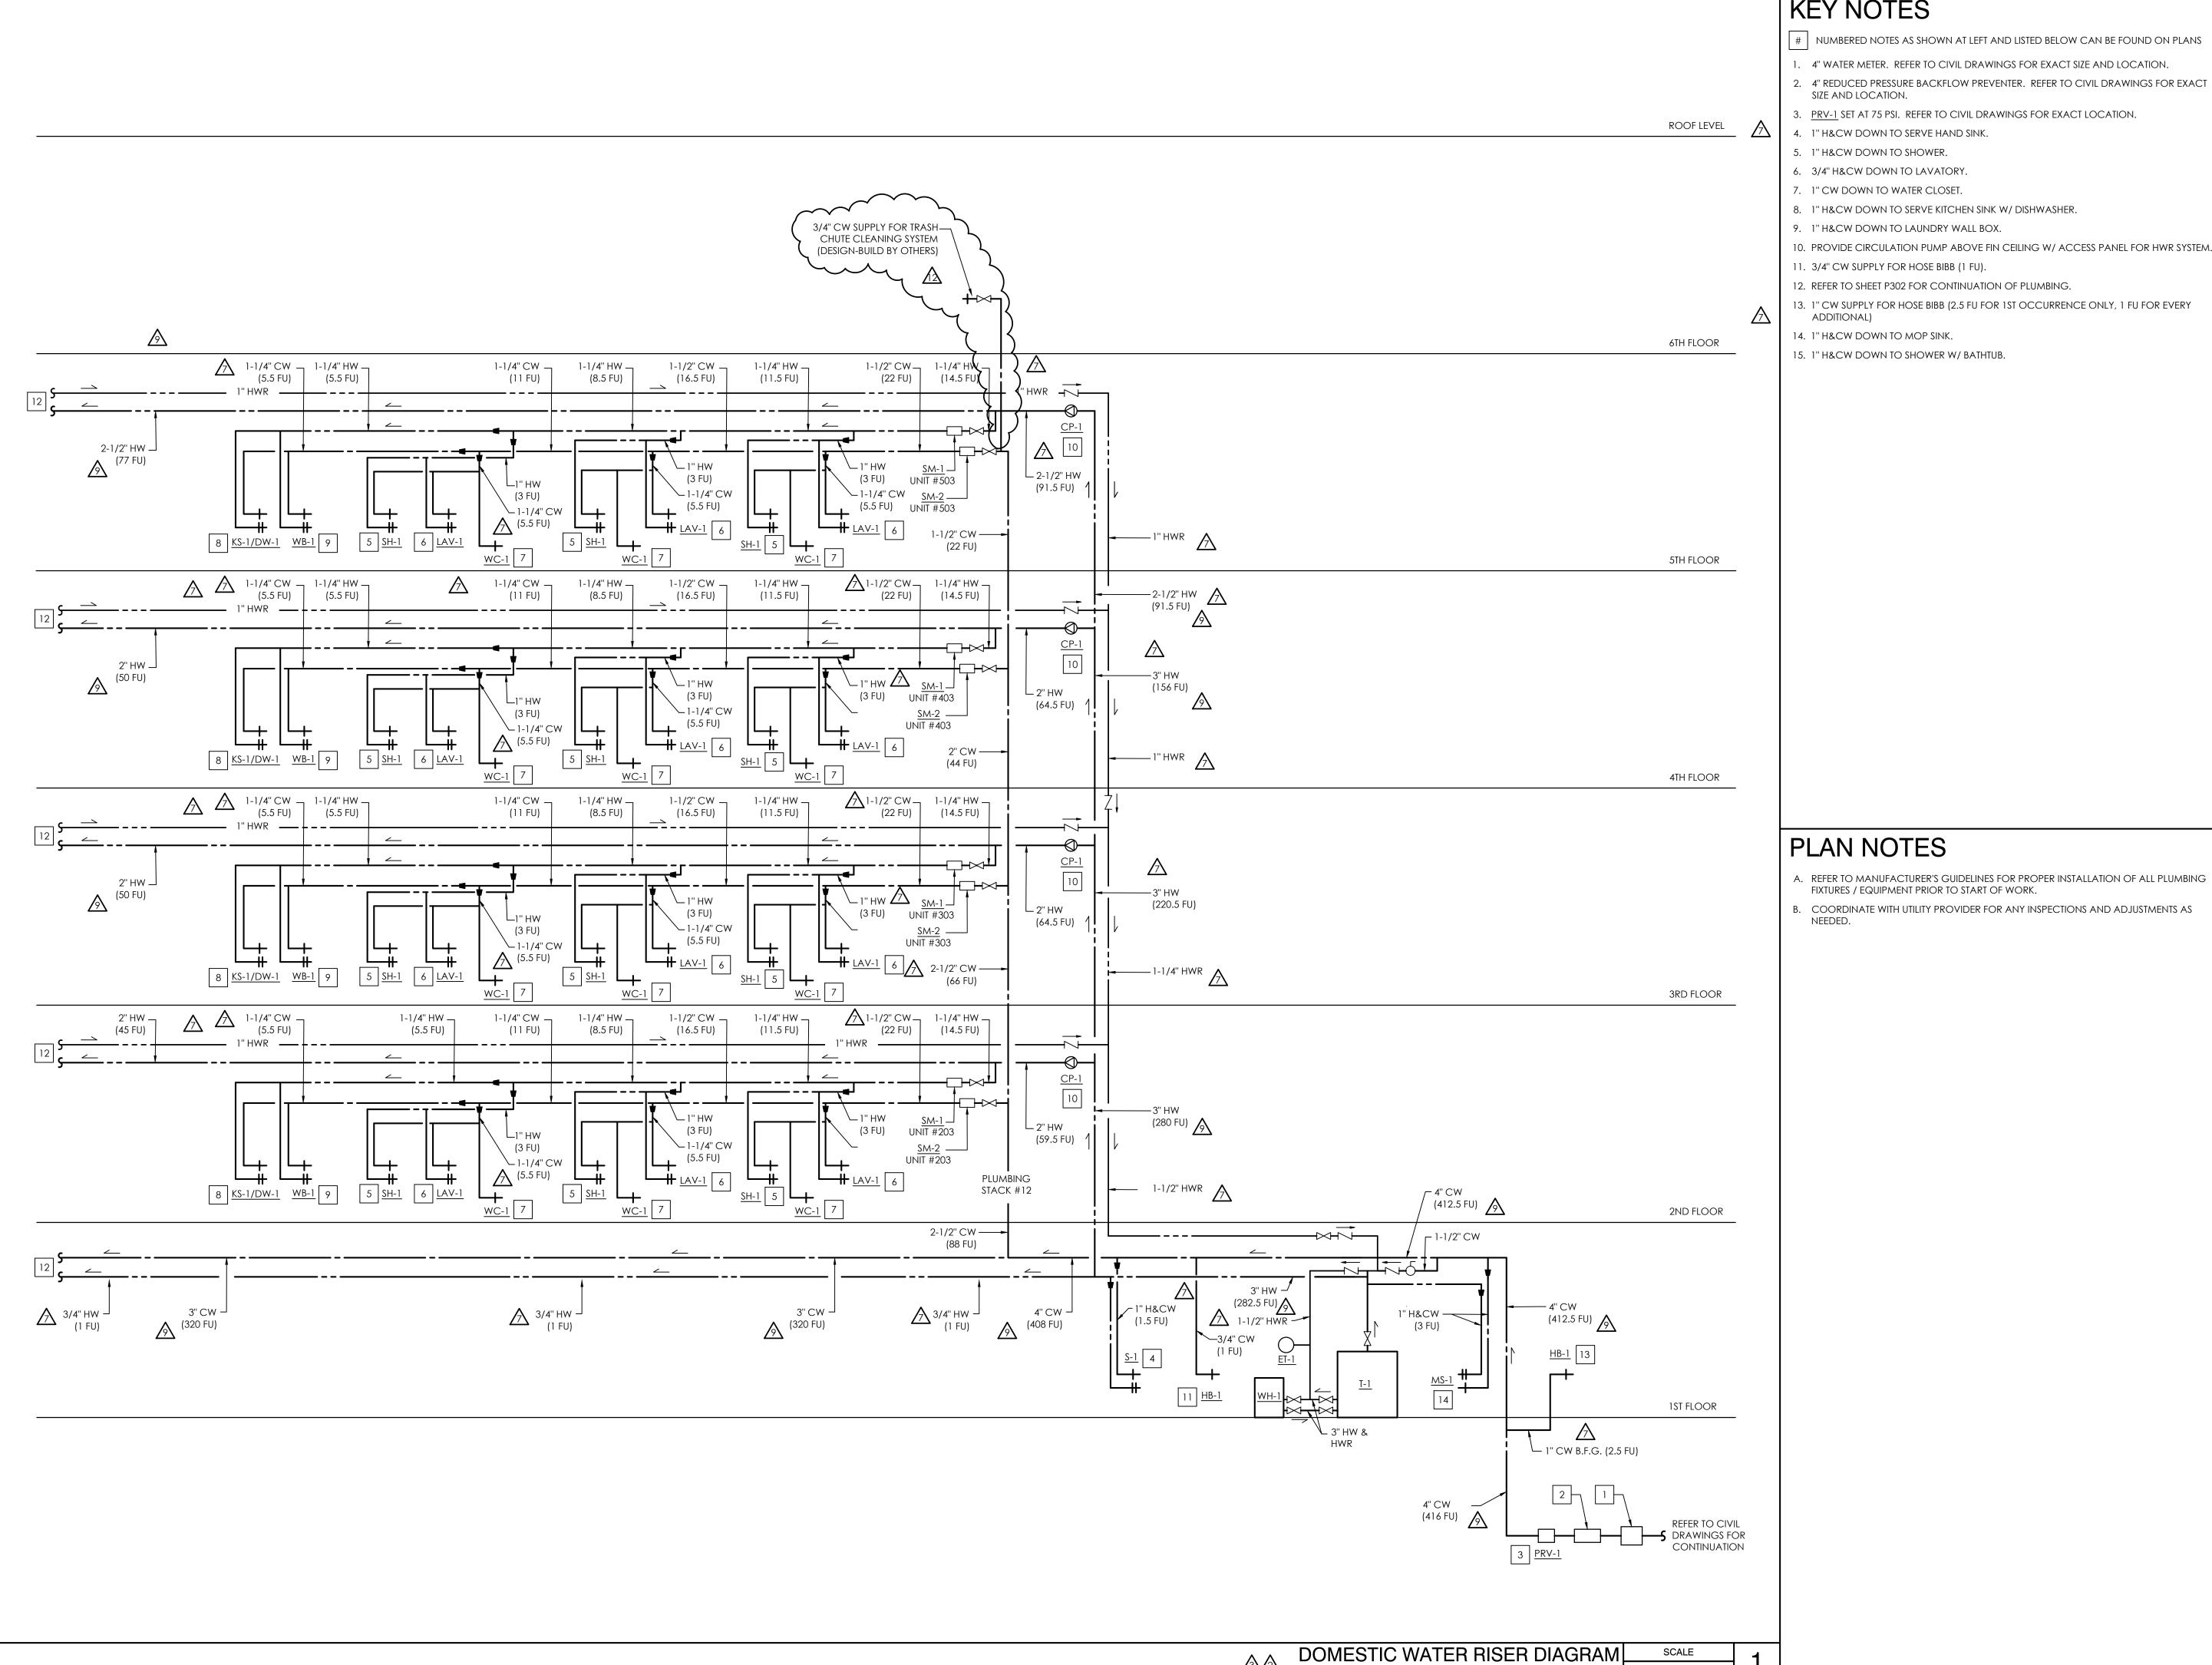
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4	PC RESUBMITTAL	02/02/23			
<u></u>	HCD & PC RESUBMITTAL	06/06/23			
<u></u>	HCD RESUBMITTAL	06/14/23			
\triangle	PC RESUBMITTAL	07/10/23			
8	CLIENT REVISIONS	07/11/23			
Image: Control of the	CLIENT REVISIONS	08/04/23			
10	PC RESUBMITTAL (ELEC)	09/12/23			
$\overline{\mathbb{A}}$	PC RESUBMITTAL (ELEC)	10/05/23			
△	CLIENT REVISIONS	10/12/23			
Plot	Date: 10/11/2023	5:00:46 PM			

RISER DIAGRAMS

SHEET NO:

SHEET TITLE:



- # NUMBERED NOTES AS SHOWN AT LEFT AND LISTED BELOW CAN BE FOUND ON PLANS
- 1. 4" WATER METER. REFER TO CIVIL DRAWINGS FOR EXACT SIZE AND LOCATION.
- 2. 4" REDUCED PRESSURE BACKFLOW PREVENTER. REFER TO CIVIL DRAWINGS FOR EXACT SIZE AND LOCATION.
- 3. PRV-1 SET AT 75 PSI. REFER TO CIVIL DRAWINGS FOR EXACT LOCATION.
- 4. 1" H&CW DOWN TO SERVE HAND SINK.
- 5. 1" H&CW DOWN TO SHOWER.
- 6. 3/4" H&CW DOWN TO LAVATORY.
- 7. 1" CW DOWN TO WATER CLOSET.
- 8. 1" H&CW DOWN TO SERVE KITCHEN SINK W/ DISHWASHER.
- 9. 1" H&CW DOWN TO LAUNDRY WALL BOX.
- 10. PROVIDE CIRCULATION PUMP ABOVE FIN CEILING W/ ACCESS PANEL FOR HWR SYSTEM.
- 12. REFER TO SHEET P302 FOR CONTINUATION OF PLUMBING.
- 13. 1" CW SUPPLY FOR HOSE BIBB (2.5 FU FOR 1ST OCCURRENCE ONLY, 1 FU FOR EVERY ADDITIONAL)
- 14. 1" H&CW DOWN TO MOP SINK.

NTS

15. 1" H&CW DOWN TO SHOWER W/ BATHTUB.



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CLIENT:

JAIME PARTNERS OF CALIFORNIA, INC.

1050 S. FLOWER STREET LOS ANGELES, CA 90015

PROJECT:

2853 WEST BLVD


LOS ANGELES, CA 90016

	C-JAIME-001				
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	UTILITY COORDINATION	04/08/22			
$\overline{\Lambda}$	PC RESUBMITTAL	05/18/22			
2	PC RESUBMITTAL	10/28/22			
<u>3</u>	HCD REVISION 1	12/16/22			
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<u></u>	HCD RESUBMITTAL	06/14/23			
\triangle	PC RESUBMITTAL	07/10/23			
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Ø\	CLIENT REVISIONS	08/04/23			
10	PC RESUBMITTAL (ELEC)	09/12/23			
$\overline{\mathbb{A}}$	PC RESUBMITTAL (ELEC)	10/05/23			
<u>12</u>	CLIENT REVISIONS	10/12/23			
Plot	Date: 10/11/2023	5:00:49 PM			

RISER DIAGRAMS

SHEET NO:

SHEET TITLE:

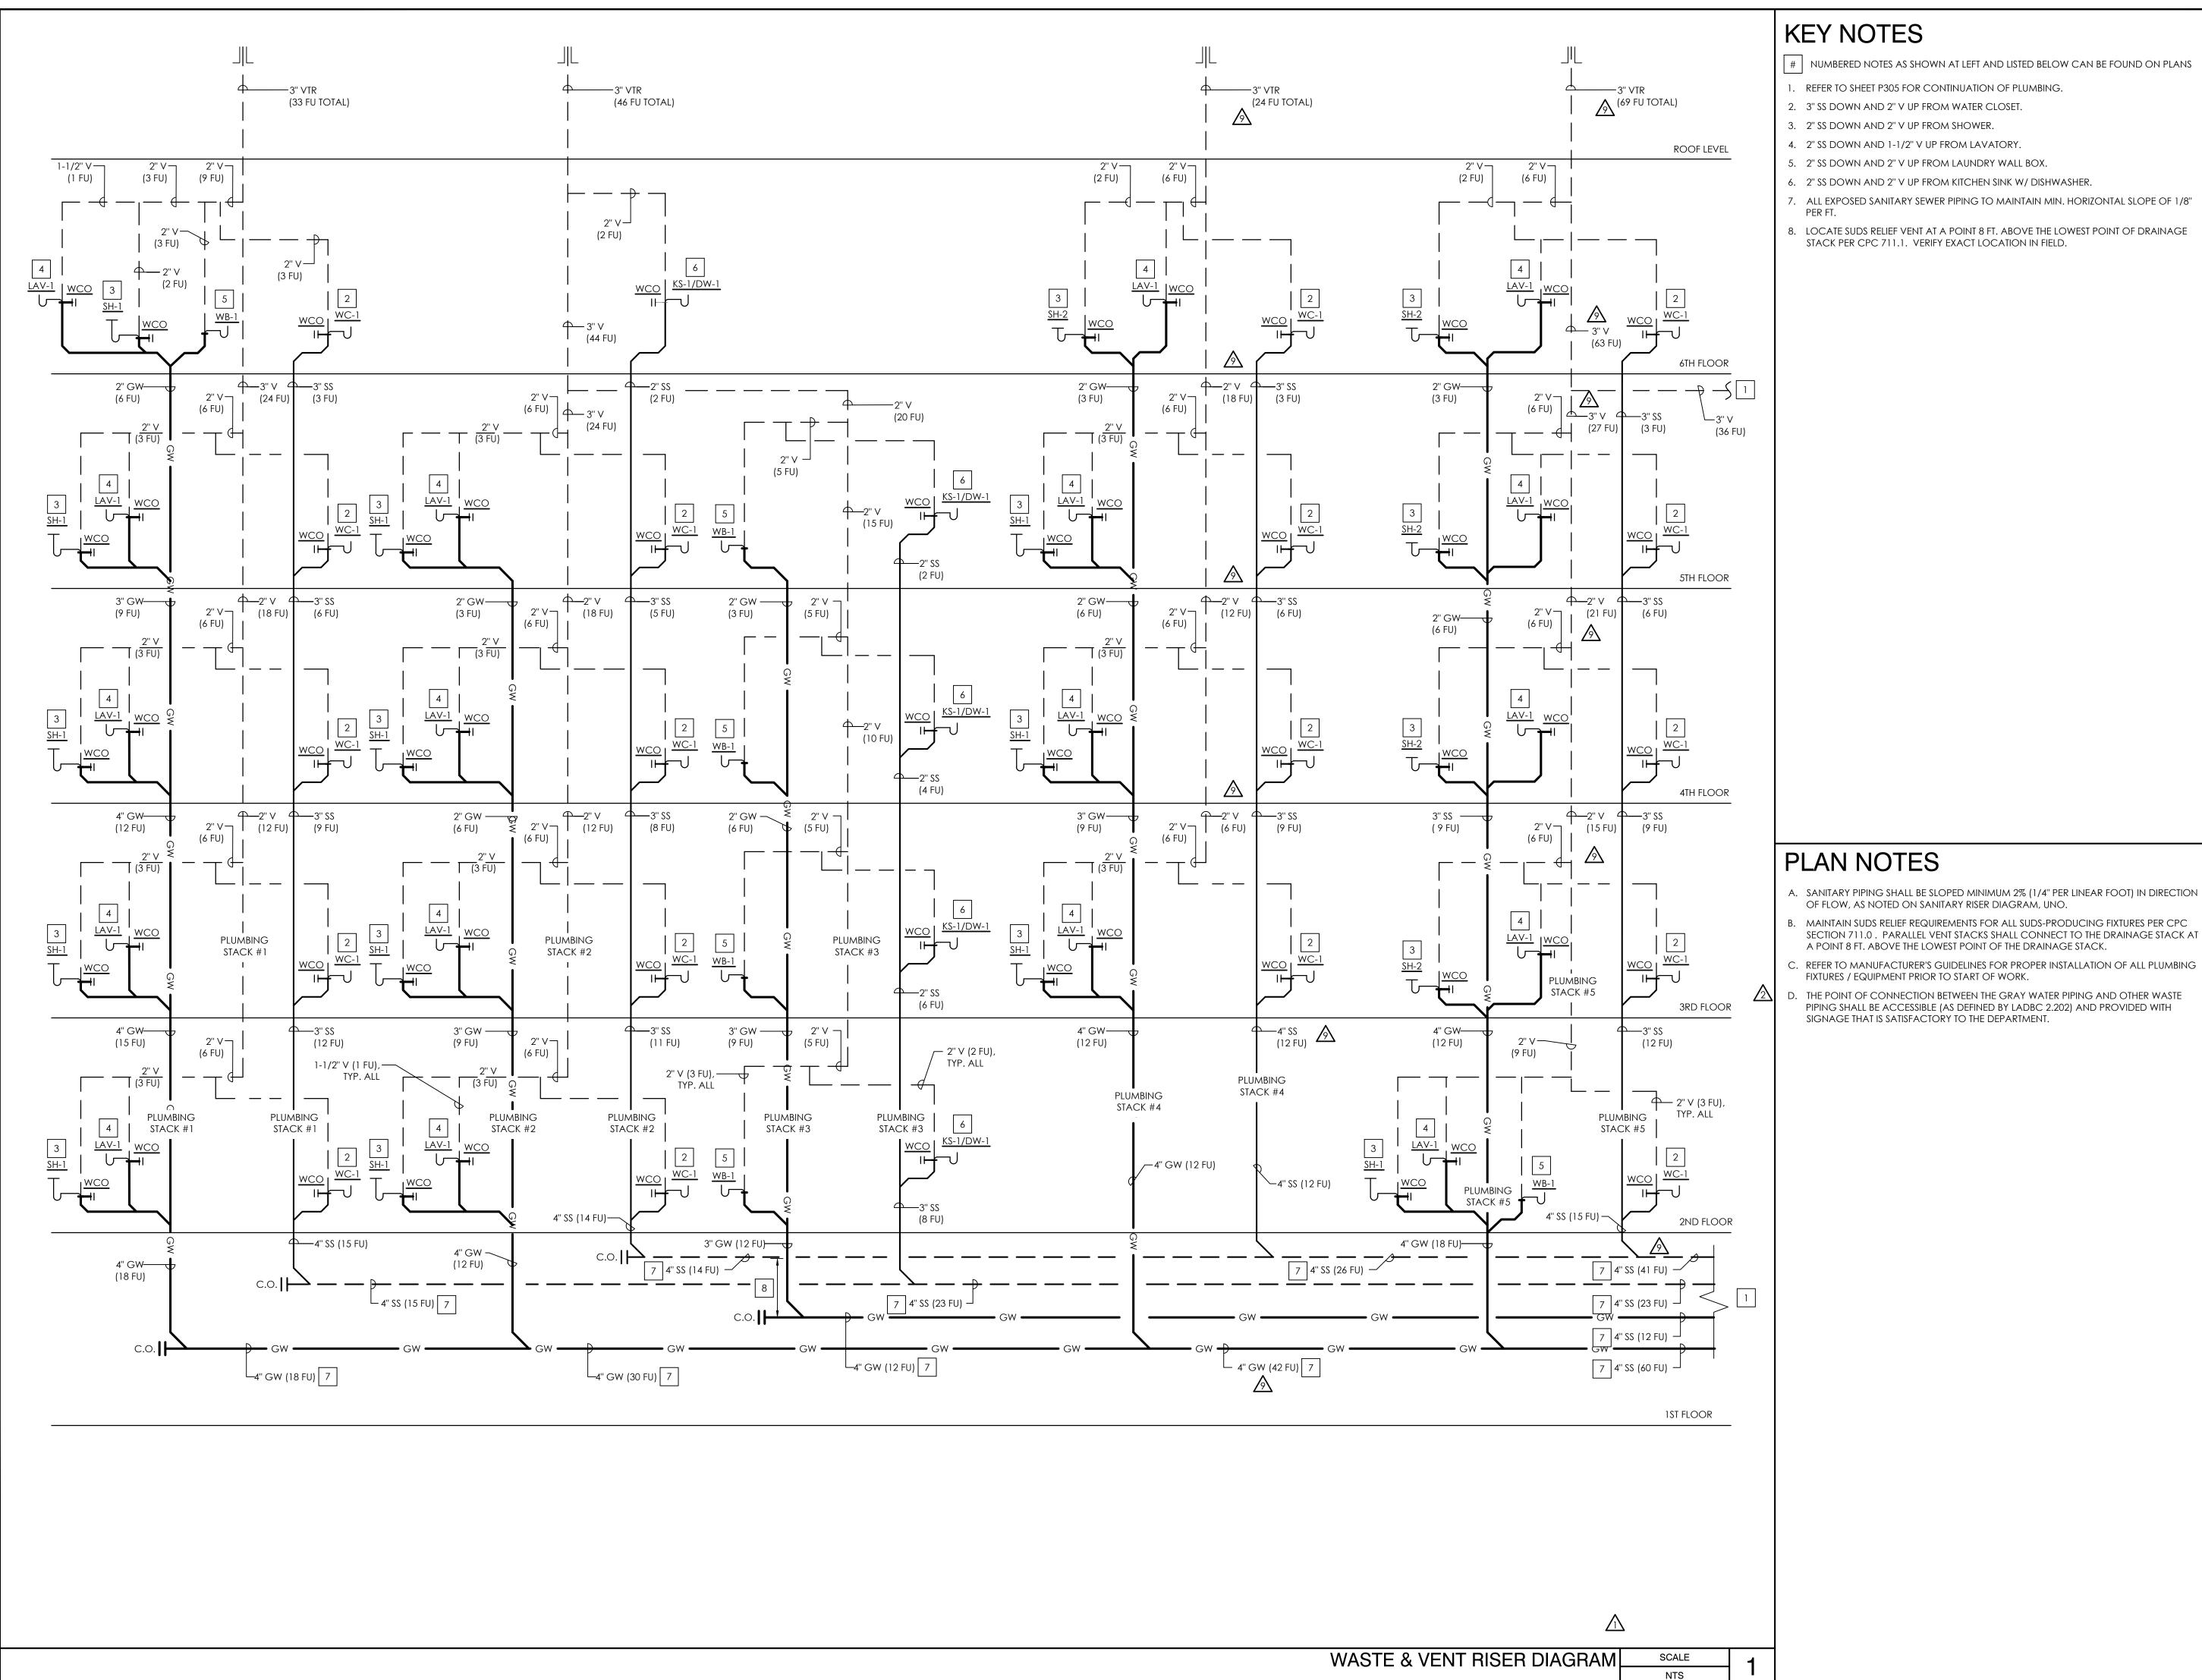

- # | NUMBERED NOTES AS SHOWN AT LEFT AND LISTED BELOW CAN BE FOUND ON PLANS
 - 1. REFER TO SHEET P305 FOR CONTINUATION OF PLUMBING.
- 2. 3" SS DOWN AND 2" V UP FROM WATER CLOSET
- 3. 2" SS DOWN AND 2" V UP FROM SHOWER.
- 4. 2" SS DOWN AND 1-1/2" V UP FROM LAVATORY
- 5. 2" SS DOWN AND 2" V UP FROM LAUNDRY WALL BOX.

OF FLOW, AS NOTED ON SANITARY RISER DIAGRAM, UNO.

FIXTURES / EQUIPMENT PRIOR TO START OF WORK.

SIGNAGE THAT IS SATISFACTORY TO THE DEPARTMENT.

A POINT 8 FT. ABOVE THE LOWEST POINT OF THE DRAINAGE STACK.

SECTION 711.0. PARALLEL VENT STACKS SHALL CONNECT TO THE DRAINAGE STACK AT

REFER TO MANUFACTURER'S GUIDELINES FOR PROPER INSTALLATION OF ALL PLUMBING

PIPING SHALL BE ACCESSIBLE (AS DEFINED BY LADBC 2.202) AND PROVIDED WITH

- 7. ALL EXPOSED SANITARY SEWER PIPING TO MAINTAIN MIN. HORIZONTAL SLOPE OF 1/8"
- 8. LOCATE SUDS RELIEF VENT AT A POINT 8 FT. ABOVE THE LOWEST POINT OF DRAINAGE
- STACK PER CPC 711.1. VERIFY EXACT LOCATION IN FIELD.



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2853 WEST BLVD


LOS ANGELES, CA 90016

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\triangle	CLIENT REVISIONS	08/04/23
<u>10</u>	PC RESUBMITTAL (ELEC)	09/12/23
$\overline{\mathbb{A}}$	PC RESUBMITTAL (ELEC)	10/05/23
<u>/\}</u>	CLIENT REVISIONS	10/12/23

RISER DIAGRAMS

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SHEET TITLE:

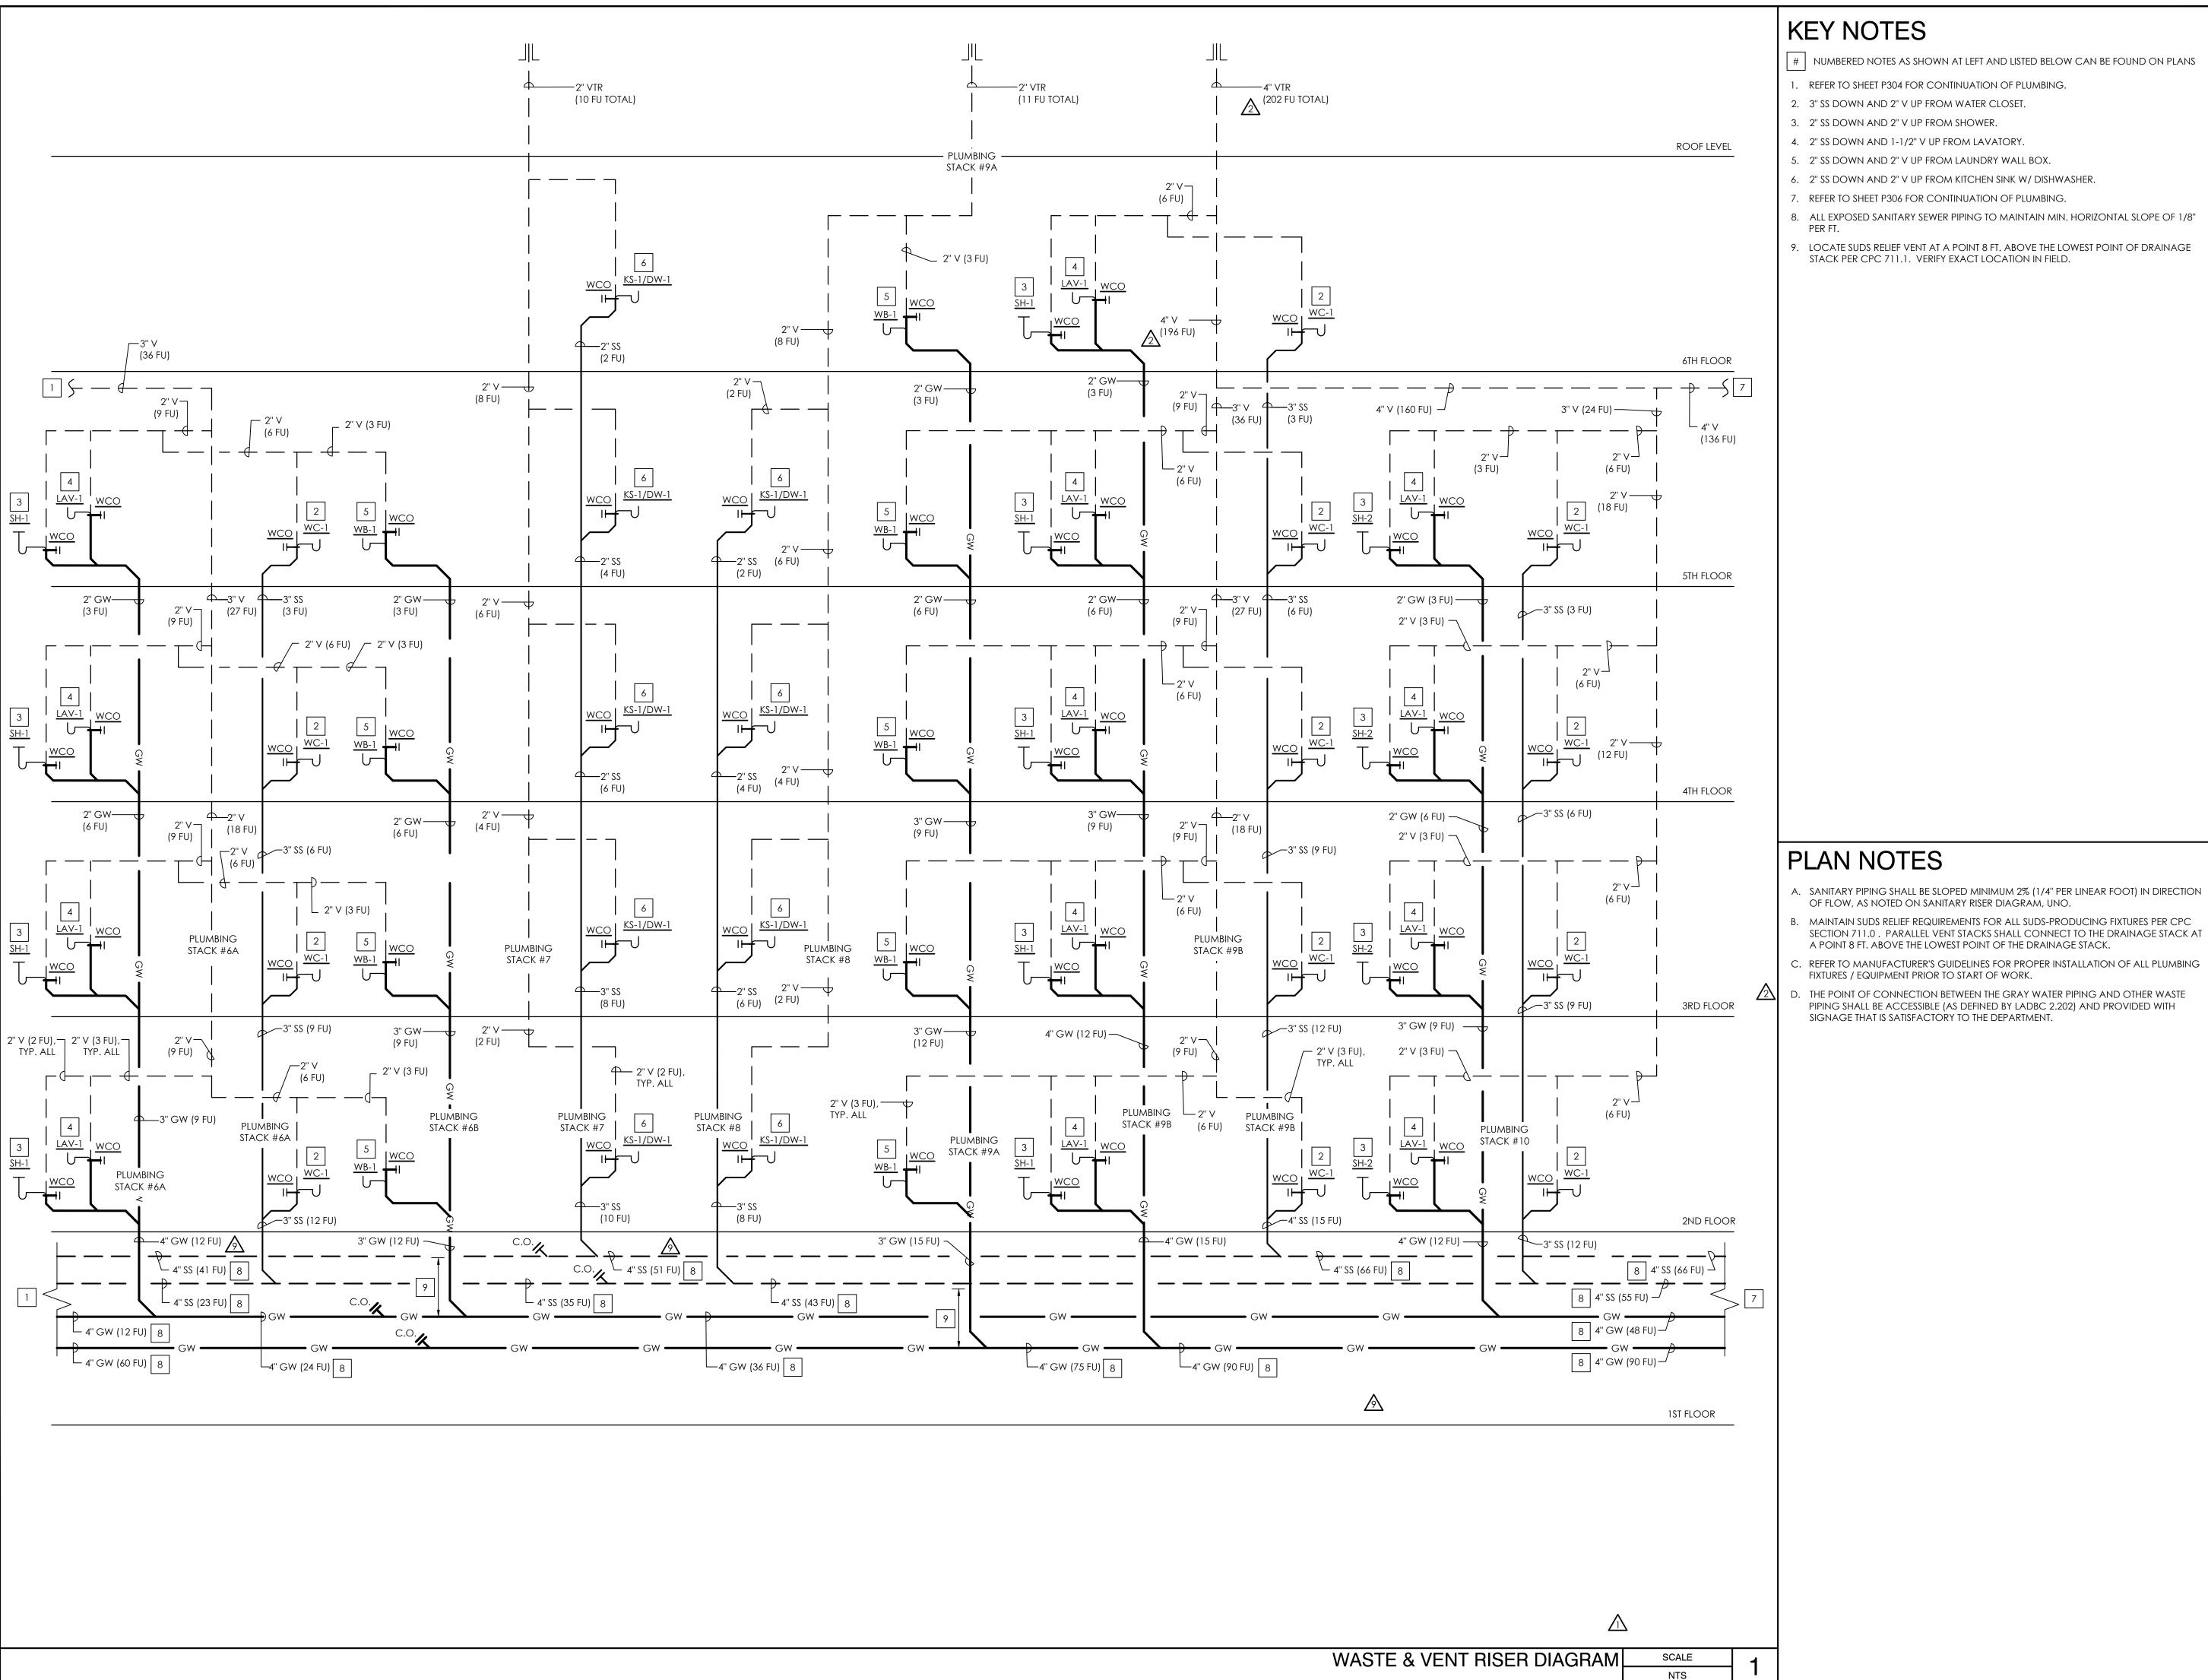

- # | NUMBERED NOTES AS SHOWN AT LEFT AND LISTED BELOW CAN BE FOUND ON PLANS
- 1. REFER TO SHEET P304 FOR CONTINUATION OF PLUMBING.
- 2. 3" SS DOWN AND 2" V UP FROM WATER CLOSET
- 3. 2" SS DOWN AND 2" V UP FROM SHOWER.
- 4. 2" SS DOWN AND 1-1/2" V UP FROM LAVATORY
- 5. 2" SS DOWN AND 2" V UP FROM LAUNDRY WALL BOX.
- 6. 2" SS DOWN AND 2" V UP FROM KITCHEN SINK W/ DISHWASHER.
- 7. REFER TO SHEET P306 FOR CONTINUATION OF PLUMBING.
- 8. ALL EXPOSED SANITARY SEWER PIPING TO MAINTAIN MIN. HORIZONTAL SLOPE OF 1/8"
- 9. LOCATE SUDS RELIEF VENT AT A POINT 8 FT. ABOVE THE LOWEST POINT OF DRAINAGE STACK PER CPC 711.1. VERIFY EXACT LOCATION IN FIELD.



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	CLIENT REVISIONS	10/12/23

RISER DIAGRAMS

SHEET NO:

SHEET TITLE:

ROOF LEVEL

WASTE & VENT RISER DIAGRAM

☐ 3" V (44 FU) (92 FU) (136 FU) (68 FU) (128 FU) / (STACK #11) 6TH FLOOR (6 FU) (STACK #12) (STACK #13 - 3" V (36 FU) (24 FU) (STACK #16) (44 FU) (36 FU) 3 <u>SH-1</u> 3 <u>SH-1</u> (27 FU) --3" SS (3 FU) 5TH FLOOR 2" GW-2" GW — /9 (3 FU) 2" V 🗆 (3 FU) (3 FU) (18 FU) 2" GW — (9 FU) (3 FU) (6 FU) 4 <u>LAV-1</u> 4 <u>LAV-1</u> | <u>LAV-1</u> <u>W(</u> 3 SH-1 4TH FLOOR 2" GW— (6 FU) 2" GW-2" V ¬ | (12 FU) 2" GW — (6 FU) (12 FU) 2" GW — ---3" SS (6 FU) (6 FU) (18 FU) (6 FU) (6 FU) 4 | WCO 4 | WCO S 4 | WCO 3 SH-1 PLUMBING STACK #16 PLUMBING STACK #12B PLUMBING STACK #14 3RD FLOOR 3" GW— (9 FU) 3" GW — (9 FU) (9 FU) 3" GW ~ (9 FU) PLUMBING PLUMBING PLUMBING STACK #16 STACK #14 STACK #12B PLUMBING PLUMBING PLUMBING 4 WCO 4 <u>LAV-1</u> STACK #14 STACK #12B STACK #16 3 <u>SH-1</u> PLUMBING STACK #12A 8 4" SS (66 FU) — _ 4" SS (66 FU) 8 2ND FLOOR 3" GW (12 FU) -−4" GW (12 FU) — 3" SS (12 FU) 4" GW (12 FU) — ---- 3" SS (12 FU) —4" GW (12 FU) 3" SS (12 FU) — - 4" SS (55 FU) 8 —4" GW (48 FU) 8 8 4" GW (24 FU) 8 4" GW (48 FU) 8 4" SS (36 FU) 8 4" SS (48 FU) 4" GW (12 FU) 8 4" SS (12 FU) 8 8 4" SS (24 FU) 8 4" GW (36 FU) — ____ 4" GW (90 FU) 8 6" SS (90 FU) 8 8 6" SS (90 FU) 1ST FLOOR

KEY NOTES

NUMBERED NOTES AS SHOWN AT LEFT AND LISTED BELOW CAN BE FOUND ON PLANS

1. REFER TO SHEET P305 FOR CONTINUATION OF PLUMBING.

- 2. 3" SS DOWN AND 2" V UP FROM WATER CLOSET.
- 3. 2" SS DOWN AND 2" V UP FROM SHOWER.
- 4. 2" SS DOWN AND 1-1/2" V UP FROM LAVATORY.
- 5. 2" SS DOWN AND 2" V UP FROM LAUNDRY WALL BOX.
- 6. 2" SS DOWN AND 2" V UP FROM KITCHEN SINK W/ DISHWASHER.
- ENSURE SUFFICIENT SPACE AT POC TO ALLOW FOR FUTURE DISCONNECTION OF GRAY WATER PIPING FROM BLACKWATER PIPING, CAPPING OF BLACKWATER PIPING AT POD, AND EXTENSION OF GRAY WATER PIPING TO POTENTIAL FUTURE GRAY WATER TREATMENT SYSTEM (DESIGN-BUILD BY OTHERS).
- 8. ALL EXPOSED SANITARY SEWER PIPING TO MAINTAIN MIN. HORIZONTAL SLOPE OF 1/8"
- 9. REFER TO SHEET P307 FOR CONTINUATION OF PLUMBING.



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1050 S. FLOWER STREET LOS ANGELES, CA 90015

PROJECT:

2853 WEST BLVD

LOS ANGELES, CA 90016

	C-JAIME-001	
#	DESCRIPTION	DATE
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$\overline{\triangle}$	PC RESUBMITTAL	05/18/22
2	PC RESUBMITTAL	10/28/22
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$\overline{\mathbb{A}}$	PC RESUBMITTAL (ELEC)	10/05/23
<u> </u>	CLIENT REVISIONS	10/12/23

10/11/2023 5:01:07 PM Plot Date:

RISER DIAGRAMS

SHEET TITLE:

SHEET NO:

P306


A. SANITARY PIPING SHALL BE SLOPED MINIMUM 2% (1/4" PER LINEAR FOOT) IN DIRECTION OF FLOW, AS NOTED ON SANITARY RISER DIAGRAM, UNO.

PLAN NOTES

- B. MAINTAIN SUDS RELIEF REQUIREMENTS FOR ALL SUDS-PRODUCING FIXTURES PER CPC SECTION 711.0. PARALLEL VENT STACKS SHALL CONNECT TO THE DRAINAGE STACK AT A POINT 8 FT. ABOVE THE LOWEST POINT OF THE DRAINAGE STACK.
- C. REFER TO MANUFACTURER'S GUIDELINES FOR PROPER INSTALLATION OF ALL PLUMBING
- FIXTURES / EQUIPMENT PRIOR TO START OF WORK. D. THE POINT OF CONNECTION BETWEEN THE GRAY WATER PIPING AND OTHER WASTE

PIPING SHALL BE ACCESSIBLE (AS DEFINED BY LADBC 2.202) AND PROVIDED WITH

SIGNAGE THAT IS SATISFACTORY TO THE DEPARTMENT.

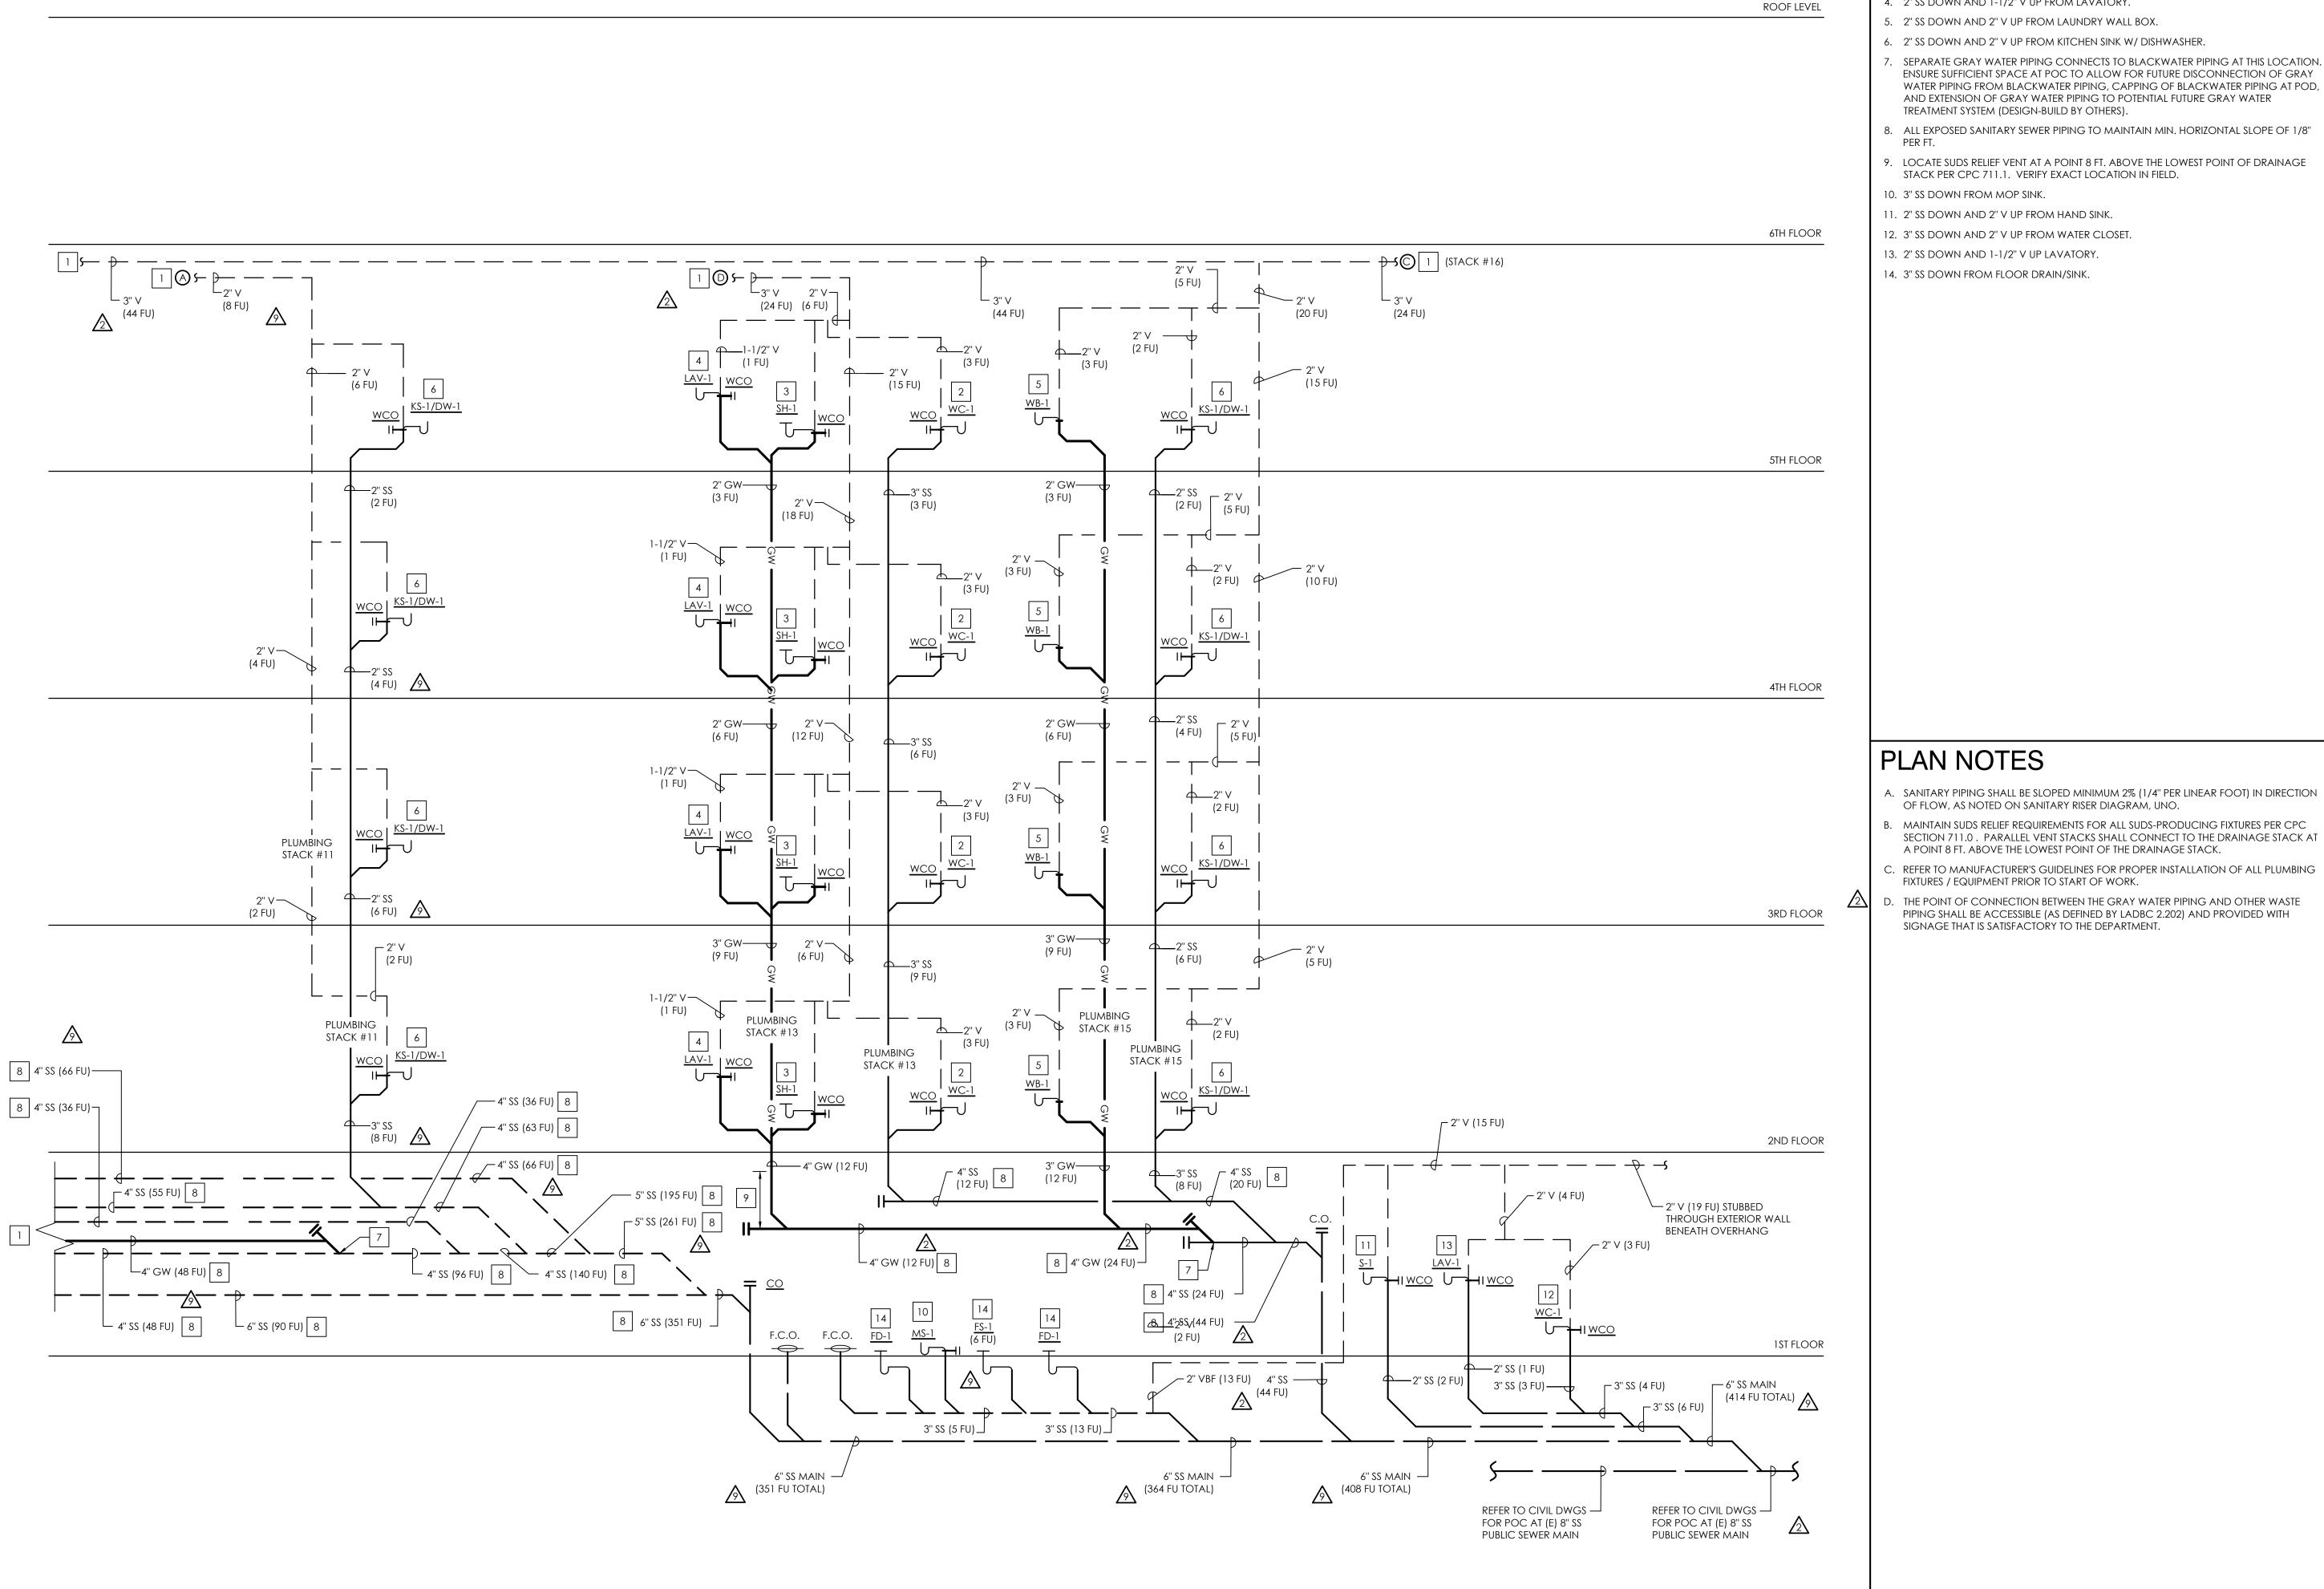

NUMBERED NOTES AS SHOWN AT LEFT AND LISTED BELOW CAN BE FOUND ON PLANS

1. REFER TO SHEET P306 FOR CONTINUATION OF PLUMBING.

- 2. 3" SS DOWN AND 2" V UP FROM WATER CLOSET.
- 3. 2" SS DOWN AND 2" V UP FROM SHOWER.
- 4. 2" SS DOWN AND 1-1/2" V UP FROM LAVATORY.
- 5. 2" SS DOWN AND 2" V UP FROM LAUNDRY WALL BOX.
- 6. 2" SS DOWN AND 2" V UP FROM KITCHEN SINK W/ DISHWASHER.
- 7. SEPARATE GRAY WATER PIPING CONNECTS TO BLACKWATER PIPING AT THIS LOCATION. ENSURE SUFFICIENT SPACE AT POC TO ALLOW FOR FUTURE DISCONNECTION OF GRAY WATER PIPING FROM BLACKWATER PIPING, CAPPING OF BLACKWATER PIPING AT POD, AND EXTENSION OF GRAY WATER PIPING TO POTENTIAL FUTURE GRAY WATER TREATMENT SYSTEM (DESIGN-BUILD BY OTHERS).
- 8. ALL EXPOSED SANITARY SEWER PIPING TO MAINTAIN MIN. HORIZONTAL SLOPE OF 1/8"
- 9. LOCATE SUDS RELIEF VENT AT A POINT 8 FT. ABOVE THE LOWEST POINT OF DRAINAGE STACK PER CPC 711.1. VERIFY EXACT LOCATION IN FIELD.
- 10. 3" SS DOWN FROM MOP SINK.

WASTE & VENT RISER DIAGRAM

NTS

- 11. 2" SS DOWN AND 2" V UP FROM HAND SINK.
- 12. 3" SS DOWN AND 2" V UP FROM WATER CLOSET.
- 13. 2" SS DOWN AND 1-1/2" V UP LAVATORY.





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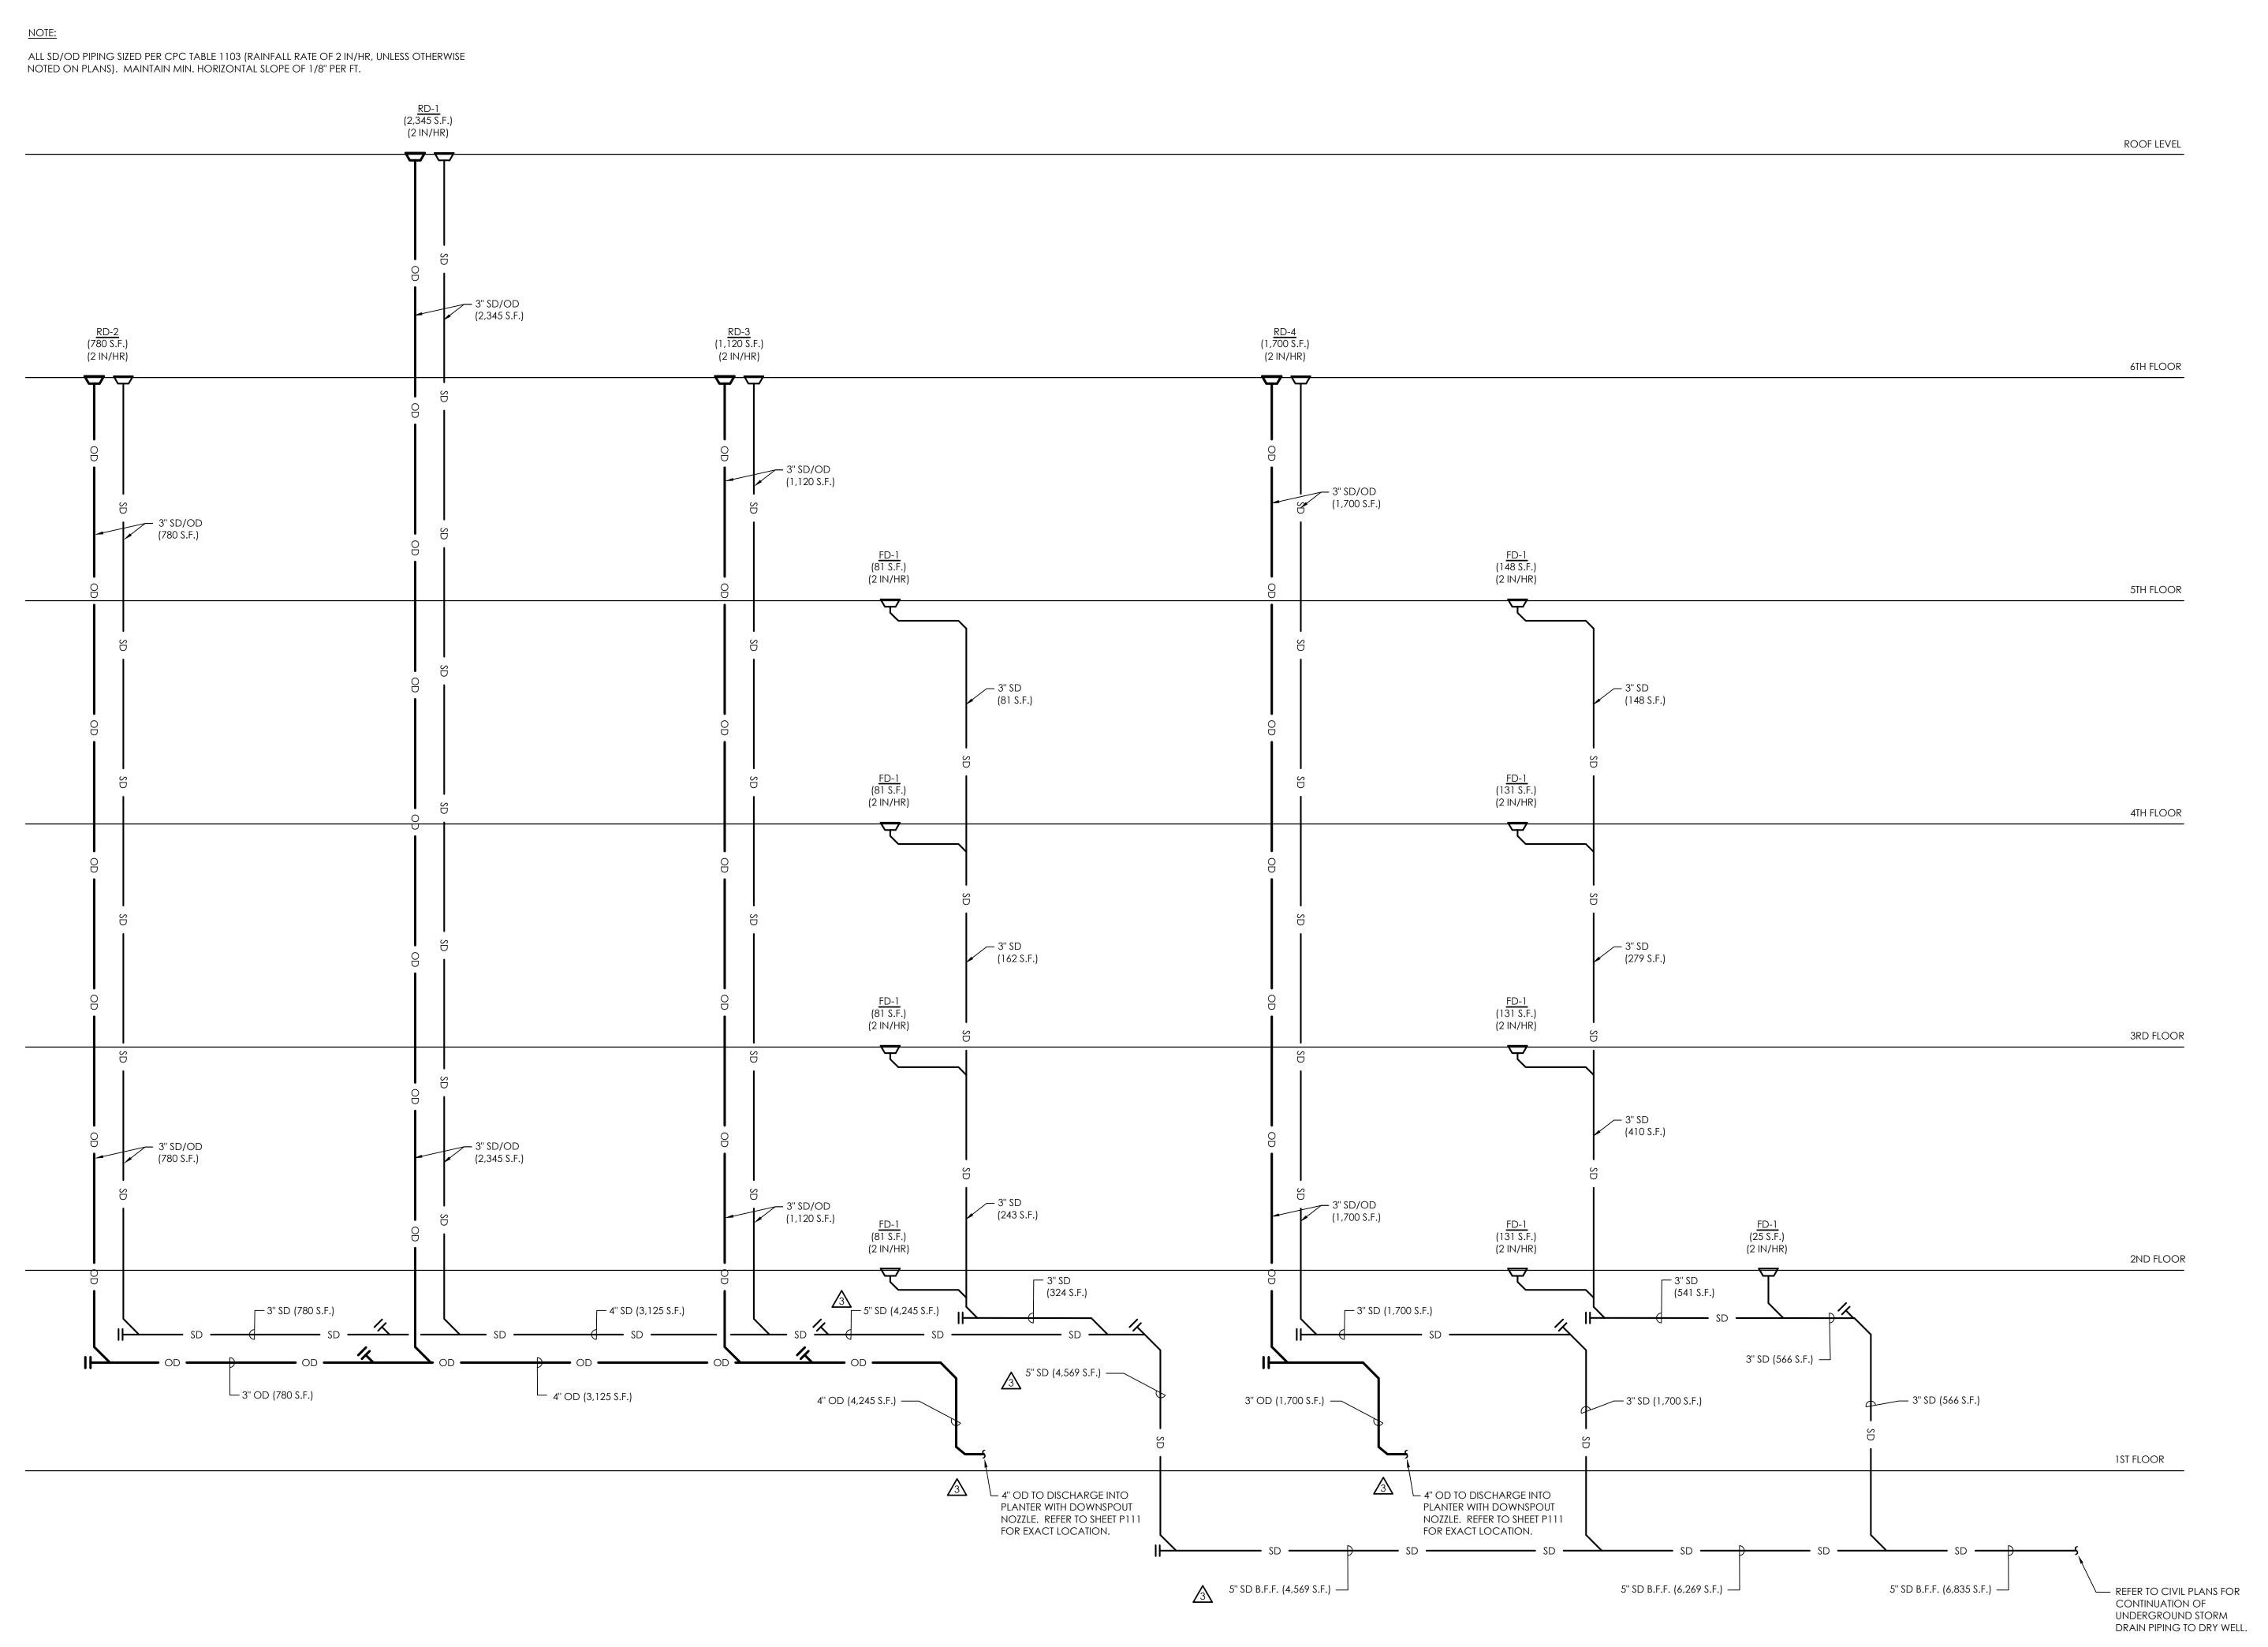
LOS ANGELES, CA 90016

DESCRIPTION 1ST SUBMITTAL UTILITY COORDINATION PC RESUBMITTAL PC RESUBMITTAL HCD REVISION 1	DATE 10/04/21 04/08/22 05/18/22 10/28/22
UTILITY COORDINATION PC RESUBMITTAL PC RESUBMITTAL	04/08/22 05/18/22 10/28/22
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SHEET TITLE:

RISER DIAGRAMS

SHEET NO:





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Plot	Date: 10/11/2023	5:01:21 PM

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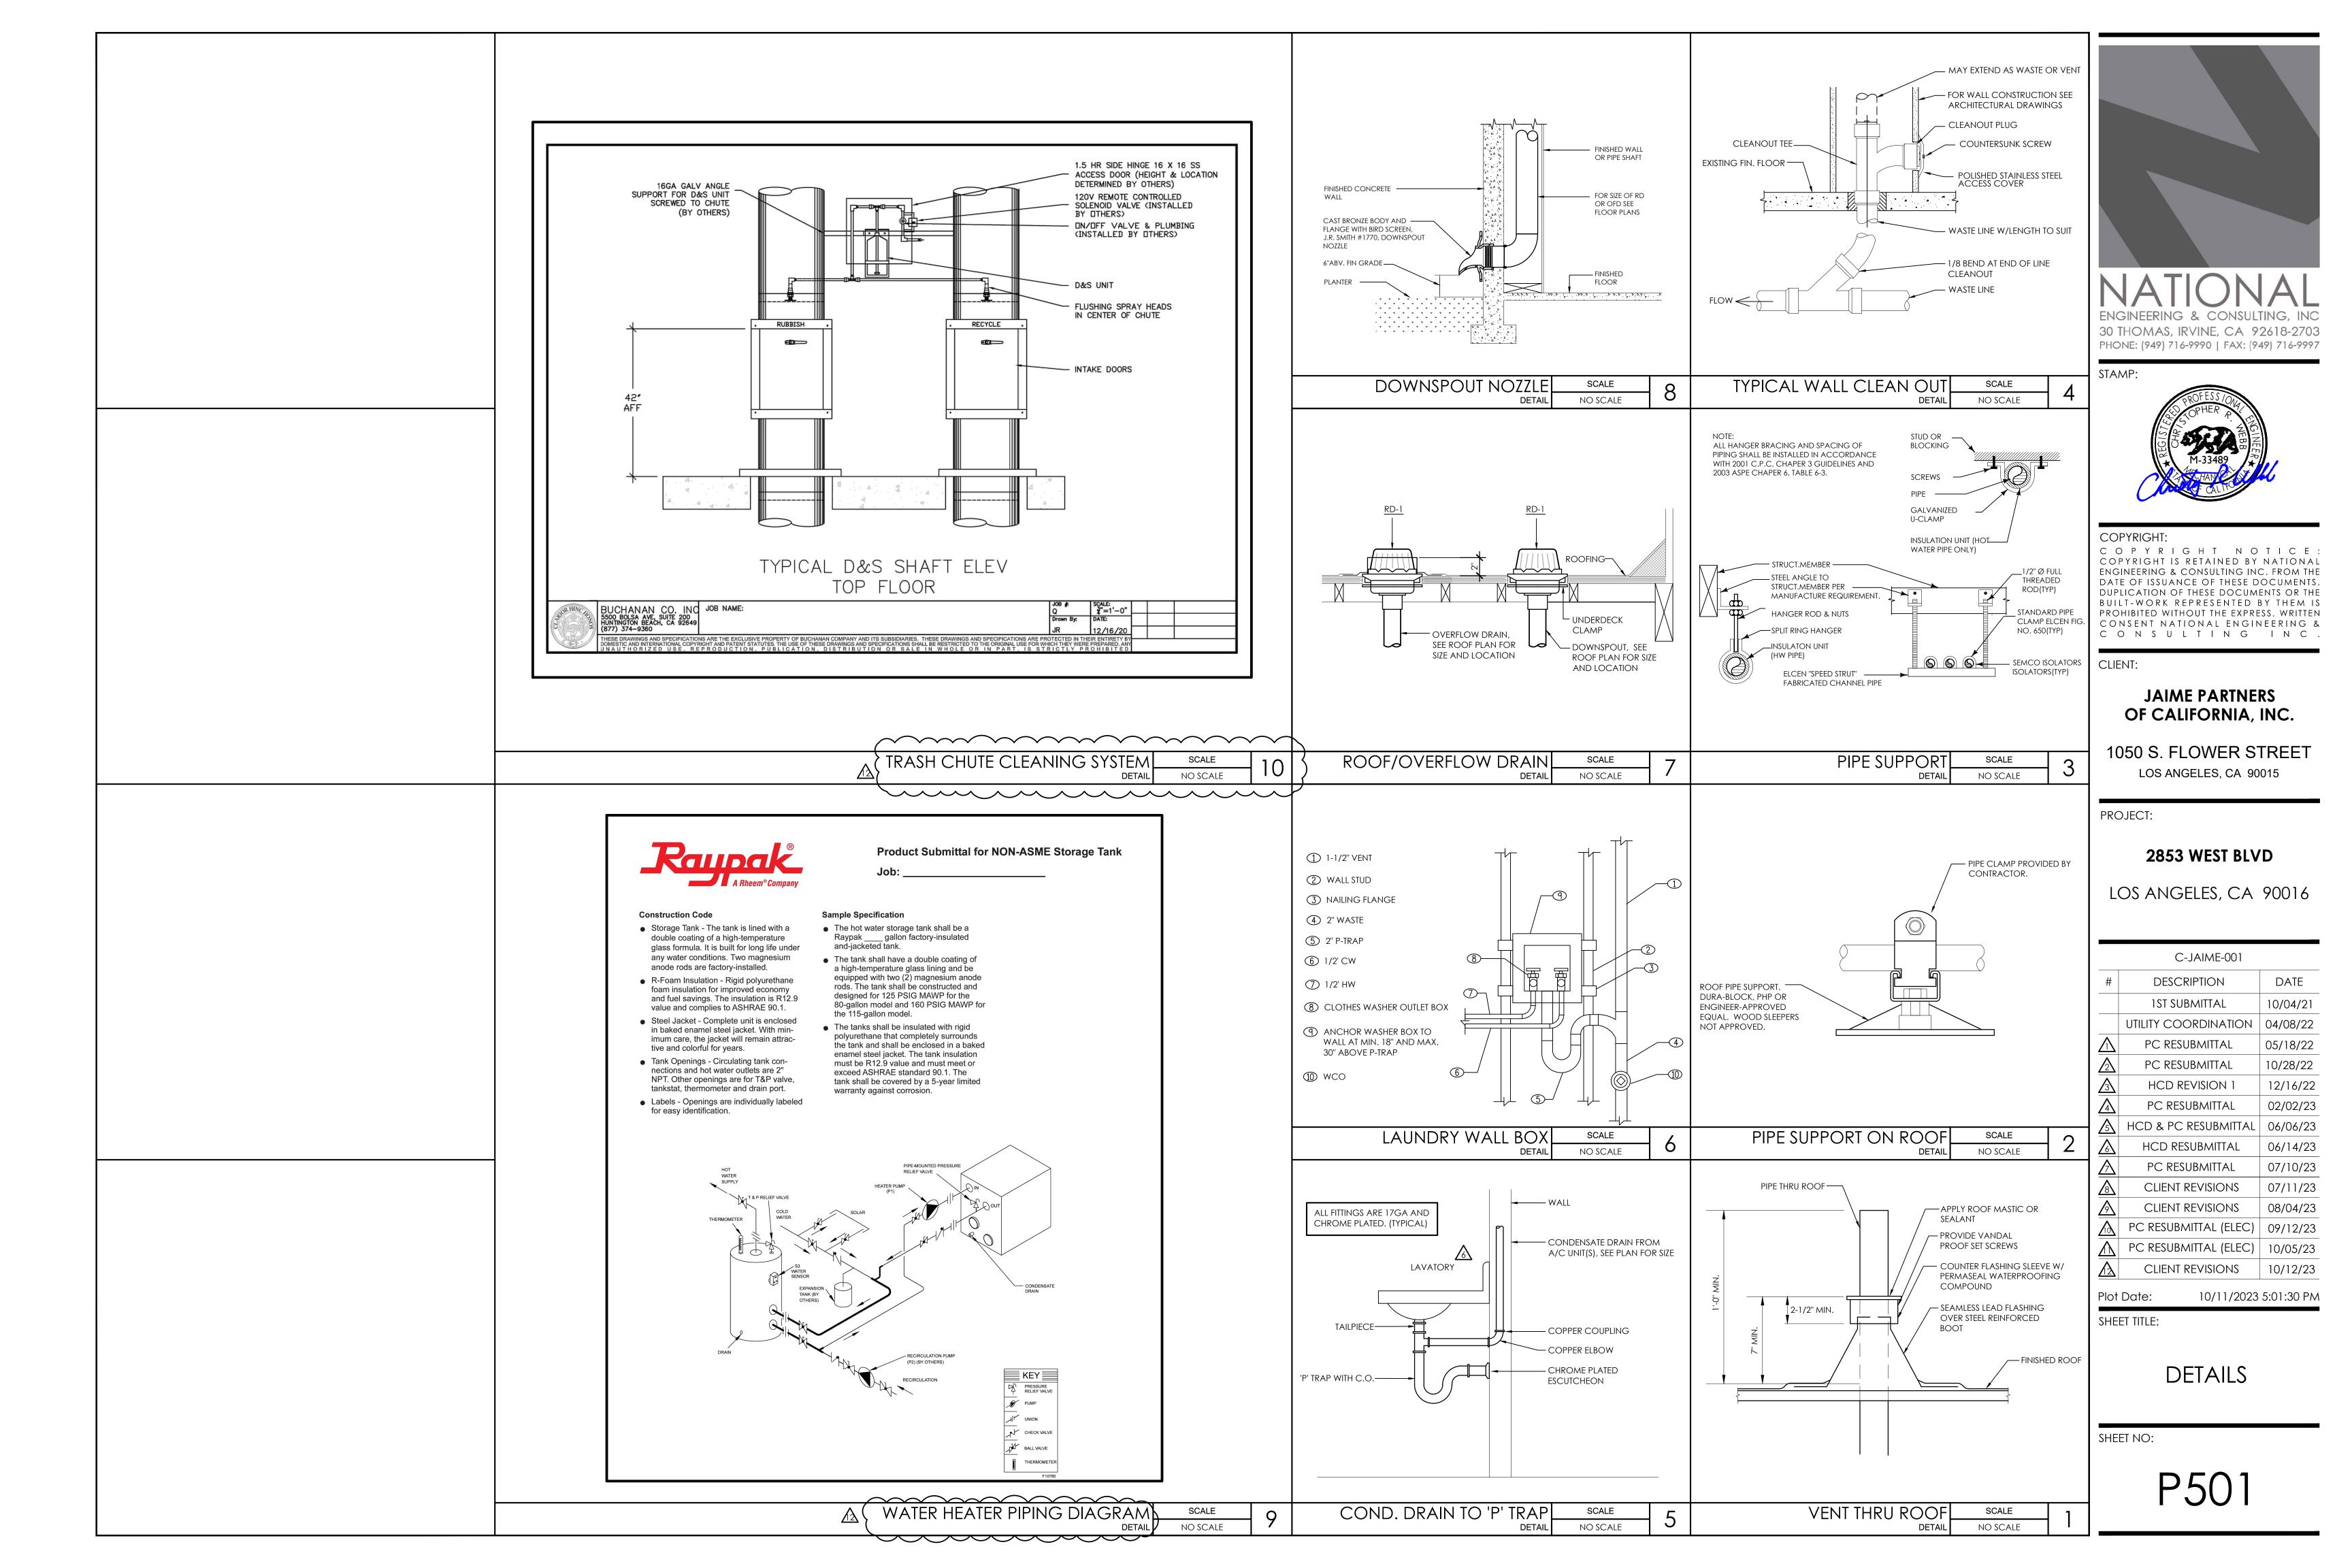
RISER DIAGRAMS

SHEET NO:

SCALE NTS

STORM DRAIN RISER DIAGRAM

_A P308



△ PIPE MATERIAL SCHEDULE													
	MATERIAL												
SERVICE	LOCATION	COPPER TYPE "K"	COPPER TYPE "L"	COPPER TYPE "M"	CROSS-LINKED POYETHYLENE (PEX A)	DAG	CPVC	BLACK STEEL SCH 40	CAST IRON SOIL PIPE & FITTINGS	SCHEDULE 40 ABS DWV	SCR II APPROVED POLYETHYLENE (PE) GAS PIPING	CORRUGATED STAINLESS STEEL TUBING (CSST)	REMARKS
WATER	INSIDE				•		•						4, 5, 9, 10, 11, 13
WAILK	BELOW GRADE						•						4, 5, 13, SCHEDULE 80 PVC
	INSIDE					•	•	•	•	•			4, 5, 9, 13, SCHEDULE 40 PVC
Sanitary Drainage	OUTSIDE ABOVE GRADE								•				3, 4, 5, 6
	BELOW GRADE					•	•		•	•			4, 5, 13, SCHEDULE 40 PVC
	INSIDE					•	•	•	•	•			4, 5, 9,13, SCHEDULE 40 PVC
Sanitary Vent	OUTSIDE ABOVE GRADE						•	•	•				
	BELOW GRADE					•	•		•	•			4, 5, 13, SCHEDULE 40 PVC
	INSIDE					•	•		•				3, 9, 13, SCHEDULE 40 PVC
STORM DRAINAGE	OUTSIDE ABOVE GRADE						•	•	•				
	BELOW GRADE					•	•		•	•			4, 5, 13, SCHEDULE 40 PVC
	INSIDE						•			•			4, 5, 9, 13, SCHEDULE 40 PVC
CONDENSATE DRAINAGE	OUTSIDE ABOVE GRADE						•						
	BELOW GRADE						•			•			4, 5, 13, SCHEDULE 40 PVC
	INSIDE	•											13
COMPRESSED AIR	OUTSIDE ABOVE GRADE	•											13
	BELOW GRADE	•											13
24.0	INSIDE, OUTSIDE ABOVE GRADE							•				•	7
GAS	OUTSIDE BELOW GRADE							•			•	•	7, 8

- 1. ASTM B88, HARD DRAWING COPPER TUBING, FITTINGS ANSI/ASME B16.22, WROUGHT COPPER.
- 2. ASTM B306 COPPER DRAINAGE TUBE (DWV), FITTINGS: ANSI/ASME B16.29 WROUGHT COPPER AND WROUGHT COPPER ALLOY SOLDER JOINT DRAINAGE FITTINGS (DWV).
- 3. NO-HUB, SERVICE WEIGHT CAST IRON SOIL PIPE AND FITTINGS ASTM A74 AND IAPMO LISTED COUPLING. MUST BEAR THE COLLECTIVE TRADE MARK OF THE CAST IRON SOIL PIPE INSTITUTE AND NSF TRADE MARK.
- 4. COORDINATE WITH LOCAL JURISDICTION.
- 5. OWNER/CONTRACTOR CAN SUBSTITUTE CALLED OUT PIPING MATERIAL ONLY IF WRITTEN APPROVAL IS OBTAINED FROM PLAN EXAMINER AND FIELD INSPECTOR PRIOR TO STARTING CONSTRUCTION. ONCE APPROVED, INSTALLATION MUST COMPLY WITH MANUFACTURER'S RECOMMENDATIONS.
- 6. ALL METAL PIPES BURIED WITHIN CORROSIVE SOIL MUST BE WRAPPED IN "ML" BLACK TAPE THAT IS IAPMO APPROVED AND UL LISTED. CONTRACTOR MUST VERIFY WITH SOIL ENGINEER FOR LEVEL OF CORROSIVENESS BEFORE BID AND COMMENCEMENT OF WORK.
- 7. PAINT 1 LAYER OF PRIMER AND 2 LAYERS SAFETY YELLOW RUSTOLEUM ON EXPOSED BLACK STEEL NATURAL GAS PIPING.
- 8. POLYETHYLENE PIPE: SCR II APPROVED GAS PIPE WITH METALLIC PIPE MARKER GASTITE OR ENGINEER-APPROVED EQUAL. IF BLACK STEEL PIPING IS USED, PIPING MUST BE ASTM A53 OR A120 WITH OUTSIDE PROTECTIVE PLASTIC COATING OF POLYETHYLENE, PVC OR EQUAL OF 10 MIL OR GREATER THICKNESS. FITTINGS SHALL BE ASTM A234 FORGED STEEL WELDING TYPE WITH AWWA C105 POLYETHYLENE JACKET OR DOUBLE-LAYER, HALF-LAPPED 10 MIL POLYETHYLENE TAPE. JOINTS SHALL BE WELDED AND FIELD-WRAPPED WITH AN APPROVED PROTECTIVE PLASTIC COATING EQUAL TO TAPECOAT CT10, OR 3M #50 TAPE.
- 9. PVC PIPING NOT PERMITTED IN RETURN PLENUM AREA ABOVE CEILING. CPVC, WHEN WRAPPED BY APPROPRIATE / APPROVED FIBERGLASS INSULATION, MAY BE USED IN PLENUM SPACE IN LIEU OF PVC. SUBMIT PIPING AND INSULATION SPECIFICATIONS TO ENGINEER OF RECORD FOR WRITTEN APPROVAL OF ALL CPVC PIPING TO BE INSTALLED IN RETURN AIR PLENUM SPACES.
- 10. PVC IS ACCEPTABLE FOR BUILDING SUPPLY PIPING AND FOR COLD WATER APPLICATIONS BUT NOT FOR HOT WATER APPLICATIONS. CPVC IS ACCEPTABLE FOR BOTH HOT AND COLD WATER APPLICATIONS.
- 11. CROSS-LINKED POLYETHYLENE (PEX A) TUBING MAY BE USED FOR DOMESTIC HOT AND COLD WATER, HOT WATER RECIRCULATION, HYDRONIC HEATING AND COOLING. APPROVED MANUFACTURERS INCLUDE UPONOR OR ENGINEER-APPROVED EQUAL. FOR ALL OTHER MANUFACTURERS, SUBMIT FULL MANUFACTURER'S SPECIFICATION SHEET, INSTALLATION INSTRUCTIONS AND COMPLETE LIST OF REQUIRED INSTALLATION HARDWARE TO ENGINEER FOR EVALUATION AND APPROVAL. PEX A TUBING OF TYPE PEX-AL-PEX, PEX TUBING USED FOR CONTINUOUSLY RECIRCULATING HOT WATER WHICH STAYS NOT CONTINUOUSLY AND PEX A TUBING BURIED IN SOIL SHALL ONLY BE ALLOWED AS NOTED IN TABLE 604.1 AS INDICATED IN THE NOTE IMMEDIATELY BELOW. PROVIDE BRASS OR POLY EXPANSION FITTINGS ONLY.
- 12. ALL MATERIALS USED FOR DOMESTIC WATER PIPING FOR THIS PROJECT SHALL COMPLY WITH TABLE 604.1 OF THE CURRENT EDITION OF THE CPC. ALL MATERIALS USED FOR DOMESTIC WASTE AND VENT PIPING FOR THIS PROJECT SHALL COMPLY WITH TABLE 701.2. DEVIATIONS FROM THESE REFERENCES SHALL NOT BE PERMITTED WITHOUT WRITTEN APPROVAL FROM BOTH THE AUTHORITY HAVING JURISDICTION AND THE ENGINEER OF RECORD.
- 13. ABS AND PVC INSTALLATIONS ARE LIMITED TO NOT MORE THAN TWO STORIES OF AREAS OF RESIDENTIAL ACCOMODATION.

DOMESTIC	WATER	PIPE S	SIZING	CHART

PIPE SIZE	PIPE MATERIAL	COLD	WATER	HOT WATER			
FIFE SIZE	FIFE MATERIAL	MAX GPM (FT)	MAX WSFU (FT)	MAX GPM	MAX WSFU		
1/2"	PEX	0	0	0	0		
3/4"	PEX	2	1	2	1		
1"	PEX	4	4	4	4		
1-1/4"	PEX	7	8	7	8		
1-1/2"	PEX	11	15	11	15		
3/4"	CPVC SCH. 80	2	1	2	1		
1"	CPVC SCH. 80	5	6	5	6		
1-1/4"	CPVC SCH. 80	11	15	11	15		
1-1/2"	CPVC SCH. 80	17	24	17	24		
2"	CPVC SCH. 80	35	66	35	66		
2-1/2"	CPVC SCH. 80	55	151	55	151		
3"	CPVC SCH. 80	100	380	100	380		
4"	CPVC SCH. 80	180	809	180	809		

PIPE SIZED BASED ON **1.3 PSI** ALLOWABLE FRICTION LOSS/100 FT OF PIPE AND MAX 8 FPS (CW), 5 FPS (HW).

'UPONOR AQUAPEX' PEX PIPE AND PLASTIC INSERT FITTINGS SIZED PER PIPE SIZING CHART APPROVED BY

LARR-5482. 'SPEARS' CPVC SCH. 80 PIPE AND FITTINGS SIZED PER MANUFACTURER, APPROVED BY LARR-5700.

PLUMBING FIXTURE SCHEDULE

		ROUGH IN SIZE				
MARK	FIXTURE	S/W	٧	CW	HW	- DESCRIPTION / REMARKS
<u>WC-1</u>	WATER CLOSET (TANK - ADA)	3"	2"	1-1/4"	-	AMERICAN STANDARD "CADET" CHAIR-HEIGHT (ADA) ELONGATED TOILET 215AA104.020 (OR ENGINEER-APPROVED EQUAL), (1.28 GPF), FLOOR-MOUNTED, ELONGATED BOWL, FULLY-GLAZED TRAPWAY, WHITE VITREOUS CHINA, OLSONITE PLASTIC SEAT MODEL 95CT COMFORTCURVE, ELONGATED, OPEN FRONT, STAIN & CHEMICAL RESISTANT.
LAV-1	LAVATORY (ADA)	2"	2"	1/2"	1/2"	KOHLER "HONESTY" K-99760-4 (OR ENGINEER-APPROVED EQUAL), SINGLE-HANDLE BATHROOM SINK FAUCET INCLUDE METAL POP-UP DRAIN W/ 1-1/4" TAILPIECE, MAX FLOW RATE OF 1.2 GPM.
<u>FD-1</u>	FLOOR DRAIN	2"	1-1/2"	-	-	ZURN MODEL Z415-BZ-P 7"Ø NICKEL BRONZE GRATE, CAST IRON BODY, CONVERTIBLE MEMBRANE CLAMP, AND ADJUSTABLE COLLAR (TRAP PRIMER CONNECTION IF SHOWN ON THE PLAN).
<u>FD-2</u>	FLOOR DRAIN	3"	2"	-	-	ZURN MODEL Z415-BZ-P 8"Ø NICKEL BRONZE GRATE, CAST IRON BODY, CONVERTIBLE MEMBRANE CLAMP, AND ADJUSTABLE COLLAR (TRAP PRIMER CONNECTION IF SHOWN ON THE PLAN).
<u>FS-1</u>	FLOOR SINK	3"	2"	-	-	ZURN MODEL 1900-25 SANI-FLOOR RECEPTOR, 12x12x6 ACID RESISTING PORCELAIN ENAMEL INTERIOR AND TOP, CAST IRON BODY, SQUARE SLOTTED LIGHT DUTY GRATE. COORDINATE 1/2 GRATE CONFIGURATION.
<u>S-1</u>	SINK	2"	2"	1/2"	1/2"	'KOHLER' MODEL "VAULT" #K-3894, UNDERMOUNT SINGLE-BOWL KITCHEN SINK. KOHLER FAUCET #K-22972 PULL-DOWN SINGLE-HANDLE KITCHEN FAUCET.
<u>MS-1</u>	MOP SINK	3"	2"	3/4"	3/4"	'ZURN' MODEL #Z1996-24, MOP SERVICE BASIN (24"x24"), PVC DRAIN BODY, STAINLESS STEEL STRAINER AND 3" GASKETED OUTLET CONNECTION. ZURN FAUCET MODEL #Z1996-SF SERVICE SINK FAUCET, COMPLETE WITH VACUUM BREAKER, INTEGRAL STOPS, ADJUSTABLE WALL BRACE, PAIL HOOK, FOUR-ARM HOT AND COLD HANDLES AND 3/4" HOSE THREAD ON SPOUT.
<u>SH-1</u>	SHOWER (ADA)	3"	2"	1/2"	1/2"	KOHLER "PURIST" MODEL: K-22178-G (OR ENGINEER-APPROVED EQUAL), MULTIFUNCTION HANDSHOWER KIT, ADA COMPLIANT. INCLUDES 1.75 GPM MULTIFUNCTION HANDSHOWER, 60" METAL HOSE, 30" SLIDEBAR AND CONTEMPORARY SLIDEBAR TRIM.
<u>SH-2</u>	SHOWER (W/ BATHTUB)	3"	2"	1/2"	1/2"	SHOWER: KOHLER "PURIST" MODEL: K-22178-G (OR ENGINEER-APPROVED EQUAL), MULTIFUNCTION HANDSHOWER KIT, ADA COMPLIANT. INCLUDES 1.75 GPM MULTIFUNCTION HANDSHOWER, 60" METAL HOSE, 30" SLIDEBAR AND CONTEMPORARY SLIDEBAR TRIM. BATHTUB: KINGSTON BRASS MODEL: VTAP603622R, 60" ACRYLIC ALCOVE TUB.
WB-1	LAUNDRY WALL BOX	2"	2"	3/4"	3/4"	OATEY "QUADTRO" (OR ENGINEER-APPROVED EQUAL), 1/4 TURN CPVC CONNECTION WASHING MACHINE SUPPLY BOX, WITH WATER HAMMER. CLOTHES WASHER/DRYER: GE MODEL: GUD27EESN/GUD28GESN (OR ENGINEER-APPROVED EQUAL) STAINLESS STEEL WASHER AND DRYER.
<u>KS-1</u>	KITCHEN SINK	2"	2"	1/2"	1/2"	ELKAY MODEL: ELUHAD311855PD STAINLESS STEEL ROUND UNDER-MOUNT DOUBLE SINK ADA COMPLIANT. BOTTOM GRID LKWRBG16SS. DRAIN LK-19. FAUCET: CHICAGO FAUCET MODEL 50-E35-317XKABCP, 1.5 GPM DECK-MOUNTED, SINGLE HOLE HOT AND COLD MIXING SINK FAUCET. 5-1/4" RIGID SWING GOOSENECK SPOUT, 4" VANDAL PROOF WRIST BLADE HANDLE, 3/8" COMPRESSION FLEXIBLE STAINLESS STEEL SUPPLY HOSES.
DW-1	DISHWASHER				1/2"	GE MODEL: PDT145SGL/SSL (OR ENGINEER-APPROVED EQUAL) ADA COMPLIANT 18" DISHWASHER.
<u>WHA</u>	WATER HAMMER ARRESTER	-	-	LINE SIZED	LINE SIZED	PPP, INC. SERIES SC, FULLY MECHANICAL WATER HAMMER ARRESTER SIZED PER MANUFACTURER SPECIFICATIONS.
<u>HB-1</u>	HOSE BIBB	-	-	LINE SIZED	-	HYDRANT - EXTERIOR FREEZELESS: WOODFORD MODEL #B65-C WALL HYDRANT WITH CHROME BOX DRAIN DIVERT AND KEY LOCK, INTEGRAL VACUUM BREAKER, 3/4" NPT CONNECTION, DO NOT INSTALL LOWER THAN 12" OR GREATER THAN 3'-0" ABOVE FINISH GRADE.
<u>HB-2</u>	HOSE BIBB	-	-	LINE SIZED	-	HYDRANT - EXTERIOR ROOFTOP FREEZELESS: WOODFORD MODEL #RHY2-MS ROOFTOP HYDRANT CAST IRON WITH 4-BOLTS MOUNTING DRAW TIGHT AT ROOF DECKING FLANGE, 50HF BACKFLOW PREVENTER, 3/4" NPT CONNECTION, INSTALL 32" ABOVE FINISH ROOF.
RD-X	ROOF DRAIN AND OVERFLOW DRAIN		-	-	-	ZURN MODEL Z165 8-3/8" DIAMETER ROOF DRAIN AND OVERFLOW DRAIN, DURA-COATED CAST IRON BODIES WITH COMBINATION MEMBRANE FLASHING CLAMP/GRAVEL GUARDS, DOUBLE TOP-SET DECK PLATE, AND LOW SILHOUETTE CAST IRON DOMES. TERMINATE MAIN DRAIN 12" ABV. GRADE & OVERFLOW DRAIN 18" ABOVE GRADE WITH ZURN #Z199 DOWNSPOUT.
<u>BP-1</u>	BACKFLOW PREVENTER	-	-	SEE PLAN	-	REDUCED PRESSURE PRINCIPLE ASSEMBLY BACKFLOW PREVENTER, ZURN #375AST, LEAD-FREE, FULL PORT NRS GATE VALVES: CONNECTION AS REQUIRED FOR DESIRED INSTALLATION. PROVIDE "Y" STRAINER UPSTREAM OF ASSEMBLY, INSPECTION BY CERTIFIED BACKFLOW REPRESENTATIVE/CITY AGENCIES, IAPMO/CSA/USC AND ASSE-1013 LISTED. SUITABLE FOR SIZES 2-1/2" TO 10". PROVIDE AIR-GAP FITTING WITH A MINIMUM GAP OF 2 X D WHERE D IS THE EFFECTIVE DIAMETER OF THE DISCHARGE DRAIN PIPE SERVING THE BACKFLOW PREVENTER. EXTEND DISCHARGE TO ADJACENT FLOOR SINK OR OTHER CODE-APPROVED RECEPTOR. UNIT TO BE INSTALLED HORIZONTALLY.
WCO FCO COTG CO	CLEAN-OUTS	-	-	-	-	WALL CLEAN OUT: "ZURN" MODEL Z1447 SQUARE, Z1446 ROUND. FLOOR CLEANOUT: "ZURN" MODEL Z1400-BZ MUST BE FLUSHED TO SURFACE. CLEAN OUT TO GRADE: "ZURN" MODEL Z1400 MUST BE FLUSHED TO SURFACE. T CLEAN OUT: "ZURN" MODEL Z1445.

PLUMBING FOLIPMENT SCHEDULE

				FLOMBING EQUIFMENT SCHEDULE
MARK	DESCRIPTION			DESCRIPTION/REMARKS
<u>WH-1</u>	CIRCULATING WATER HEATER	RTR-FS633DVLN	120V/1/60	RHEEM COMMERCIAL TANKLESS SYSTEM - FREE STANDING. PROVIDE WITH FACTORY DIRECT VENT HEADER KITS. 24 TOTAL AMPS. MAX GAS INPUT OF 1,199 MBH TO HEAT 1,932 GPH AT A TEMPERATURE RISE OF 70°F. CONTRACTOR TO PROVIDE SEPARATE PUMP FOR CONNECTION TO HOT WATER STORAGE TANK (I-1). REFER TO MANUFACTURER'S GUIDELINES FOR PROPER INSTALLATION.
<u>CP-1</u>	CIRCULATION PUMP	GRUNDOS UP15-10B5	115V/1/60	INLINE HOT WATER OPEN SYSTEM RECIRCULATING PUMP, 4.5 GPM (140°F) @ 6' HEAD, 1/25 HP, 115V/1PH, INTEGRAL ATTACHED TIMER FOR OPERATION CONTROLS AND ATTACHED POWER CORD. PUMP REQUIRES STANDARD MIN. 10A GFCI OUTLET TO PROVIDE POWER TO 25W MOTOR.
<u>ET-1</u>	THERMAL EXPANSION TANK	AMTROL ST-80V-C		THERM-X-TROL EXPANSION TANK W/ TANK VOLUME OF 53 GALLONS AND MAX. WORKING PRESSURE OF 150 PSIG.
PRV-1	PRESSURE REDUCING VALVE	ZURN WILKINS 500XL		PRESSURE REDUCING VALVE W/ INTEGRAL BY-PASS CHECK VALVE, ALL BRONZE BODY AND BELL RESIST CORROSION, LOW-LEAD LAW COMPLIAN (OR ENGINEER-APPROVED EQUAL).
<u>SM-1</u>	1" WATER SUB-METER	EKM METERING SPWM-100-NSF	3	1-1/4" COLD WATER FLOW METER WITH PULSE-OUTPUT COMMUNICATION FOR REMOTE READING. NO POWER SOURCE REQUIRED. CONNECT TO FACTORY EKM "OMNIMETER PULSE V.4" REMOTE READER AND EKM "PUSH 3" CLOUD-BASED CONTROL / MONITOR SYSTEM.
<u>SM-2</u>	1-1/2" WATER SUB-METER	EKM METERING SPWM-150-NSF		1-1/2" WATER FLOW METER WITH PULSE-OUTPUT COMMUNICATION FOR REMOTE READING. NO POWER SOURCE REQUIRED. CONNECT TO FACTORY EKM "OMNIMETER PULSE V.4" REMOTE READER AND EKM "PUSH 3" CLOUD-BASED CONTROL / MONITOR SYSTEM.

HOT WATER STORAGE TANK SCHEDULE MARK MFG./MODEL CAPACITY (GALLONS) TYPE/SIZE WEIGHT (LBS.) WEIGHT (LBS.) PRAYPAK 115 GALLON 115 29"Ø x 60" VERTICAL NOTES:

1.	HEAVY-DUTY, ABOVE GRADE, COMMERCIAL STORAGE TANK
2.	2" NPT THREADED INLET AND OUTLET FITTING FOR HOT WATER SUPPLY FROM WH-1
3.	150 PSI ASME WORKING PRESSURE.

DOMESTIC WATER CALCULA	IION		
NATER INFO			
MAXIMUM WATER PRESSURE:		122	PSI
MINIMUM WATER PRESSURE:		109	PSI
5 SETPOINT OF BACKFLOW PREVENTER:		75	PSI
EXPECTED DEMAND:		110	GPM
NATER LOSSES			5
loss through: 4" site water meter		0.0	PSI
LOSS THROUGH: 4" SITE BACKFLOW PF	REVENTER	0.0	PSI
FALL-OFF PRESSURE LOSS THROUGH: 3" PRV (SET AT 75 PSI)	1	5.0	PSI Z
STATIC HEAD LOSS: 60.0 FT / (2.31 FT/PSI)	=	26.0	PSI
DYNAMIC HEAD LOSS (WATER HEATER); 323.0 FT / (2.31 FT/PSI)	=	10.0	PSI
WATER SUB-METER (WORST CASE): 1" 27.5 FU TOTAL	=	4.4	PSI
residual pressure: 25 psi at fixture	=	25.0	PSI
	TOTAL	70.3	PSI
PPE LENGTH		7	
TAP TO METER	<u> </u>	0	FT
meter to last fixture	=	210	FT
VERTICAL RISE	=	70	FT
VALVES AND FITTING (25% OF TOTAL LENGTH)	=	70	FT
	TOTAL	350	FT

NOTE: SYSTEM SIZED W/ PRV SELECTION ENSURING MAX FALL OFF PRESSURE @ 5 PSI PER THE DESIGNATED FLOW. ANY PROPOSED SUBSTITUTE MUST ALSO MEET THIS REQUIREMENT.

75 PSI - 70.3 PSI = 4.7 PSI

PRESSURE AVAILABLE =


ALLOWABLE PSI DROP/100 FT =

EIVTURE UNIT CALCULATION

DESCRIPTION	QTY		WASTE	,	WATER			
DESCRIPTION	QIT	DFU	SUBTOTAL	WSFU	SUBTOTAL			
WATER CLOSET (FT)	48	3	144	2.5	120			
STANDING SHOWER	38	2	76	2	⁷⁶ ∧			
SHOWER W/BATHTUB	9	2	18	4	36/9			
LAVATORY	48	1	48	1	48			
MOPSINK	1	3	3	3	3			
KITCHEN SINK W/ DISHWASHER	22	2	44	1.5	33			
SINK	1	2	2	1.5	1.5			
CLOTHES WASHER	23	3	69	4	⁹² ^			
HOSE BIBB - FIRST	1			2.5	2. 5/9			
hose bibb - additional	4			1	4			
FLOOR DRAIN (3")	2	2	4					
floor sink (4")	1	6	6					
		TOTAL	414.0 DFU	TOTAL	416.0 WSP			
TC	TOTAL ESTIMATED DEMAND LOAD 110 GPM							

ES: RAINAGE FIXTURE UNITS (DFU) P

DRAINAGE FIXTURE UNITS (DFU) PER CPC TABLE 702.1, "PRIVATE."
WATER SUPPLY FIXTURE UNITS (WSFU) PER CPC TABLE A2.1
TOTAL ESTIMATED DEMAND LOAD PER CPC CHART A2.1, A2.1(1).

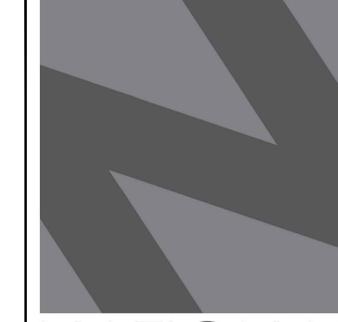

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CLIENT:

JAIME PARTNERS OF CALIFORNIA, INC.

1050 S. FLOWER STREET LOS ANGELES, CA 90015

PROJECT:

2853 WEST BLVD

LOS ANGELES, CA 90016

		C-JAIME-001	
	#	DESCRIPTION	DATE
λ		1ST SUBMITTAL	10/04/21
		UTILITY COORDINATION	04/08/22
	$\overline{\Lambda}$	PC RESUBMITTAL	05/18/22
	<u>2</u>	PC RESUBMITTAL	10/28/22
	3	HCD REVISION 1	12/16/22
	4	PC RESUBMITTAL	02/02/23
	<u></u>	HCD & PC RESUBMITTAL	06/06/23
	$\overline{\Diamond}$	HCD RESUBMITTAL	06/14/23
	$\overline{\triangle}$	PC RESUBMITTAL	07/10/23
	8	CLIENT REVISIONS	07/11/23
		CLIENT REVISIONS	08/04/23
	10	PC RESUBMITTAL (ELEC)	09/12/23
	$\overline{\Lambda}$	PC RESUBMITTAL (ELEC)	10/05/23
	12	CLIENT REVISIONS	10/12/23

Plot Date: 10/11/2023 4:59:20 PM

SHEET TITLE:

CALCULATIONS & SCHEDULES

SHEET NO: