A. GRADING NOTES:

- ALL WORK SHALL BE DONE IN ACCORDANCE WITH THESE APPROVED PLANS AND APPROVED REVISIONS. ANY CHANGES OR REVISIONS THEREFROM SHALL BE APPROVED BY THE CITY ENGINEER AND MITIGATION MONITOR PRIOR TO ANY REQUEST FOR INSPECTION.
- ALL GRADING SHALL BE INSPECTED AND TESTED BY OR UNDER THE DIRECTION OF A QUALIFIED SOILS ENGINEER. THE SOILS ENGINEER SHALL INSPECT THE EXCAVATION, AND SHALL OBSERVE AND TEST THE PLACEMENT, AND COMPACTION OF FILL AND BACKFILL AND COMPACTION OF TRENCHES; SUBMIT GEOTECHNICAL OR SOILS REPORTS AS REQUIRED AND DETERMINE THE SUITABILITY OF ANY FILL MATERIAL UPON COMPLETION OF GRADING OPERATIONS. THE SOILS ENGINEER SHALL STATE THAT OBSERVATIONS AND TESTS WERE MADE BY, OR UNDER DIRECTION OF THE SOILS ENGINEER. AND THAT EMBANKMENTS AND EXCAVATIONS WERE CONSTRUCTED IN ACCORDANCE WITH THE GEOTECHNICAL ASPECTS OF THE APPROVED GRADING PLANS, ANY APPROVED REVISIONS THERETO, SUBJECT LAND DEVELOPMENT PERMIT AND ORDINANCE NO. 1797 AS AMENDED, AND THAT ALL EMBANKMENTS AND EXCAVATIONS ARE ACCEPTABLE FOR THEIR INTENDED USE.
- THE CONTRACTOR SHALL PROPERLY GRADE ALL EXCAVATED SURFACES TO PROVIDE POSITIVE DRAINAGE AND PREVENT PONDING OF WATER. CONTRACTOR SHALL CONTROL SURFACE WATER TO AVOID DAMAGE TO ADJOINING PROPERTIES OR TO FINISHED WORK ON THE SITE, AND SHALL TAKE REMEDIAL MEASURES TO PREVENT EROSION OF FRESHLY GRADED AREAS UNTIL SUCH TIME AS PERMANENT DRAINAGE AND EROSION CONTROL MEASURES HAVE BEEN INSTALLED TO THE SATISFACTION OF THE CITY ENGINEER AND THE MITIGATION MONITOR.
- ALL AREAS TO BE FILLED SHALL BE PREPARED PRIOR TO FILLING, AND FILL SHALL BE PLACED IN ACCORDANCE WITH STANDARD SPECIFICATIONS AND THE RECOMMENDATIONS AND SPECIFICATIONS CONTAINED IN THE SOILS REPORT. ALL VEGETABLE MATTER AND OTHER OBJECTIONABLE MATERIALS SHALL BE REMOVED, BY THE CONTRACTOR, FROM THE SURFACE UPON WHICH THE FILL IS TO BE PLACED. LOOSE FILL AND UNSUITABLE SOILS SHALL BE REMOVED TO SUITABLE FIRM NATURAL GROUND. THE EXPOSED SOILS SHALL BE SCARIFIED IN ACCORDANCE WITH THE GEOTECHNICAL REPORT AND THEN COMPACTED TO A MINIMUM OF 90% OF ASTM-D1557. IT SHALL BE THE CONTRACTOR'S RESPONSIBILITY TO PLACE, SPREAD, WATER AND COMPACT THE FILL IN STRICT ACCORDANCE WITH THE SPECIFICATIONS.
- CUT AND FILL SLOPES SHALL BE CUT AND TRIMMED TO THE FINISHED GRADE TO PRODUCE SMOOTH SURFACES AND UNIFORM CROSS SECTIONS. THE SLOPES OF EXCAVATIONS AND EMBANKMENTS SHALL BE SHAPED, TRIMMED, AND PLANTED IN ACCORDANCE WITH THE PLANTING NOTES AND AS DIRECTED BY THE ENGINEER OF WORK, AND LEFT IN A NEAT AND ORDERLY CONDITION. ALL STONES, ROOTS AND OTHER WASTE MATERIALS EXPOSED ON THE EXCAVATION OR EMBANKMENT SLOPES WHICH ARE LIABLE TO BECOME LOOSENED, SHALL BE REMOVED AND DISPOSED OF. THE TOE AND TOP OF ALL SLOPES SHALL BE ROUNDED IN ACCORDANCE WITH ORDINANCE NO. 1797, THESE GRADING PLANS, AND THE STANDARD DRAWINGS GRD-01 AND GRD-02. SLOPE SETBACKS AND GRADES SHALL CONFORM TO GRD-06.
- IF THERE ARE EROSION SCARS ON EXISTING SLOPES WHICH OTHERWISE WOULD NOT BE ELIMINATED BY THE PROPOSED GRADING, THESE SCARS ARE TO BE ELIMINATED BY TRIMMING. FINE GRADING AND PLANTING. IF THE SCARS ARE IN AREAS OF NATIVE VEGETATION, THE REPAIRS SHOULD BE PERFORMED WITH AN EFFORT TO AVOID OR MINIMIZE IMPACTS TO NATIVE VEGETATION. ALL SUCH REPAIRS IN AREAS OF NATIVE VEGETATION SHALL BE REVIEWED AND APPROVED BY THE CITY'S MITIGATION MONITORING COORDINATOR PRIOR TO THE BEGINNING OF THE REPAIR WORK.
- ALL TREES, BRUSH, GRASS, AND OTHER OBJECTIONABLE MATERIAL SHALL BE COLLECTED, PILED OR OTHERWISE DISPOSED OF OFF THE SITE BY THE CONTRACTOR SO AS TO LEAVE THE AREAS THAT HAVE BEEN CLEARED WITH A NEAT AND FINISHED APPEARANCE FREE FROM UNSIGHTLY DEBRIS. APPROVAL OF LOCATIONS FOR DEBRIS FILL SHALL BE OBTAINED FROM THE SOILS ENGINEER PRIOR TO THE DISPOSAL OF ANY SUCH MATERIAL.
- SUBDRAIN LOCATIONS SHOWN ARE APPROXIMATE AND ARE RECOMMENDED FOR ALL SIGNIFICANT FILL CANYONS. THE ACTUAL LOCATION AND EXTENT OF SUBDRAINS SHALL BE DETERMINED BY THE GEOTECHNICAL CONSULTANT AT THE TIME OF CONSTRUCTION.
- . THE SOILS REPORT TITLED: __ (SOILS REPORT TITLE & DATE) (FIRM NAME) SHALL BE CONSIDERED TO BE FROM: PART OF THIS GRADING PLAN. ALL GRADING SHALL BE DONE IN ACCORDANCE WITH THE RECOMMENDATIONS AND SPECIFICATIONS CONTAINED IN SAID REPORT.
- 10. CONTRACTOR SHALL VERIFY LOCATIONS OF ALL EXISTING UNDERGROUND UTILITIES. LOCATIONS SHOWN ON THESE PLANS ARE APPROXIMATE AND SHOWN FOR GENERAL INFORMATION ONLY.
- 11. WHERE GRADING DOES NOT OCCUR. ALL EXISTING PLANT MATERIAL IS TO BE PROTECTED IN PLACE. NO CONSTRUCTION EQUIPMENT WILL BE ALLOWED TO TRAVEL THROUGH AND DAMAGE ANY OF THESE AREAS. ALL AREAS TO BE RETAINED IN A NATURAL CONDITION SHALL BE FENCED UNDER THE DIRECTION OF THE PROJECT BIOLOGIST. CONTRACTOR WILL BE RESPONSIBLE TO REPAIR ANY AND ALL DAMAGE/IMPACTS TO THESE AREAS.
- 12. THE CONTRACTOR SHALL FURNISH TO THE ENGINEER OF WORK AS-BUILT PLANS FOR ALL NEW IMPROVEMENTS AND GRADING SHOWN ON THESE PLANS FOR SUBMITTAL TO THE CITY ENGINEER FOR APPROVAL IN ACCORDANCE WITH SECTION 15.04.140 OF THE CHULA VISTA MUNICIPAL CODE.
- 13. IN THE CASE OF CONFLICTS. THE REQUIREMENTS OF THE EARTHWORK, SPECIFICATIONS PREPARED FOR THE PROJECT BY THE SOILS ENGINEER SHALL GOVERN THE REQUIREMENTS OF THIS PLAN AND THESE NOTES AND THESE PLANS SHALL BE REVISED ACCORDINGLY.

B. DIG ALERT NOTICE

IMPORTANT NOTICE

SECTION 4215/4217 OF THE GOVERNMENT CODE REQUIRES THAT A DIG ALERT IDENTIFICATION NUMBER BE ISSUED BEFORE A "PERMIT TO EXCAVATE" WILL BE VALID. PER YOUR DIG ALERT I.D. NUMBER CALL UNDERGROUND SERVICE ALERT TOLL FREE 1-800-422-4133 TWO WORKING DAYS BEFORE YOU DIG.

C. FIRE NOTE

ALL FIRE HYDRANTS AND HARD SURFACES ACCESS MUST BE IN PLACE BEFORE COMBUSTIBLE MATERIALS ARE DELIVERED TO THE SITE.

D. GENERAL NOTES:

- CONJUNCTION WITH IMPROVEMENT PLANS.
- BENCHMARKS DESTROYED BY CONSTRUCTION.
- VERTICAL BENCHMARKS DESTROYED BY THE CONSTRUCTION.
- SAFETY AND HEALTH STANDARDS, LAWS, AND REGULATIONS.
- 7. ALL FLOWS SHOWN ARE FOR 50 -YEAR STORM, EXCEPT AS NOTED.
- NOTED AND HAVE NOT BEEN REVIEWED FOR ADEQUACY BY THE CITY ENGINEERING DEPARTMENT.
- REQUIRED PRIOR TO ISSUANCE OF A GRADING PERMIT BY THE CITY OF CHULA VISTA.
- INSPECTOR AND THE MITIGATION MONITOR.


E. PRECONSTRUCTION CONFERENCE:

THE CONTRACTOR SHALL NOT BEGIN ANY WORK ON THIS PROJECT UNTIL A PRECONSTRUCTION CONFERENCE IS HELD WITH THE ENGINEER OF WORK, THE SOILS ENGINEER, DEVELOPER, CONTRACTOR, OTAY WATER DISTRICT INSPECTOR, AND CITY ENGINEER.

F. SHEET INDEX:

SHEET 1 :	TITLE SHEET / NOTES
SHEET 2-3 :	KEY MAP, NOTES, DETAILS & TYPIC
SHEET 4 :	ROUGH GRADING PLANS
SHEET 5:	EROSION CONTROL TITLE SHEET
SHEET 6 :	EROSION CONTROL PLANS

G. VICINITY MAP:

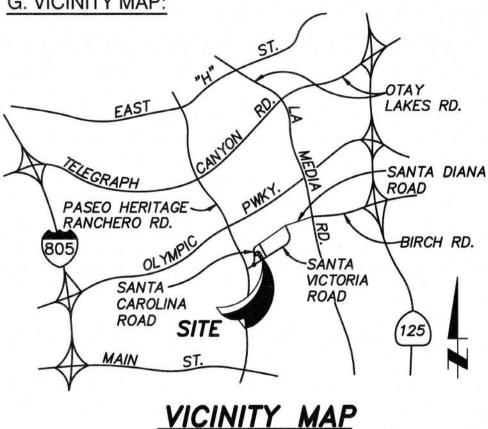

NOT TO SCALE THOMAS GUIDE, 57TH EDITION PG. 1331, GRID C-2

"ENGINEER AS-BUILT I HEREBY CERTIFY THAT TO THE BEST OF MY IMPROVEMENTS SHOWN ON THIS SET OF PLAN SHEETS) HAVE BEEN INSTALLED AN CONFORMANCE WITH THE SAID PLANS, ALL AF ANY DISCRETIONARY APPROVAL(S) FOR THE F	KNOWLEDGE AND BELIEF, THE IS (SHEET THROUGH ID CONSTRUCTED IN SUBSTANTIAL PPROPRIATE STANDARDS AND	DIGALER	Ţ			
SIGNED:	DATE:					
PRINTED NAME:	P.E. No	Q11				
DISCIPLINE: MY REGISTR	ATION EXPIRES:	811		1. ¹¹	$\mathbb{P}_{n \to \infty}$	
REFERENCE DRAWINGS	REVISIONS		Ву	Date	App'd	REVISIONS

ROUGH GRADING PLANS FOR: MU-1 RESIDENTIAL CITY OF CHULA VISTA, CALIFORNIA

1. STORM DRAINS ARE SHOWN FOR INFORMATIONAL PURPOSES ONLY. APPROVAL OF THIS PLAN DOES NOT CONSTITUTE APPROVAL OF SIZES, LOCATIONS, AND TYPE OF SEWER AND DRAINAGE FACILITIES, OR ANY SURFACE IMPROVEMENTS WITHIN FUTURE STREET RIGHTS-OF-WAY SHOWN ON THESE PLANS. SEPARATE APPROVALS AND PERMITS FOR THESE SHALL BE REQUIRED IN

2. WRITTEN PERMISSION SHALL BE OBTAINED FOR ANY OFF-SITE GRADING

3. CONTRACTOR SHALL TAKE ALL NECESSARY PRECAUTIONS REQUIRED TO PROTECT ADJACENT PROPERTIES DURING GRADING OPERATIONS. ANYTHING DAMAGED OR DESTROYED SHALL BE REPLACED OR REPAIRED TO CONDITION EXISTING PRIOR TO GRADING.

4. THE DEVELOPER/CONTRACTOR SHALL BE RESPONSIBLE FOR SURVEY MONUMENTS AND/OR VERTICAL CONTROL BENCHMARKS WHICH ARE DESTROYED BY CONSTRUCTION. A LAND SURVEYOR MUST FIELD LOCATE AND TIE-OUT ALL SURVEY MONUMENTS WITHIN THE WORK AREA PRIOR TO CONSTRUCTION; AND IF DESTROYED, A LAND SURVEYOR, OR A CIVIL ENGINEER AUTHORIZED TO PRACTICE LAND SURVEYING SHALL REPLACE SUCH MONUMENTS WITH THE APPROPRIATE MONUMENTS, AND A CORNER RECORD OR RECORD OF SURVEY, AS APPROPRIATE, SHALL BE FILED AS REQUIRED BY THE PROFESSIONAL LAND SURVEYOR'S ACT. THE DEVELOPER/CONTRACTOR WILL BE RESPONSIBLE FOR THE COST OF REPLACING ANY VERTICAL

5. THE DEVELOPER/CONTRACTOR WILL BE RESPONSIBLE FOR THE COST OF REPLACING ANY

6. THE CONTRACTOR SHALL DESIGN, CONSTRUCT, AND MAINTAIN ALL SAFETY DEVICES, INCLUDING SHORING, AND SHALL BE RESPONSIBLE FOR CONFORMING TO ALL LOCAL, STATE, AND FEDERAL


8. ALL SEDIMENTATION BASINS, OUTLET PIPES AND DITCHES ARE PRIVATE UNLESS OTHERWISE

9. THE OWNER MUST OBTAIN AN EXCAVATION PERMIT FROM THE DIVISION OF OCCUPATIONAL SAFETY AND HEALTH (D.O.S.H.) FOR CONSTRUCTION OF TRENCHES OR EXCAVATIONS WHICH ARE FIVE FEET OR DEEPER INTO WHICH A PERSON IS REQUIRED TO DESCEND. SAID PERMIT IS

10. GRADING EQUIPMENT SHALL NOT USE OR BLOCK TRAFFIC LANES DURING GRADING ACTIVITY, TRUCK OPERATIONS IN AND OUT OF CONSTRUCTION AND STAGING AREAS SHALL BE CONTROLLED AS REQUIRED BY THE CITY. TRUCK AND EQUIPMENT ROUTES IN AND OUT OF THE SITE, SHALL BE APPROVED BY THE CITY PRIOR TO START OF WORK. AT THE END OF THE WORKING DAY, STREETS SHALL BE CLEANED OF DIRT AND CONSTRUCTION DEBRIS TO THE SATISFACTION OF THE CITY

11. DUST GENERATED BY CONSTRUCTION ACTIVITIES SHALL COMPLY WITH LOCAL DUST CONTROL, ANY REQUIREMENTS OF ANY MITIGATION MONITORING PROGRAMS, AND UNIFORM BUILDING CODE (UBC) REQUIREMENTS, WHICH INCLUDE DUST CONTROL MEASURES FOR CONSTRUCTION SITES. DUST REDUCING MEASURES SHALL INCLUDE, BUT NOT LIMITED TO, REGULAR WATERING OF GRADED SURFACES AND RESTRICTION OF ALL CONSTRUCTION VEHICLES AND EQUIPMENT TO TRAVEL ALONG ESTABLISHED AND REGULARLY WATERED ROADWAYS AT SPECIFIED SPEEDS.

ICAL SECTIONS

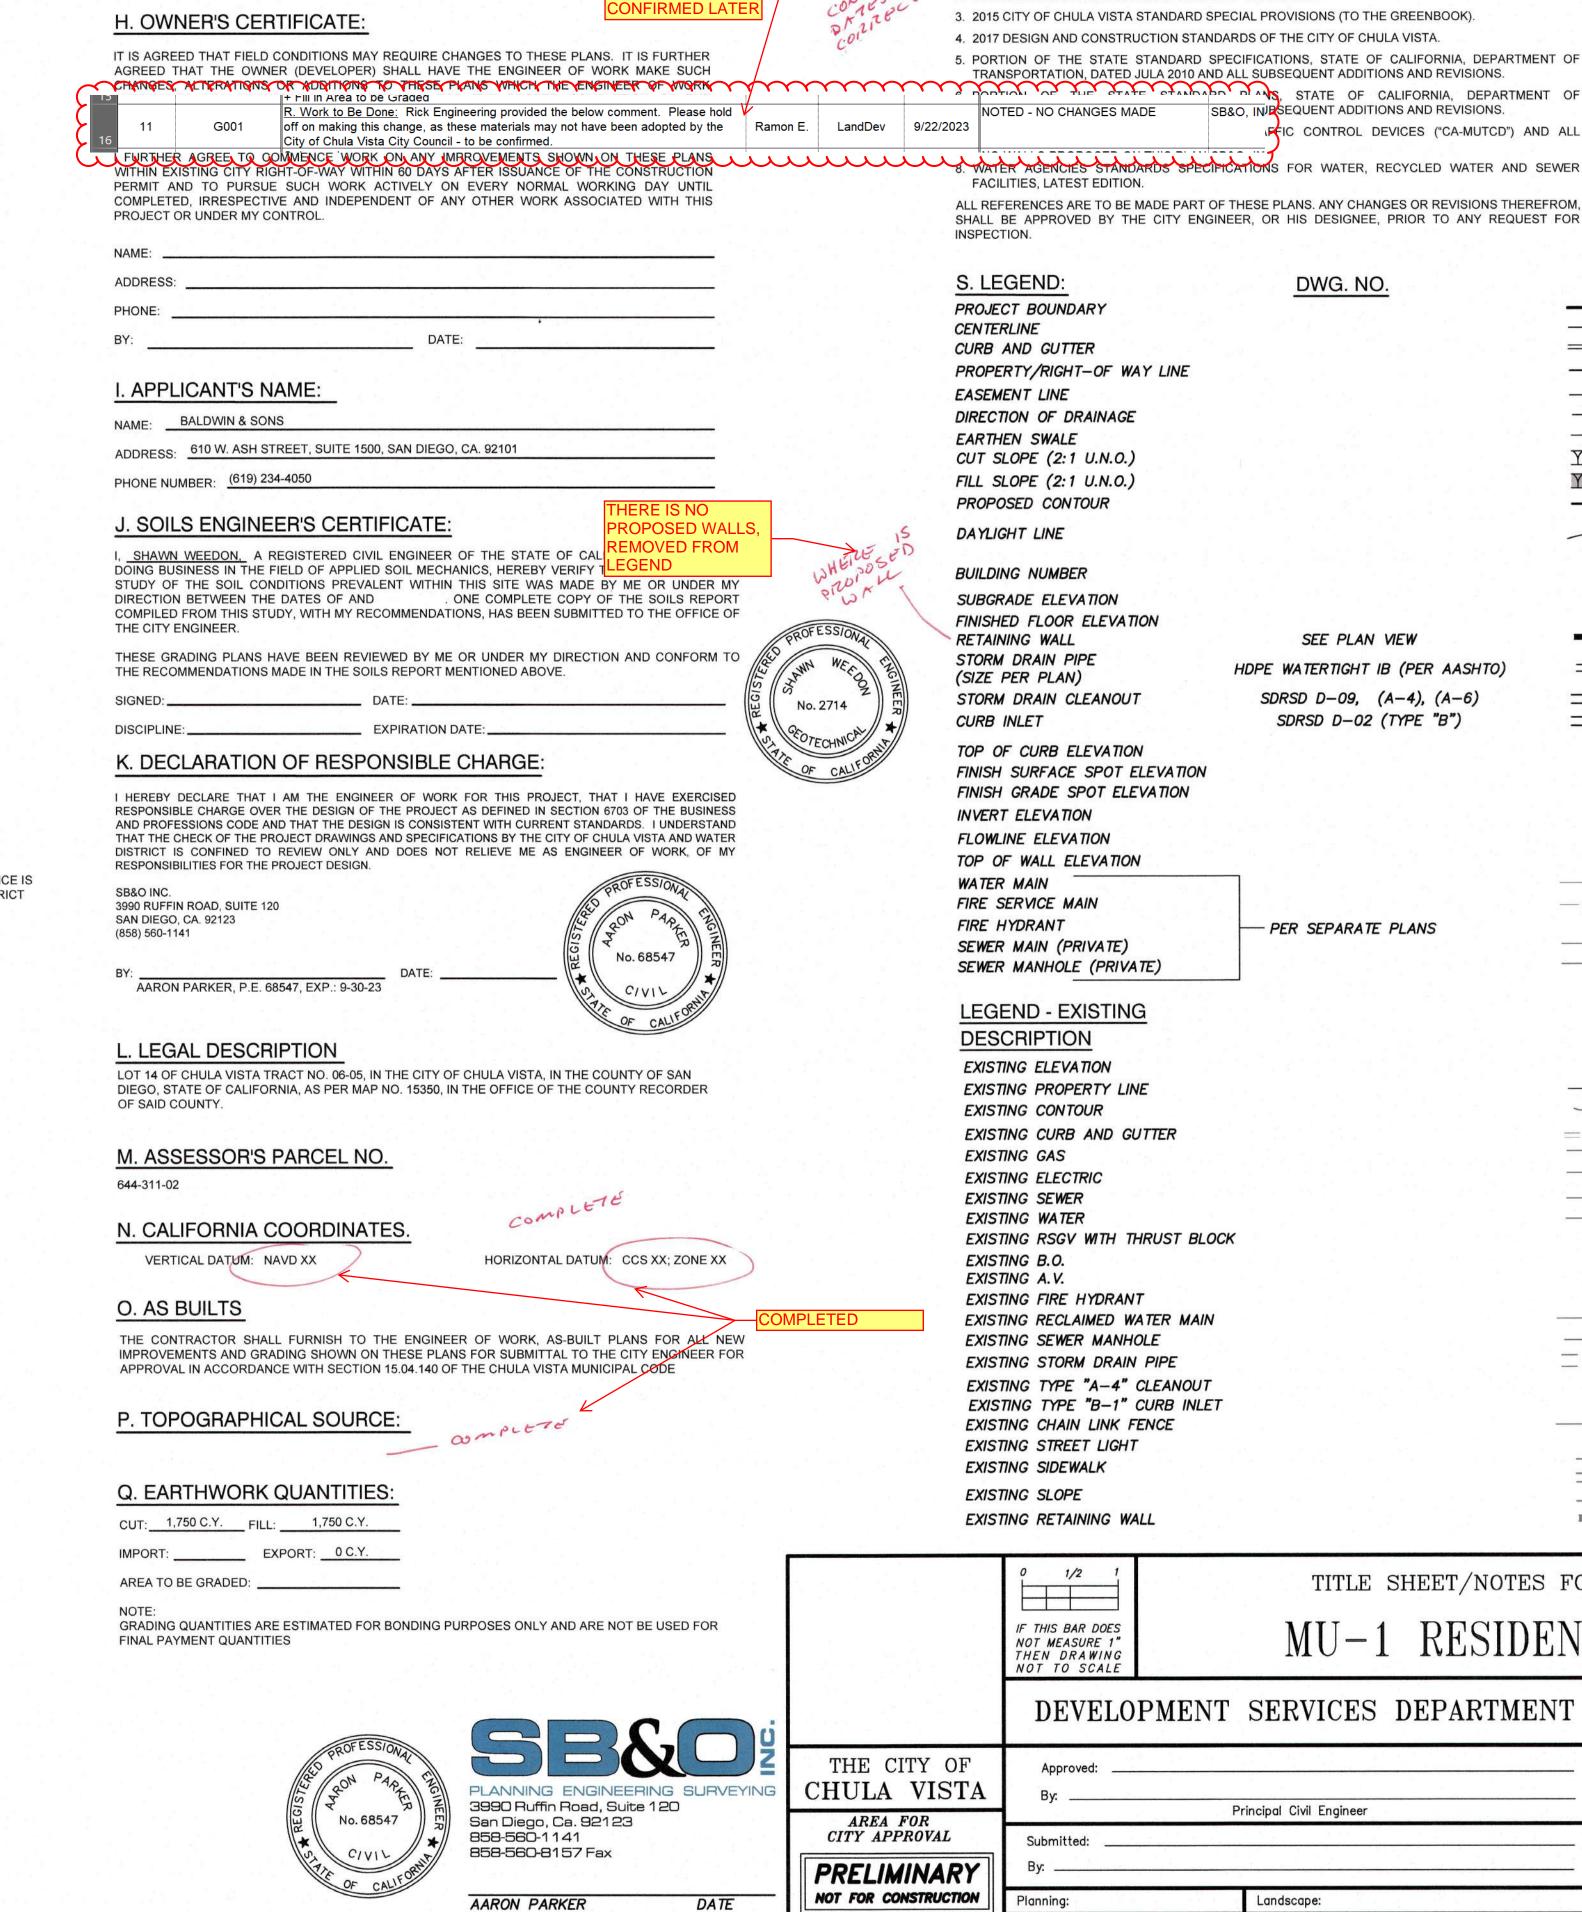

							AARUI	N PARKER	DATE
Ву	Date	App'd	REVISIONS	Ву	Date	App'd	Designed By:	Drawn By:	Checked By:
 							P.R.S., A.P., C.F.	SB&O	P.R.S., A.P., C.F.
 					6 N.		Plans Prepared Under	Supervision Of:	Date:
 							AARON PARKER		R.C.E. No. 68547

R. WORK TO BE DONE:

PER COMMENT

DATES TO BE

MATRIX ITEM 11

THE WORK TO BE DONE CONSISTS OF THE ITEMS INDICATED UNDER THE "LEGEND" SHOWN BELOW, AND IS TO BE DONE IN ACCORDANCE WITH THESE PLANS AND THE FOLLOWING LIST OR PRINTED MATERIALS AS CURRENTLY ADOPTED BY THE CITY OF CHULA VISTA CITY COUNCIL INCLUDING THE FOLLOWING:

- 1. 2012 STANDARD SPECIFICATIONS FOR PUBLIC WORKS CONSTRUCTION ("GREENBOOK") AND 2012 REGIONAL SUPPLEMENT AMENDMENTS (TO THE GREENBOOK).
- 2. 2012 SAN DIEGO AREA REGIONAL STANDARD DRAWINGS. 3. 2015 CITY OF CHULA VISTA STANDARD SPECIAL PROVISIONS (TO THE GREENBOOK).
- 4. 2017 DESIGN AND CONSTRUCTION STANDARDS OF THE CITY OF CHULA VISTA.
- 5. PORTION OF THE STATE STANDARD SPECIFICATIONS, STATE OF CALIFORNIA, DEPARTMENT OF TRANSPORTATION, DATED JULA 2010 AND ALL SUBSEQUENT ADDITIONS AND REVISIONS. TOPTION OF THE STATE STATE STANDARD PLANS, STATE OF CALIFORNIA, DEPARTMENT OF

NOTED - NO CHANGES MADE SB&O, INJESEQUENT ADDITIONS AND REVISIONS. FIC CONTROL DEVICES ("CA-MUTCD") AND ALL

FACILITIES, LATEST EDITION.

ALL REFERENCES ARE TO BE MADE PART OF THESE PLANS. ANY CHANGES OR REVISIONS THEREFROM SHALL BE APPROVED BY THE CITY ENGINEER, OR HIS DESIGNEE, PRIOR TO ANY REQUEST FOR INSPECTION.

11	NSPECTION.		
ESSIONAL ESSIONAL CALLEORNIC	S. LEGEND: PROJECT BOUNDARY PENTERLINE SUBB AND GUTTER PROPERTY/RIGHT-OF WA ASEMENT LINE DIRECTION OF DRAINAGE SUBCECTION OF DRAINAGE CARTHEN SWALE OUT SLOPE (2:1 U.N.O.) PROPOSED CONTOUR DAYLIGHT LINE BUILDING NUMBER SUBGRADE ELEVATION TINISHED FLOOR ELEVATION TINISHED FLOOR ELEVATION TORM DRAIN PIPE SIZE PER PLAN) STORM DRAIN CLEANOUT CURB INLET TOP OF CURB ELEVATION TOP OF CURB ELEVATION TOP OF CURB ELEVATION TOP OF WALL ELEVATION EXISTING ELEVATION EXISTING CONTOUR EXISTING CONTOUR EXISTING CONTOUR EXISTING FIRE HYDRANT SEWER MAIN (PRIVATE) SEWER MANHOLE (PRIVA LEGEND - EXISTING ELEVATION EXISTING FLECTRIC EXISTING FLECTRIC EXISTING FLECTRIC EXISTING FLECTRIC EXISTING FRE HYDRAN EXISTING FIRE HYDRAN EXISTING FIRE HYDRAN EXISTING FIRE HYDRAN EXISTING FIRE HYDRAN EXISTING FIRE HYDRAN EXISTING SEWER EXISTING FIRE HYDRAN EXISTING SEWER EXISTING SEWER EXISTING STORM DRAIN EXISTING STORMACHTON EX	ION SEE PLAN VIEW HDPE WATERTIGHT IB (PER AASHTO) T SDRSD D-09, (A-4), (A-6) SDRSD D-02 (TYPE "B") N ELEVATION V PER SEPARATE PLANS T F F F F F F F F F F F F F F F F F F	
	IF THIS BAR DOES		
	NOT MEASURE 1" THEN DRAWING NOT TO SCALE	MU-1 RESIDEN	NIIAL
	DEVELO	PMENT SERVICES DEPARTMENT	ACCELA NO.: XXXX
			PROJECT NO.: 77222.20
THE CITY OF CHULA VIST			TOTAL SHEETS: 6
AREA FOR	Ву:	Principal Civil Engineer	XXXX - XXXX
CITY APPROVAL			- NAD83 COORDINATES
PRELIMINAR			
NOT FOR CONSTRUCT	ON Planning:	Landscape:	LAMBERT COORDINATES

OMPLETED

Planning:

CONTRACTOR:

INSPECTOR

CHULA

G001

DRAWING NO.

XXXXX.XXX

DATE COMPLETED:

Landscape:

AS BUILT

T. UTILITY NOTIFICATIONS:

1. THE EXISTENCE AND LOCATION OF UNDERGROUND UTILITY PIPES AND STRUCTURES SHOWN THESE PLANS WERE OBTAINED BY A SEARCH OF AVAILABLE RECORD, TO THE BEST OF KNOWLEDGE, THERE ARE NO EXISTING UTILITIES EXCEPT AS SHOWN HEREON, HOWEVER, THE CONTRACTOR IS REQUIRED TO TAKE DUE PRECAUTIONARY MEASURES TO PROTECT ANY EXISTING UTILITIES OR STRUCTURES LOCATED AT THE WORK SITE. IT IS THE CONTRACTOR'S RESPONSIBILITY TO CONTACT UNDERGROUND SERVICE ALERT (PHONE 1-800-422-4133) TWO (2) WORKING DAYS IN ADVANCE OF ANY EXCAVATION FOR THE MARK OUT OF THE LOCATION OF UTILITIES AND NOTIFICATION OF COMMENCEMENT OF WORK.

FOR ANY QUESTIONS REGARDING THE MARK OUT OF UNDERGROUND UTILITIES, THE CONTRACTOR SHOULD CONTACT THE RESPECTIVE UTILITY COMPANY:

STREET LIGHT OR SIGNAL LIGHT CONDUIT / CITY OF CHULA VISTA	(619) 397-6163
SEWER OR STORM DRAIN / CITY OF CHULA VISTA	

VERIFICATION	(619) 691-5024
NOTIFICATION	(619) 397-6000
GAS & ELECTRIC SAN DIEGO GAS & ELECTRIC CO.	1-800-227-2600 / (619) 230-7800
WATER OTAY WATER DISTRICT	(619) 670-2222
SWEETWATER AUTHORITY	(619) 420-1413
TELEPHONE PACIFIC BELL	(619) 266-4683
TELEVISION COX CABLE OF SAN DIEGO / CHULA VISTA CABLE	(619) 263-9251 / (619) 476-0177
ULTRONICS & WORLDWIDE SATELLITE	(619) 422-0776

U. NATIONAL POLLUTANT DISCHARGE ELIMINATION SYSTEM (NPDES) STATEMENT:

DEVELOPMENT OF THIS PROJECT SHALL COMPLY WITH ALL REQUIREMENTS OF STATE WATER RESOURCES CONTROL BOARD (SWRCB) (NPDES GENERAL PERMIT NO. , WASTE DISCHARGE REQUIREMENTS FOR DISCHARGES OF STORM WATER RUNOFF ASSOCIATED WITH CONSTRUCTION ACTIVITY. IN ACCORDANCE WITH SAID PERMIT, A STORM WATER POLLUTION PREVENTION PLAN (SWPPP) AND A MONITORING PROGRAM PLAN SHALL BE DEVELOPED AND IMPLEMENTED CONCURRENT WITH THE COMMENCEMENT OF GRADING ACTIVITIES. THE SWPPP SHALL SPECIFY BOTH CONSTRUCTION AND POST-CONSTRUCTION STRUCTURAL AND NON-STRUCTURAL POLLUTION PREVENTION MEASURES. THE SWPPP SHALL ALSO ADDRESS OPERATION AND MAINTENANCE OF POST-CONSTRUCTION POLLUTION PREVENTIONS MEASURES. INCLUDING SHORT-TERM AND LONG-TERM FUNDING SOURCES AND THE PARTY OR PARTIES THAT WILL BE RESPONSIBLE FOR THE IMPLEMENTATION OF SAID MEASURES.

A COMPLETE AND ACCURATE NOTICE-OF-INTENT (NOI) WILL BE FILLED WITH THE SWRCB, A COPY OF THE ACKNOWLEDGMENT FROM THE SWRCB THAT A NOI HAS BEEN RECEIVED FOR THIS PROJECT SHALL BE FILED WITH THE CITY OF CHULA VISTA WHEN RECEIVED; FURTHER, A COPY OF THE COMPLETED NOI FROM THE SWRCB SHOWING THE PERMIT NUMBER FOR THIS PROJECT BE FILED WITH THE CITY OF CHULA VISTA WHEN RECEIVED.

IN ADDITION, THE UNDERSIGNED AND SUBSEQUENT OWNER(S) OF ANY PORTION OF THE PROPERTY COVERED BY THIS GRADING PERMIT NO. SHALL COMPLY WITH SPECIAL PROVISIONS REGARDING THE REVOCATION OR CANCELLATION OF NPDES GENERAL PERMIT COVERAGE. AS SET FORTH IN SWRCB ORDER NO. CAS000002, AND ANY SUBSEQUENT AMENDMENTS THERETO AND REISSUANCES THEREOF.

OWNER OF LAND:

SIGNATURE OF LAND OWNER, CORPORATE OFFICE, GENERAL PARTNER OR PROPRIETOR

TITLE:

PERMIT IDENTIFICATION NUMBER:

V. LANDSCAPE NOTES

- 1. ALL SLOPES 3 FEET IN VERTICAL HEIGHT AND GREATER SHALL BE PLANTED AND IRRIGATED IN ACCORDANCE WITH LANDSCAPE IMPROVEMENT PLANS CONFORMING TO THE CITY OF CHULA VISTA LANDSCAPE MANUAL (MOST RECENT EDITION), GRADING ORDINANCE NO. 1797, THE WATER CONSERVATION ORDINANCE, AND THE SAN DIEGO COUNTY HANDBOOK FOR PUBLIC WORKS CONSTRUCTION. WHENEVER SPECIAL REQUIREMENTS CONFLICT ON ANY MATTER, THE DIRECTOR OF DEVELOPMENT SERVICES OR DESIGNEE SHALL DETERMINE WHICH SPECIAL CONDITION OR CODE SHALL GOVERN. PLANS SHALL BE APPROVED BY THE DIRECTOR OF DEVELOPMENT SERVICES OR DESIGNEE PRIOR TO ISSUANCE OF APPLICABLE CONSTRUCTION AND BUILDING PERMITS.
- 2. FINISH GRADING AND PLANTING SHALL BE ACCOMPLISHED ON ALL SLOPES PRIOR TO OCTOBER 1 OR IMMEDIATELY UPON COMPLETION OF ANY SLOPES GRADED BETWEEN OCTOBER 1 AND APRIL 1, AS DIRECTED BY THE CITY'S DIRECTOR OF DEVELOPMENT SERVICES.
- 3. PRIOR TO GRADING, CONTRACTOR SHALL FIELD VERIFY EXISTING IRRIGATION SYSTEMS TO DETERMINE WHICH ARE OPERABLE. UNLESS OTHERWISE NOTED ON THESE PLANS, ALL EXISTING IRRIGATION SYSTEMS ARE TO BE PROTECTED IN PLACE AND REMAIN OPERABLE. CONTACT CITY STAFF TWO (2) WORKING DAYS IN ADVANCE OF ANY WORK.

CITY CONTACTS:

SR. LANDSCAPE INSPECTOR - DAVE DEFACCI, (619-409-5432) DDEFACCI@CHULAVISTACA.GOV PARK MANAGER - ERIC GARWICK (619-587-5790) EGARWICK@CHULAVISTACA.GOV OPEN SPACE MANAGER - SAM OLUDUNFE (619-397-6006) SOLUDUNFE@CHULAVISTACA.GOV PUBLIC WORKS SUPERINTENDENT - KALANI CAMACHO (619-397-6113) KALANIC@CHULAVISTACA.GOV

4. FOR LANDSCAPE AND IRRIGATION PLANS, SEE BUILDING PERMIT NO. _____ OR CITY OF CHULA VISTA DRAWING NO.

W. RCP STORM DRAIN BEVELING NOTES:

1. WHERE RADIUS=90 FEET TO 45 FEET, USE 8-FOOT LENGTH OF PIPE BEVELED ONE END.

2. WHERE RADIUS CURVE= 45 FEET TO 22 1/2 FEET, USE 8- FOOT LENGTH OF PIPE BEVELED BOTH ENDS

- 3. WHERE RADIUS CURVE=22 ½ FEET, USE 4-FOOT LENGTH OF PIPE BEVELED BOTH ENDS.
- 4.CONTRACTOR SHALL PROVIDE LAYOUT SHEET OF BEVELED PIPE PRIOR TO BEGINNING INSTALLATION.

N ON	
OUR	1. REFERENCE MANUFACTURER INSTALLATION GUIDE
THE	DEFLECTION.

- 2. CURVILINER INSTALLATIONS SPECIFIED PER THIS PLAN ARE BASED ON CHAPTER 5 (INSTALLATION) OF THE ADS, INC. DRAINAGE HANDBOOK, AND ASSUME THE USE OF "N-12 WT IP" AND/OR "HP STORM" GASKETED WATERTIGHT COUPLERS, FOR RADII LESS THAN THAT ACHIEVABLE WITH STANDARD JOINT DEFLECTION A SERIES OF PREFABRICATED BENDS SHALL BE UTILIZED.
- 3. ALL CONCRETE STRUCTURES USED WITH HDPE PIPE MUST BE WATERTIGHT.
- 4. TRENCH BACKFILL FOR HDPE N-12 PER SDRSD SP-02 WITH FILTER FABRIC FULLY SURROUNDING ROCK ZONE.
- 5. TRENCH BACKFILL FOR HP PER SDRSD SP-02 WITH ROCK TO PIPE CROWN AND FILTER FABRIC ROCK ZONE.

Y. SPECIAL NOTES:

- 1. THE CONTRACTOR SHALL BE RESPONSIBLE FOR VERIFYING THE QUANTITIES SHOWN HEREON AND BALANCING THE EARTHWORK ONSITE. IF DISCREPANCIES ARISE, THE ENGINEER OF WORK SHALL PROVIDE AREAS OF ADJUSTMENT TO THE CONTRACTOR. WHERE TRENCHES ARE WITHIN EASEMENTS, STREETS, OR 10' OF ANY BUILDING, SOILS REPORTS SHALL BE SUBMITTED TO THE ENGINEER OF WORK BY A QUALIFIED SOILS ENGINEER WHICH INDICATE THAT THE TRENCH BACKFILL WAS COMPACTED UNDER THE OBSERVATION OF THE SOILS ENGINEER AND IN ACCORDANCE WITH THE EARTHWORK SPECIFICATIONS.
- 2. THE CONTRACTOR SHALL BE RESPONSIBLE TO INSURE THAT ALL SLOPES ARE BUILT IN ACCORDANCE WITH THESE PLANS. IF THERE IS ANY QUESTION REGARDING THESE PLANS OR FIELD STAKES, THE CONTRACTOR SHALL REQUEST AN INTERPRETATION BEFORE DOING ANY
- 3. THE PALEONTOLOGICAL MONITOR SHALL BE PRESENT DURING THE GRADING OF THE PLIOCENE SAN DIEGO FORMATION (TSD) ON THE SITE. THE MONITOR SHALL HICOMPLETED TEMPORARY DIRECT, DIVERT, OR HALT GRADING TO ALLOW RECOVERY OF
- 4. THE CONTRACTOR SHALL UNCOVER ALL UTILITIES THAT MAYBE JOINED, CROSSED, OR PARALLELED TO VERIFY BOTH HORIZONTAL AND VERTICAL LOCATION PRIOR TO ANY CONSTRUCTION. ANY CONFLICT OR DISCREPANCY SHALL BE BROUGHT TO THE ENGINEER'S ATTENTION PRIOR TO CONSTRUCTION, OTHERWISE THE CONTRACTOR ACCEPTS FULL RESPONSIBILITY FOR ANY ADDITIONAL CONSTRUCTION OR RELOCATION COSTS.
- 5. ALL FILL AREAS, WHICH ARE FENCED, SHALL REMAIN FENCED, TEMPORARY AND/OR FINAL FENCING SHALL BE PROVIDED AS SHOWN ON THE PLANS.
- 6. ALL APPROVED GEOTEXTILE ENGINEERING FABRIC SHALL BE INSTALLED PER MANUFACTURERS SPECIFICATIONS.
- 7. A 6" MINIMUM THICKNESS BEDDING BLANKET UNDERDRAIN BY A LAYER OF GEOTEXTILE (MIRAFI 700X OR EQUIVALENT) SHALL BE CONSTRUCTED BENEATH ALL RIP RAP. THE BEDDING BLANKET SHALL MEET THE FOLLOWING SPECIFICATIONS:
- a) FRACTION PASSING THE NO. 3/8 IN. STANDARD SIEVE SHALL BE 100% BY WEIGHT. b) ANY SOURCE OF ON-SITE MATERIAL DEEMED SUITABLE BY THE SOILS ENGINEER.
- 8. THE CONTRACTOR SHALL BE RESPONSIBLE FOR LOCATING, MAINTAINING, RELOCATING, AND OR REMOVAL OF EXISTING UTILITIES.
- 9. THE CONTRACTOR SHALL REPLACE ALL DESTROYED OR DAMAGED SURFACE IMPROVEMENTS WITH IMPROVEMENTS EQUAL OR SUPERIOR.
- 10. ALL CONTOURS AND ELEVATIONS SHOW HEREON REPRESENT FINISH GRADE. CONTRACTOR SHALL MAKE THE APPROPRIATE ALLOWANCES FOR PAVEMENT SUBGRADE, PAD UNDERCUT, AND UTILITY TRENCHING.
- 11. THE ENGINEER PREPARING THESE PLANS WILL NOT BE RESPONSIBLE FOR UNAUTHORIZED CHANGES TO OR USES OF THESE PLANS. ALL PROPOSED CHANGES TO THE PLANS MUST BE WRITING AND MUST BE APPROVED BY THE PREPARER OF THESE PLANS AND THE CITY OF CHULA VISTA.

AA. MITIGATION MONITORING AND REPORTING PROGRAM NOTES:

MONUMENT PRESERVATION CERTIFICATION

THE PERMITTEE SHALL BE RESPONSIBLE FOR THE COST OF REPLACING ALL SURVEY MONUMENTS DESTROYED BY CONSTRUCTION. IF A VERTICAL CONTROL MONUMENT IS TO BE DISTURBED OR DESTROYED, THE CITY OF SAN DIEGO FIELD SURVEY SECTION SHALL BE NOTIFIED IN WRITING AT LEAST 7 DAYS PRIOR TO DEMOLITION/CONSTRUCTION. THE TYPE OF CONSTRUCTION WILL NOT AFFECT ANY SURVEY MONUMENTS (THIS LINE IS FOR PROJECTS THAT ARE

PROPOSING NO DEMOLITION, TRENCHING, ASSOCIATED WITH A CIP, ETC)

NAME

By | Date | App'd

NAME DATE PRIOR TO PERMIT ISSUANCE, THE PERMITTEE SHALL RETAIN THE SERVICE OF A PROFESSIONAL LAND SURVEYOR OR CIVIL ENGINEER AUTHORIZED TO PRACTICE LAND SURVEYING WHO WILL BE RESPONSIBLE FOR MONUMENT PRESERVATION AND SHALL PROVIDE A CORNER RECORD OR RECORD OF SURVEY TO THE COUNTY SURVEYOR AS REQUIRED BY THE PROFESSIONAL LAND SURVEYORS ACT, IF APPLICABLE. (SECTION 8771 OF THE BUSINESS AND PROFESSIONS CODE OF THE STATE OF CALIFORNIA)

I HAVE INSPECTED THE SITE AND DETERMINED THAT:

- □ NO SURVEY MONUMENTS WERE FOUND WITHIN THE LIMITS OF WORK SURVEY MONUMENTS EXISTING IN OR NEAR LIMITS OF WORK WILL BE PROTECTED IN PLACE
- SURVEY MONUMENTS HAVE BEEN TIED OUT AND A FINAL OR PARCEL MAP WILL BE FILED (NO CORNER RECORD OR RECORD OF SURVEY WILL BE REQUIRED)
- OTHER AGENCY SURVEY MONUMENT (CORNER RECORD OR RECORD OF SURVEY MAY NOT BE REQUIRED). AGENCY HAS BEEN NOTIFIED OF POSSIBLE MONUMENT DESTRUCTION AND A LETTER PROVIDED TO CITY
- A PRE-CONSTRUCTION CORNER RECORD (OR RECORD OF SURVEY) FOR SURVEY MONUMENTS FOUND WITHIN THE LIMITS OF WORK HAS BEEN FILED.
- CORNER RECORD # OR RECORD OF SURVEY #

NAM	Œ P.L.S. / R.	C.E. NO. XXXXX	EX
POS	T CONSTRUCTION CORNER F	RECORD (AS-BUILT ITE	<u>M)</u>
	POST CONSTRUCTION COR AND REPLACED AFTER CO		RVEY MONU
	CORNER RECORD #	OR RECORD O	F SURVEY #

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REVISIONS

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	DATE:	DIGALERT
SIGNATURE AARON PARKER	P.E. No.: 68547	WITHIN AND AND AND AND AND AND AND AND AND AN
PRINTED NAME	P.E. No.: 00347	
REGISTRATION EXPIRES: 9-30-23	DISCIPLINE: CIVIL	811
REFERENCE DRAWINGS	REVI	SIONS

X. HDPE & HP STORM DRAIN INSTALLATION NOTES:

AND SPECIFICATIONS FOR MAXIMUM JOINT

COMPLETE

XP. XX-XX-XX

JMENTS DESTROYED DURING CONSTRUCTION

DATE

EXP. XX-XX-XX DATE

. EROSION CONTROL NOTES: (MOVE TO EROSION CONTROL SHEET) 1. THE EROSION CONTROL CONTRACTOR SHALL BE RESPONSIBLE FOR THE INSPECTION AND MODIFICATION OF THE EROSION CONTROL DEVICES DURING THE RAINY SEASON. THE CONTRACTOR, PERMITTEE OR OWNER SHALL BE RESPONSIBLE FOR THE CONTINUAL MAINTENANCE OF THE EROSION CONTROL DEVICES DURING THE RAINY SEASON. IN THE EVENT O FAILURE OR REFUSAL TO PROPERLY MAINTAIN SAID DEVICES. THE CITY ENGINEER OR MITIGATION MONITOR MAY CAUSE EMERGENCY MAINTENANCE WORK TO BE DONE TO PROTECT ADJACENT


2. SEDIMENTATION BASINS MAY NOT BE REMOVED OR MADE INOPERATIVE WITHOUT PRIOR WRITTEN APPROVAL OF THE CITY ENGINEER AND MITIGATION MONITOR.

PRIVATE AND PUBLIC PROPERTY, THE COST (INCLUDING AN INITIAL MOBILIZATION AMOUNT) OF


WHICH SHALL BE CHARGED TO THE OWNER.

- 3. TEMPORARY EROSION CONTROL DEVICES, WHICH INTERFERE WITH THE WORK, SHALL BE RELOCATED OR MODIFIED AS THE WORK PROGRESSES, AS RECOMMENDED BY THE ENGINEER OF WORK AND AS APPROVED BY THE CITY ENGINEER AND MITIGATION MONITOR.
- 4. ALL REMOVABLE PROTECTION DEVICES SHOWN SHALL BE IN PLACE AT THE END OF EACH WORKING DAY WHEN THE 5-DAY RAIN PROBABILITY FORECAST EXCEEDS 40 PERCENT. AFTER EACH RAINSTORM EXCEEDING 1/4 INCH IN A 12-HOUR PERIOD, SILT AND DEBRIS SHALL BE REMOVED FROM CHECK DAMS AND DESILTING BASINS AND BASINS SHALL BE PUMPED DRY AS DEEMED NECESSARY BY THE CITY ENGINEER AND MITIGATION MONITOR.
- 5. PLANTING SHALL BE INSTALLED, FULLY GERMINATED, AND SHALL EFFECTIVELY COVER THE REQUIRED SLOPES PRIOR TO FINAL APPROVAL. THE PLANTING MIX SHALL BE APPROVED, BY THE DIRECTOR OF DEVELOPMENT SERVICES OR DESIGNEE, PRIOR TO INSTALLATION. SPRINKLER SYSTEMS ARE REQUIRED ON ALL SLOPES THREE FEET IN VERTICAL HEIGHT OR GREATER.
- 6. A 12 INCH HIGH BY 3 FEET WIDE BERM SHALL BE MAINTAINED ALONG THE TOP OF THE SLOPE OF THOSE FILLS ON WHICH GRADING IS NOT IN PROGRESS. CONCENTRATED WATER SHALL NOT BE CARRIED CLOSER THAN 10 FEET FROM THE TOP OF SLOPES.
- 7. SILT BASINS, TRAPS, OR SANDBAGS SHALL BE PROVIDED AT EVERY STORM DRAIN INLET TO PREVENT SEDIMENT FROM ENTERING THE STORM DRAIN SYSTEM.
- 8. FOR INLETS LOCATED AT SUMPS ADJACENT TO TOP OF SLOPE, THE CONTRACTOR SHALL INSURE THAT WATER DRAINING TO THE SUMPS IS DIRECTED INTO THE INLET, AND THAT A MINIMUM OF 1.00' FREEBOARD EXISTS AND IS MAINTAINED ABOVE THE TOP OF THE INLET. IF FREEBOARD IS NOT PROVIDED BY GRADING SHOWN ON THESE PLANS, THE CONTRACTOR SHALL PROVIDE IT VIA TEMPORARY MEASURES, I.E. SANDBAGS OR DIKES.
- 9. THE GRADING CONTRACTOR SHALL BE RESPONSIBLE FOR CLEANUP OF SILT AND MUD ON ADJACENT STREETS DUE TO CONSTRUCTION ACTIVITY.
- 10. THE CONTRACTOR SHALL CHECK AND MAINTAIN LINED AND UNLINED DITCHES AFTER EACH RAINFALL.
- 11. HYDROSEED NOTES (APPLICABLE ONLY IF THERE WILL BE SLOPES THREE FEET IN VERTICAL EIGHT OR GREATER
 - A. ALL SLOPES 3 FEET IN VERTICAL HEIGHT OR GREATER AND PADS STEEPER THAN 2% SHALL BE HYDROSEEDED WITH THE FOLLOWING IRRIGATED SEED MIX, MULCH AND BINDING AGENT
 - (CONSULTANT TO INSERT THE PROPOSED SEED MIX HERE)
 - B. IRRIGATION METHODS ARE REQUIRED FOR ALL AREAS HYDROSEEDED BETWEEN MARCH 1ST AND NOVEMBER 1ST AS NEEDED. IMMEDIATELY FOLLOWING HYDROSEED APPLICATION, AND FOR A PERIOD OF TIME OF NO LESS THAN 90 DAYS, ADEQUATE SOIL MOISTURE SHALL BE MAINTAINED IN THE UPPER ONE-HALF INCH OF SOIL TO ASSURE MAXIMUM RATES OF SEED GERMINATION AND PLANT ESTABLISHMENT. IRRIGATION SHALL BE MAINTAINED BEYOND THE 90 DAYS WHEN DEEMED NECESSARY BY THE CITY OF CHULA VISTA PUBLIC WORKS OPERATIONS, OPEN SPACE SECTION.
 - C. IRRIGATION SYSTEMS ARE NOT REQUIRED FOR AREAS HYDROSEEDED ON (OR WITHIN ONE WEEK OF) NOVEMBER 1ST; HOWEVER, TEMPORARY WATERING (BY HAND OR TRUCK) IS REQUIRED UNTIL PLANTING IS ESTABLISHED IF RAINFALL IS NOT PRESENT.

BB. SHEET MAP: 1" = 100'

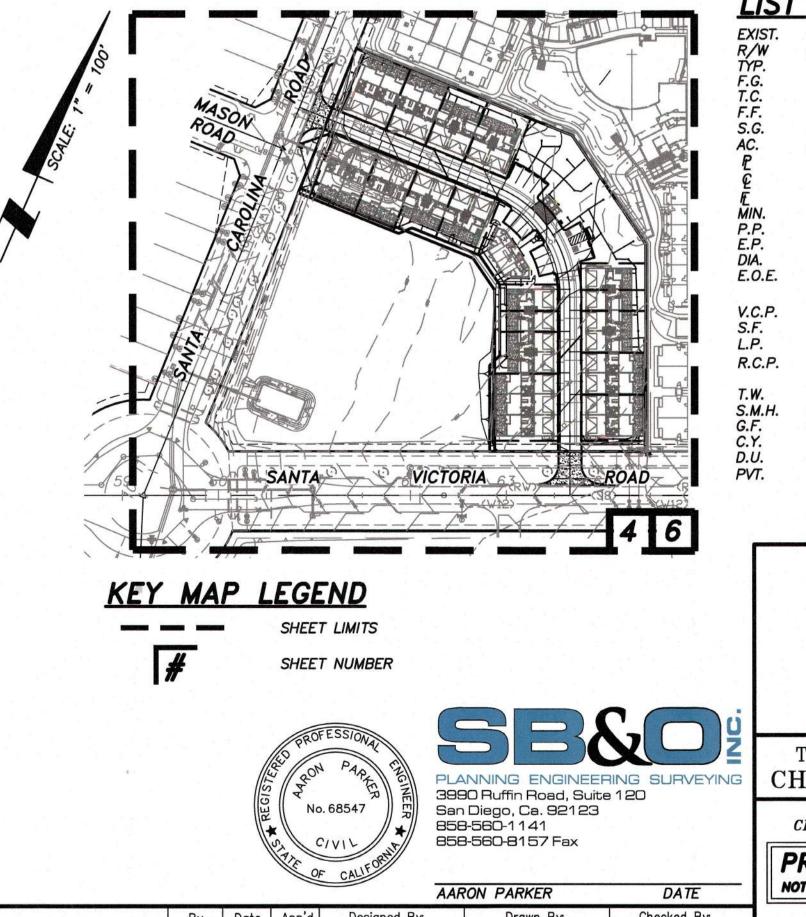

Checked By: By | Date | App'd REVISIONS By | Date | App'd | Designed By: Drawn By: P.R.S., A.P., C.F. SB&O P.R.S., A.P., C.F Date: Plans Prepared Under Supervision Of: AARON PARKER R.C.E. No. 68547

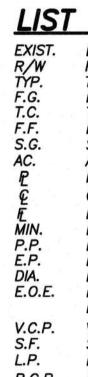

SC-F FOO SC-G REF SC-H INDU SC-I OUT SC-J VEH SC-K VEH SC-L FUE SC-M LOA SC-N FIRE SC-O MISC SC-P PLAZ SC-Q SC-6 SC-R SC-6 SC-S SC-6 SC-T SC-6

COMPLETÉ			
SOURCE CONCOMPLETED PER P CHECKLIS	ST	FORM	1- 4A
ALL DEVELOPMENT PROJECTS MUST IMPLEMENT SOURCE CONTROL BMP'S. REFER TO CHAPTER BMP DESIGN MANUAL FOR INFORMATION TO IMPLEMENT BMPS SHOWN IN THIS CHECKLIST	R 4 AND APPE	NDIX E OF THE	an an an
SOURCE CONTROL REQUIREMENTS		APPLIED?	
4.2.1 PREVENTION OF ILLICIT DISCHARGES INTO THE MS4	YES	NO NO	□ N/A
4.2.2 STORM DRAIN STENCILING OR SIGNAGE	YES	NO NO	□ N/A
4.2.3 PROTECTION OUTDOOR MATERIALS STORAGE AREAS FROM RAINFALL, RUN-ONS RUNOFFS, AND WIND DISPERSAL	YES	D NO	□ N/A
4.2.4 PROJECT MATERIALS STORED IN OUTDOOR WORK AREAS FROM RAINFALL, RUN-ONS RUNOFFS, AND WIND DISPERSAL	YES	D NO	□ N/A
4.2.5 PROTECT TRASH STORAGE AREAS FROM RAINFALL, RUN-ONS, RUNOFF, AND WIND DISPERSAL	YES	NO NO	□ N/A
4.2.6 BMPS BASED ON POTENTIAL SOURCES OF RUNOFF POLLUTANTS	YES	NO NO	🗖 N/A
SC-A ON-SITE STORM DRAIN INLETS	YES	NO NO	□ N/A
SC-B INTERIOR FLOOR DRAINS AND ELEVATOR SHAFT SUMP PUMPS	YES	NO NO	□ N/A
SC-C NEED FOR FUTURE INDOOR & STRUCTURAL PEST CONTROL	YES	NO NO	□ N/A
SC-D LANDSCAPE/OUTDOOR PESTICIDE USE	YES	NO I	□ N/A
SC-E POOLS, SPAS, POUND, DECORATIVE FOUNTAINS, AND OTHER WATER FEATURES	YES	NO 🗌	🗖 N/A
SC-F FOOD SERVICE	YES	NO NO	□ N/A
SC-G REFUSE AREAS	YES	NO 🗌	🗖 N/A
SC-H INDUSTRIAL PROCESSES	YES	D NO	🗖 N/A
SC-I OUTDOOR STORAGE OF EQUIPMENT OR MATERIALS	YES	NO 🗌	🗖 N/A
SC-J VEHICLE / EQUIPMENT CLEANING	YES	NO 🗌	🗖 N/A
SC-K VEHICLE / EQUIPMENT REPAIR AND MAINTENANCE	YES	D NO	□ N/A
SC-L FUEL DISPENSING AREA	YES	D NO	🗖 N/A
SC-M LOADING DOCKS	YES	D NO	🗖 N/A
SC-N FIRE SPRINKLER TEST WATER	YES	NO NO	□ N/A
SC-O MISCELLANEOUS DRAIN OR WASH WATER	YES	D NO	□ N/A
SC-P PLAZAS, SIDEWALKS, AND PARKING LOTS	YES	D NO	🗖 N/A
SC-Q SC-6A: LARGE TRASH GENERATING FACILITIES	YES	D NO	🗖 N/A
SC-R SC-6B: ANIMAL FACILITIES	YES	NO	□ N/A
SC-S SC-6C: PLANTS NURSERIES AND GARDEN CENTERS	YES	NO	□ N/A
SC-T SC-6D AUTOMOTIVE -RELATED ISSUES			

		X				
SITE	E DESIGN	BMP	CHECKLIST	FC	ORM 1	- 5A
	JECTS MUST IMPLEMENT : MENT BMPS SHOWN IN TH		DL BMP'S. REFER TO CHAPTER 4 AND	APPENDIX E OF TH	HE BMP DESIGN M	ANUAL FOR
	SITE DESIGN R	EQUIREMENTS			APPLIED?	
4.3.1 MAINTAIN NATURAL	DRAINAGE PATHWAYS A	ND HYDROLOGIC	ALFEATURES	YES	NO	□ N/A
4.3.2 CONSERVE NATURA	AL AREAS, SOILS, AND VEC	ETATION		YES	NO NO	□ N/A
4.3.3 MINIMIZE IMPERVIC	OUS AREA			YES	NO NO	□ N/A
4.3.4 MINIMIZE SOIL COM	IPACTION			YES	NO NO	□ N/A
4.3.5 IMPERVIOUS AREA	DISPERSION			YES	NO NO	□ N/A
4.3.6 RUNOFF COLLECTION	ON			YES	NO NO	□ N/A
4.3.7 LANDSCAPING WITH	H NATIVE OR DROUGHT TO	DLERANT SPECIE	S	YES	NO NO	□ N/A

LIST OF ABBREVIATIONS

4.3.8 HARVESTING AND USING PRECIPITATION


	and the second se	
EXISTING	B.W.	BOTTOM OF WALL
RIGHT-OF-WAY	H.P.	HIGH POINT
TYPICAL	F.S.	FINISHED SURFACE
FINISHED GRADE	С.В.	CATCH BASIN
TOP OF CURB	C.O.	CLEANOUT
FINISHED FLOOR	D.G.	DECOMPOSED GRANITE
SUBGRADE	P.C.C.	PORTLAND CEMENT
ACRE		CONCRETE
PROPERTY LINE	STA.	STATION
CENTERLINE	DWG.	DRAWING
FLOW LINE	MAX.	MAXIMUM
MINIMUM	ELEV.	ELEVATION
POWER POLE	0.C.	ON CENTER
EDGE OF PAVEMENT	SIM.	SIMILAR
DIAMETER	ST. LT.	STREET LIGHT
EXISTING OVERHEAD	PVT.	PRIVATE
ELECTRIC	DWY.	DRIVEWAY
VITRIFIED CLAY PIPE	PKWY.	PARKWAY
SQUARE FEET	S.D.C.O.	
LOW POINT		CLEANOUT
	GTR.	GUTTER
REINFORCED CONCRETE	MOD.	MODIFIED
PIPE	S.C.O.	SEWER CLEANOUT
TOP OF WALL	U.N.O.	UNLESS NOTED
SEWER MANHOLE		OTHERWISE
GARAGE FLOOR	I.E.	INVERT ELEVATION
CUBIC YARD	DWY.	DRIVEWAY
DWELLING UNIT	N.A.P.	NOT A PART
PRIVATE	BTM.	BOTTOM
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	0 1/2 1 IF THIS BAR DOES NOT MEASURE 1" THEN DRAWING NOT TO SCALE	KEY MAP/NOTES/DETAI TYPICAL SECTIONS SHEET MU-1 RESIDEN	Г FOR	
	DEVELO	PMENT SERVICES DEPARTMENT	ACCELA NO.: PROJECT NO.:	
HE CITY OF ULA VISTA	Approved: By:	TOTAL SHEETS: 6 XXXX – XXXX NAD83 COORDINATES		
AREA FOR TY APPROVAL	Submitted:			
ELIMINARY FOR CONSTRUCTION	By: Planning: Landscape:		XXXX – XXXX LAMBERT COORDINATES	
		AS BUILT	DRAWING NO.	
	CONTRACTOR:	DATE COMPLETED:	XXXXX.XXX	G002

NO NO

N/A

YES

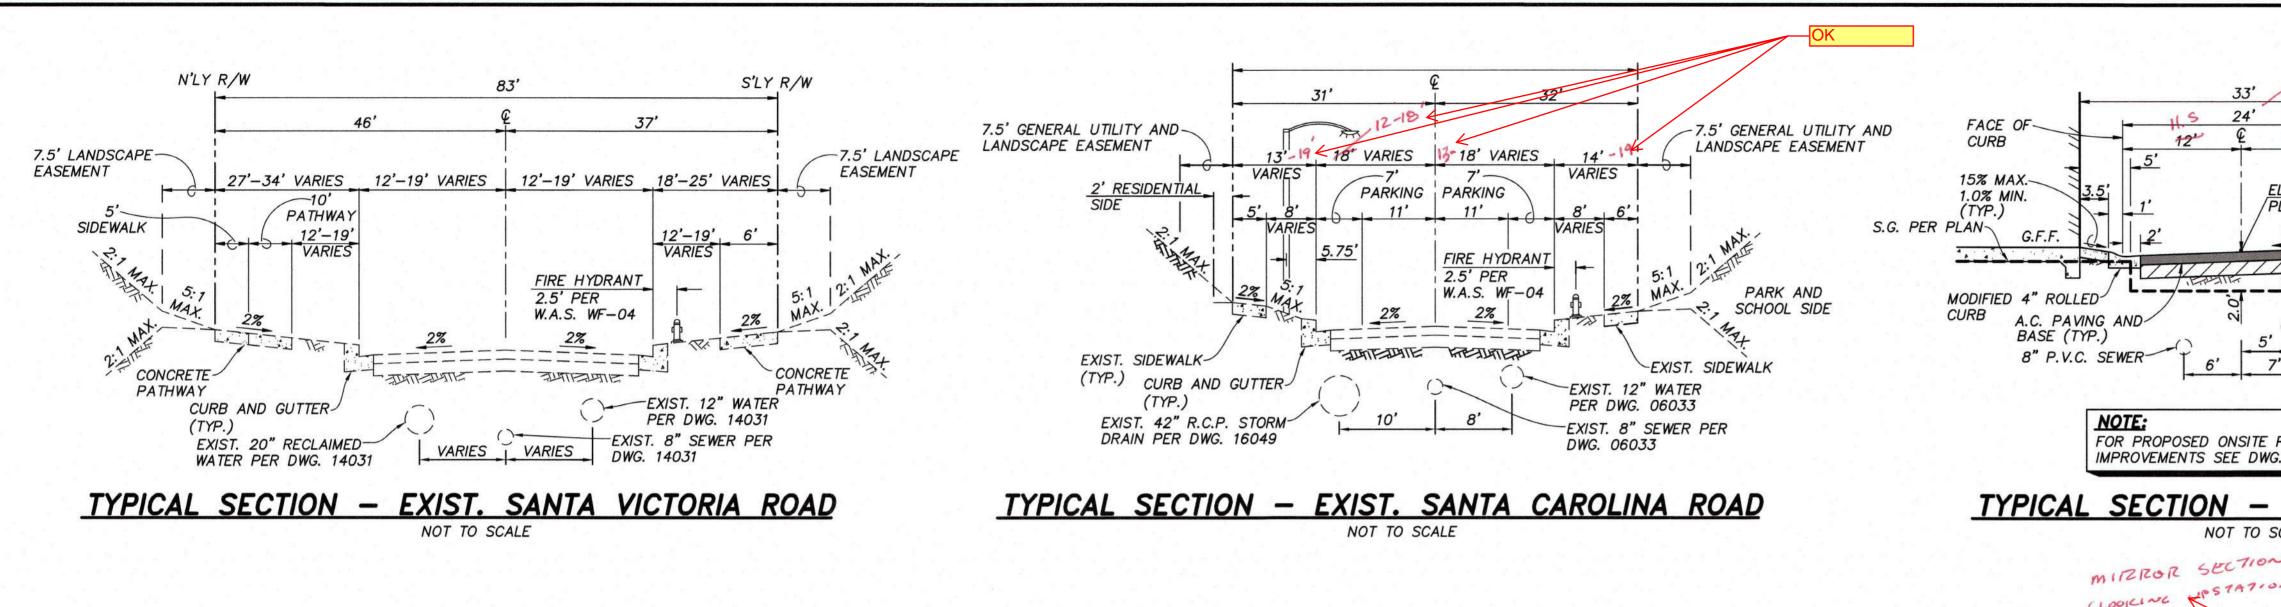

By Date App'd

REVISIONS

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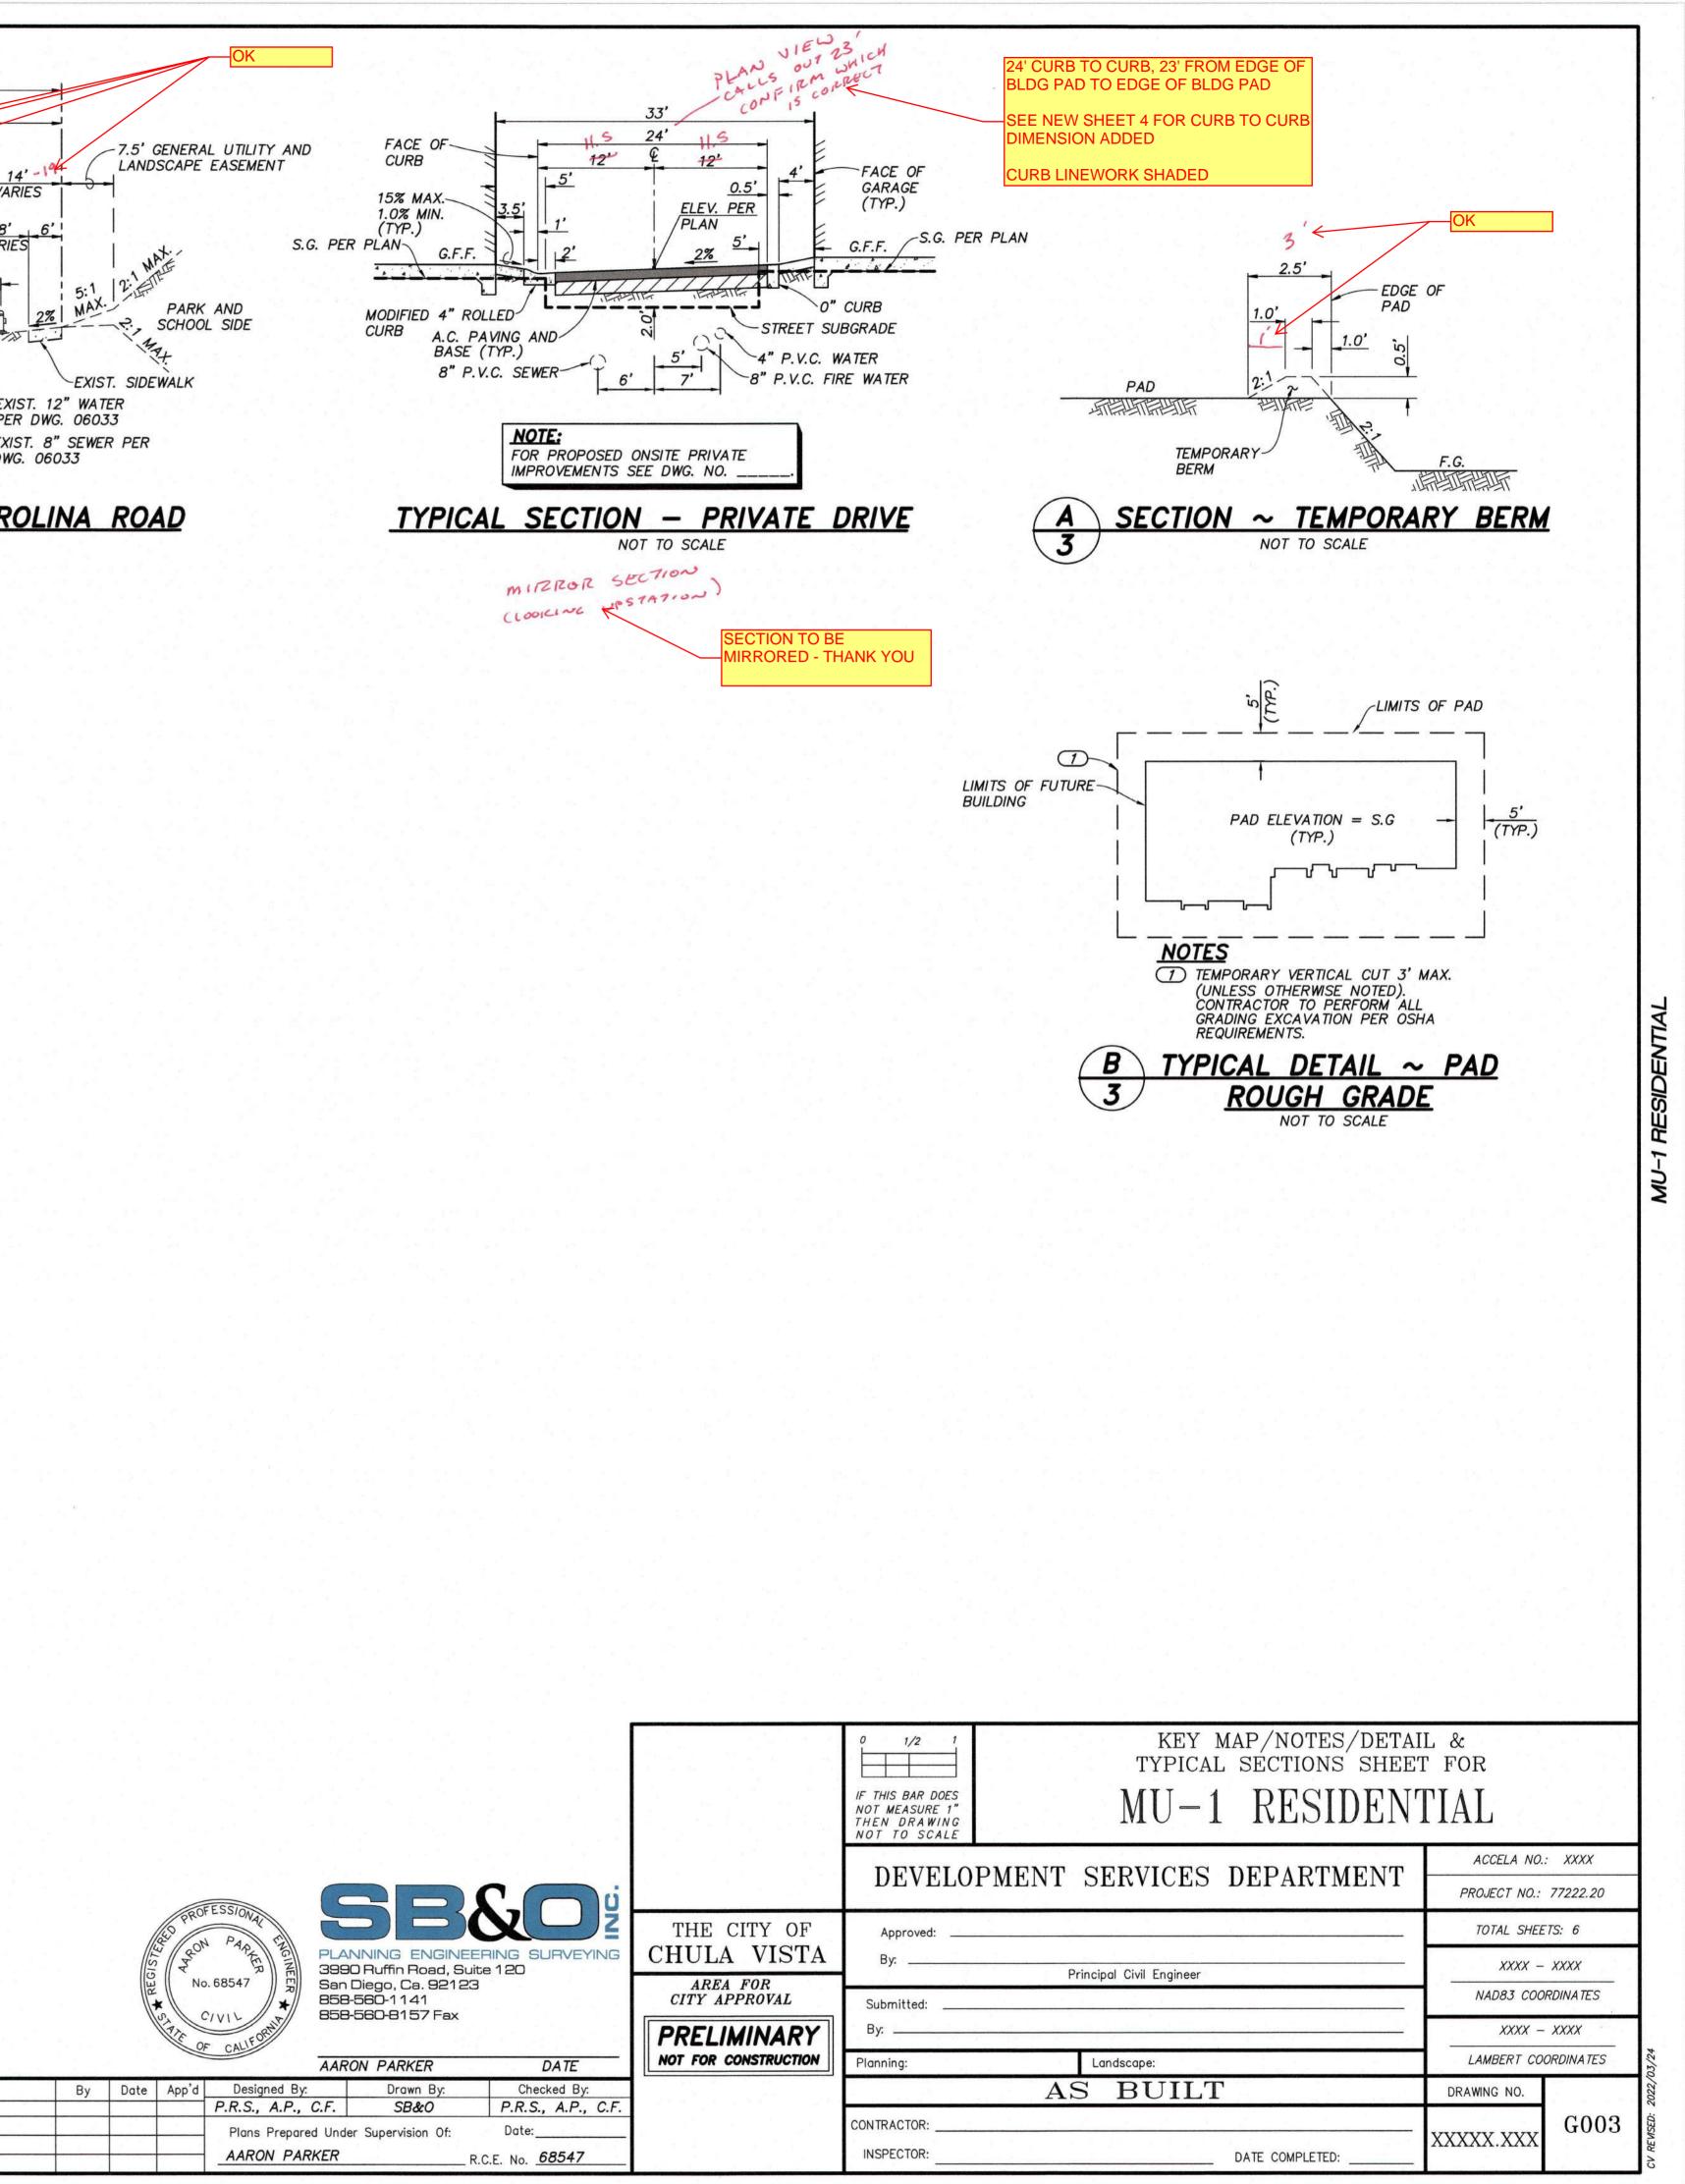
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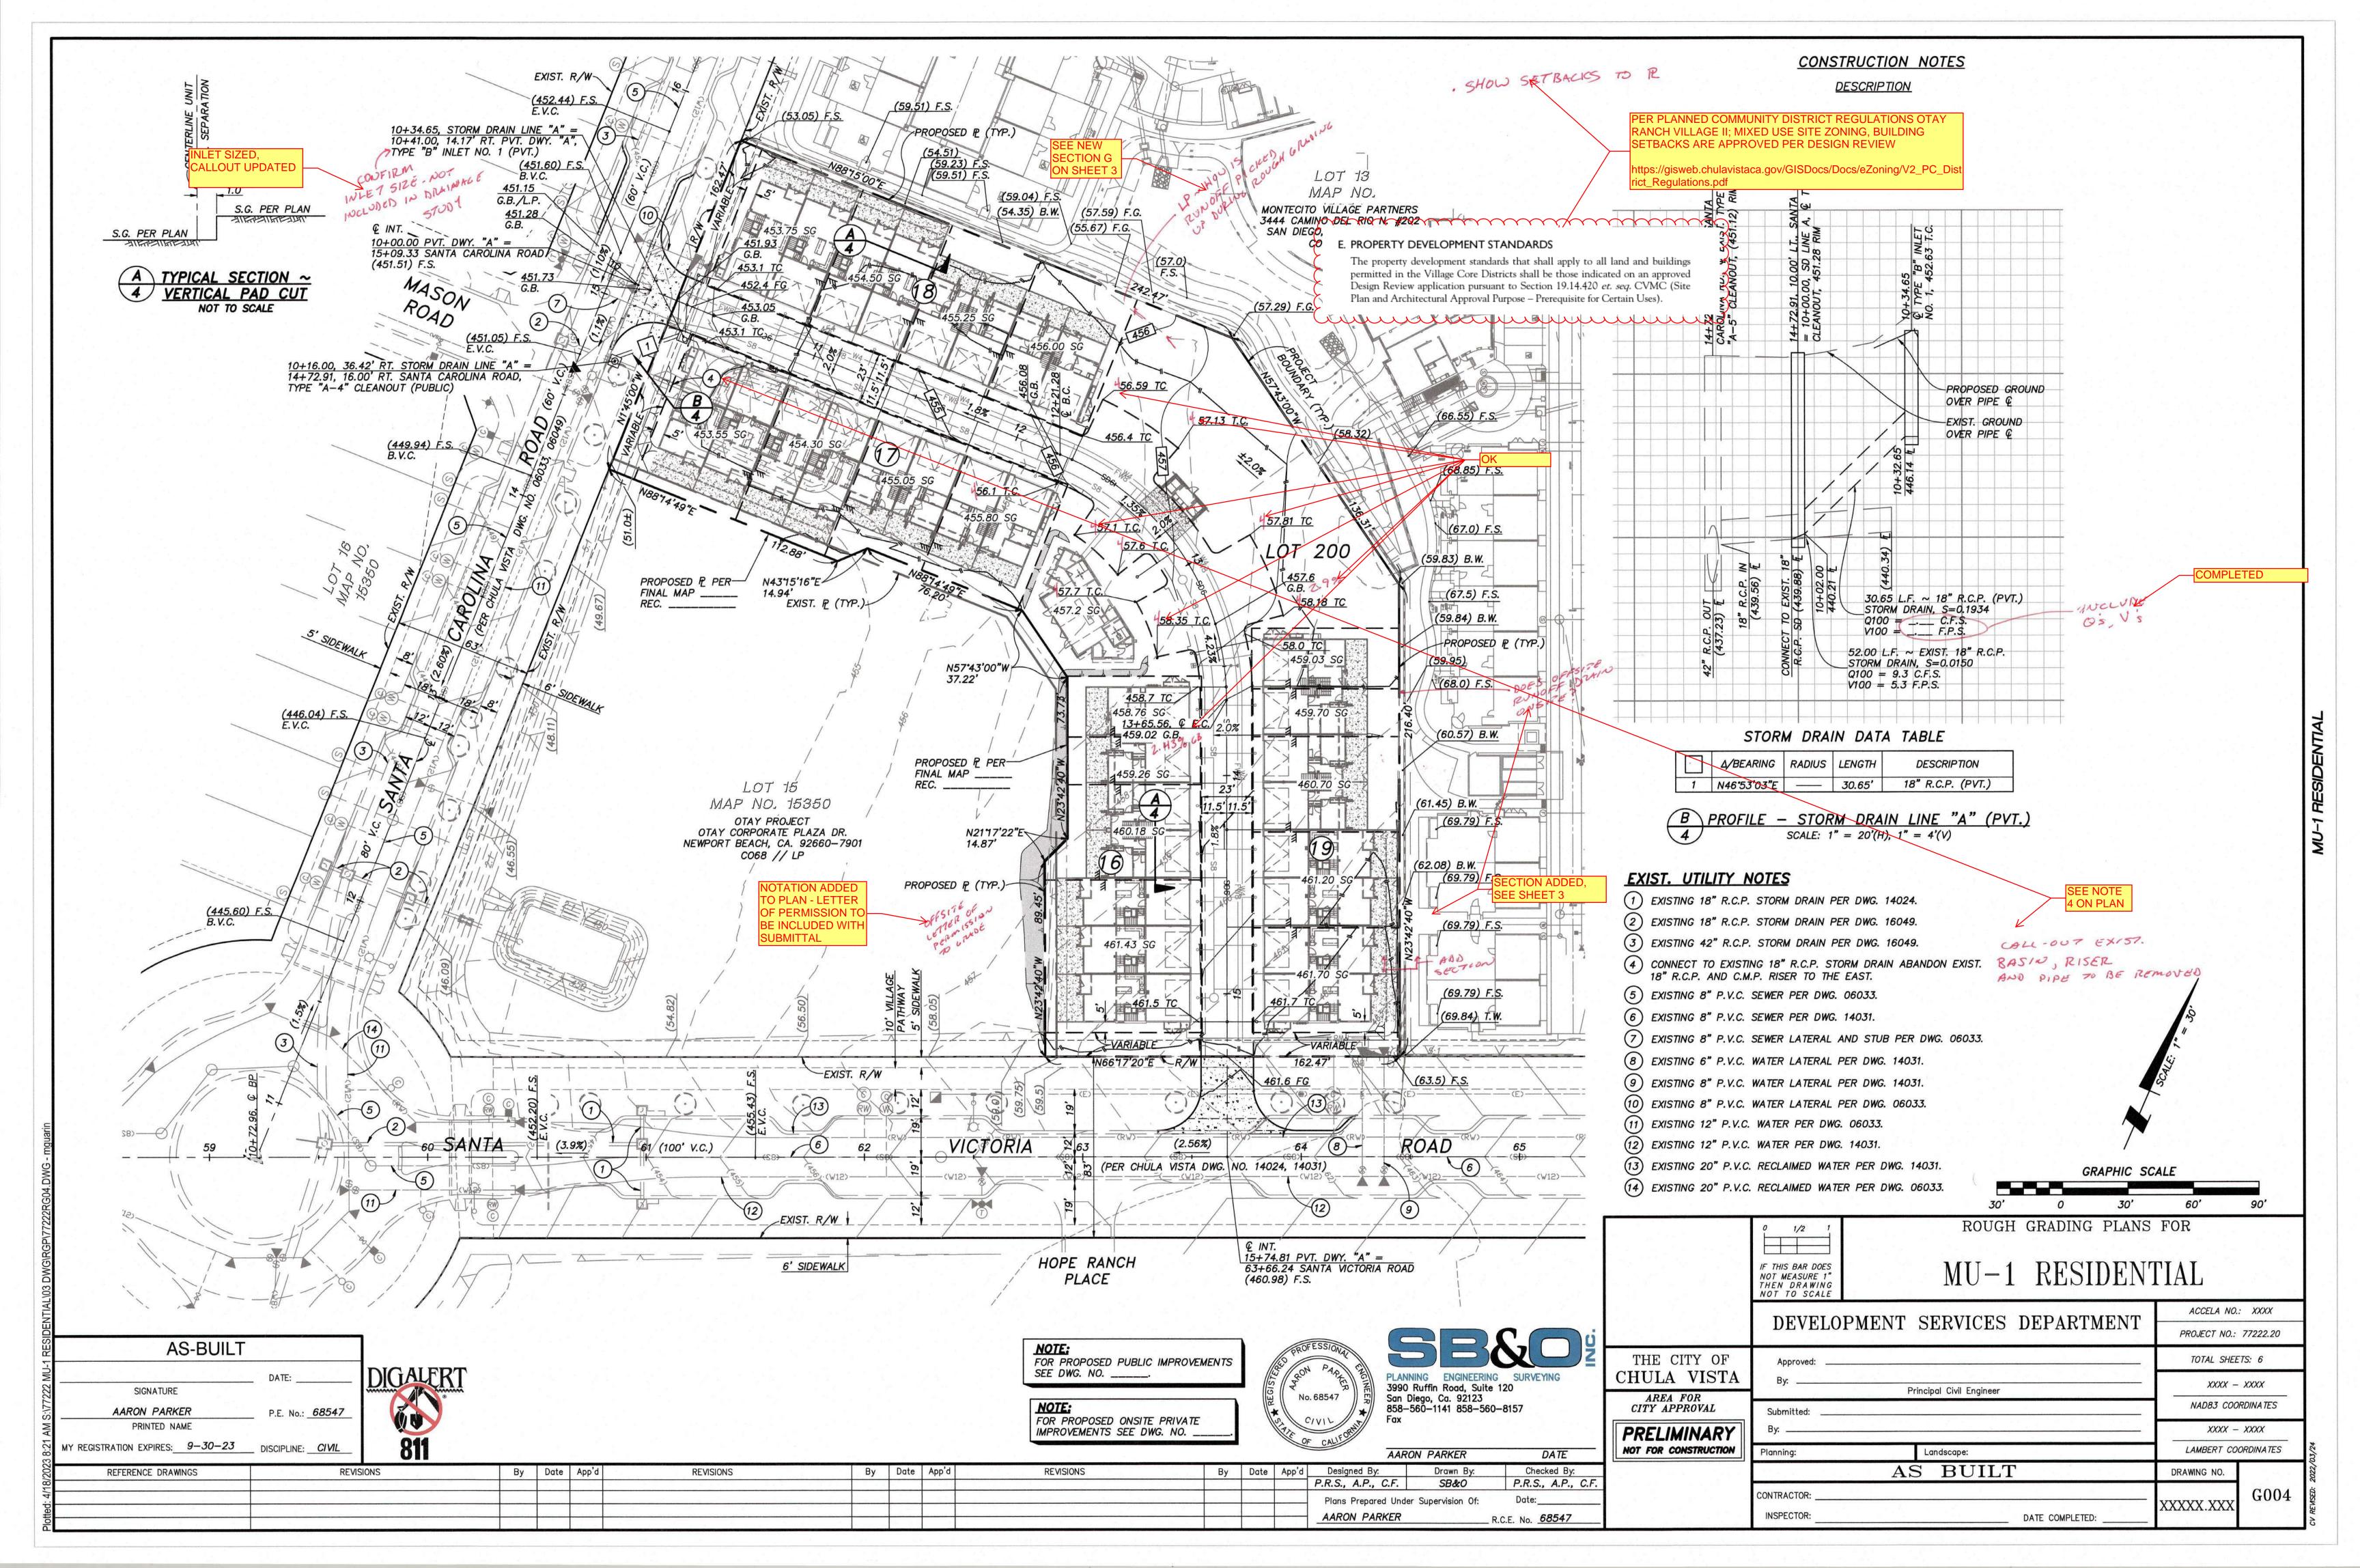
SIGNATURE
<u>AARON PARKER</u> P.E. No.: <u>68547</u>
PRINTED NAME

MY REGISTRATION EXPIRES: 9-30-23 DISCIPLINE: CIVIL

DIGALER

811





EROSION CONTROL NOTES

PRIOR TO COMPLETION OF FINAL IMPROVEMENTS, TEMPORARY EROSION CONTROL SHALL BE PERFORMED AND INSTALLED BY THE CONTRACTOR AS INDICATED BELOW:

- 1. THE EROSION CONTROL CONTRACTOR SHALL BE RESPONSIBLE FOR THE INSPECTION AND MODIFICATION OF THE EROSION CONTROL DEVICES DURING THE RAINY SEASON. THE CONTRACTOR. PERMITTEE OR OWNER SHALL BE RESPONSIBLE FOR THE CONTINUAL MAINTENANCE OF THE EROSION CONTROL DEVICES DURING THE RAINY SEASON. IN THE EVENT OF FAILURE OR REFUSAL TO PROPERLY MAINTAIN SAID DEVICES, THE CITY ENGINEER OR MITIGATION MONITOR MAY CAUSE EMERGENCY MAINTENANCE WORK TO BE DONE TO PROTECT ADJACENT PRIVATE AND PUBLIC PROPERTY, THE COST (INCLUDING AN INITIAL MOBILIZATION AMOUNT) OF WHICH SHALL BE CHARGED TO THE OWNER.
- 2. SEDIMENTATION BASINS MAY NOT BE REMOVED OR MADE INOPERATIVE WITHOUT PRIOR WRITTEN APPROVAL OF THE CITY ENGINEER AND MITIGATION MONITOR.
- 3. TEMPORARY EROSION AND SEDIMENT CONTROL BEST MANAGEMENT PRACTICES, WHICH INTERFERE WITH THE WORK, SHALL BE RELOCATED OR MODIFIED AS THE WORK PROGRESSES, AS RECOMMENDED BY THE ENGINEER OF WORK AND AS APPROVED BY THE CITY ENGINEER AND MITIGATION MONITOR.
- 4. ALL REMOVABLE PROTECTION BEST MANAGEMENT PRACTICES SHOWN SHALL BE IN PLACE AT THE END OF EACH WORKING DAY WHEN THE 5-DAY RAIN PROBABILITY FORECAST EXCEEDS 40 PERCENT. AFTER EACH RAINSTORM EXCEEDING 1/4 INCH IN A 12-HOUR PERIOD, SILT AND DEBRIS SHALL BE REMOVED FROM CHECK DAMS AND DESILTING BASINS AND BASINS SHALL BE PUMPED DRY AS DEEMED NECESSARY BY THE CITY ENGINEER AND MITIGATION MONITOR
- 5. EFFECTIVE PLANTING SHALL BE INSTALLED, FULLY GERMINATED, AND SHALL EFFECTIVELY COVER THE REQUIRED SLOPES PRIOR TO FINAL APPROVAL. THE PLANTING MIX SHALL BE APPROVED. BY THE DIRECTOR OF DEVELOPMENT SERVICES OR DESIGNEE PRIOR TO INSTALLATION. SPRINKLER SYSTEMS ARE REQUIRED ON ALL SLOPES THREE FEET IN VERTICAL HEIGHT OR GREATER. FIVE FEET IN HEIGH7
- 6. A 12 INCH HIGH BY 3 FEET WIDE BERM SHALL BE MAINTAINED ALONG THE TOP OF THE SLOPE OF THOSE FILLS ON WHICH GRADING IS NOT IN PROGRESS. CONCENTRATED WATER SHALL NOT BE CARRIED CLOSER THAN 10 FEET FROM THE TOP OF SLOPES.
- 7. SILT BASINS. TRAPS. OR SANDBAGS SHALL BE PROVIDED AT EVERY STORM DRAIN INLET TO PREVENT SEDIMENT FROM ENTERING THE STORM DRAIN SYSTEM.
- 8. FOR INLETS LOCATED AT SUMPS ADJACENT TO TOP OF SLOPE, THE CONTRACTOR SHALL INSURE THAT WATER DRAINING TO THE SUMPS IS DIRECTED INTO THE INLET. AND THAT A MINIMUM OF 1.00' FREEBOARD EXISTS AND IS MAINTAINED ABOVE THE TOP OF INLET. IF FREEBOARD IS NOT PROVIDED BY GRADING SHOWN ON THESE PLANS, THE CONTRACTOR SHALL PROVIDE IT VIA TEMPORARY MEASURES. I.E. SANDBAGS OR DIKES.
- 9. THE GRADING CONTRACTOR SHALL BE RESPONSIBLE FOR CLEANUP OF SILT AND MUD ON ADJACENT STREETS DUE TO CONSTRUCTION ACTIVITY.
- 10. THE CONTRACTOR SHALL CHECK AND MAINTAIN LINED AND UNLINED DITCHES AFTER EACH RAINFALL 11. THE CONTRACTOR SHALL REMOVE SILT AND DEBRIS AFTER EACH RAINFALL EXCEEDING 1/4" IN A 12-HOUR PERIOD AND WHEN SILT REACHES A DEPTH OF 1.0'
- 12. EQUIPMENT AND WORKERS FOR EMERGENCY WORK SHALL BE MADE AVAILABLE AT ALL TIMES DURING THE RAINY SEASON. ALL NECESSARY MATERIALS SHALL BE STOCKPILED ON SITE AT CONVENIENT LOCATIONS TO FACILITATE RAPID CONSTRUCTION OF TEMPORARY DEVICES WHEN RAIN IS IMMINENT.
- 13. DEVICES SHOWN ON THESE PLANS SHALL NOT BE MOVED OR MODIFIED WITHOUT THE APPROVAL OF THE PUBLIC WORKS INSPECTOR AND MITIGATION MONITOR 14. THE CONTRACTOR SHALL RESTORE ALL EROSION AND SEDIMENT CONTROL BEST MANAGEMENT
- PRACTICES TO WORKING ORDER TO THE SATISFACTION OF THE CITY ENGINEER AND MITIGATION MONITOR AFTER EACH RAINFALL WHICH PRODUCES RUNOFF. 15. THE CONTRACTOR SHALL INSTALL ADDITIONAL EROSION AND SEDIMENT CONTROL MEASURES AS MAY
- BE REQUIRED BY THE CITY ENGINEER OR MITIGATION MONITOR DUE TO INCOMPLETE GRADING OPERATIONS OR UNFORESEEN CIRCUMSTANCE WHICH MAY ARISE
- 16. THE CONTRACTOR SHALL BE RESPONSIBLE AND SHALL TAKE NECESSARY PRECAUTIONS TO PREVENT PUBLIC TRESPASS ONTO AREAS WHERE IMPOUNDED WATERS CREATE A HAZARDOUS CONDITION. 17. ALL EROSION CONTROL MEASURES PROVIDED PER THE APPROVED GRADING PLAN SHALL BE
- INCORPORATED HEREIN. 18. GRADED AREA AROUND THE PROJECT PERIMETER MUST DRAIN AWAY FROM THE FACE OF SLOPES AT
- THE CONCLUSION OF EACH WORKING DAY. 19. IN CASE EMERGENCY WORK IS REQUIRED, CONTACT RICH NORTON AT 949-278-9212.
- 20. THE CONTRACTOR SHALL TAKE THE NECESSARY STEPS TO PROTECT THE PROJECT AND ADJACENT PROPERTY FROM ANY EROSION AND SILTATION THAT MAY RESULT FROM GRADING OPERATIONS BY APPROPRIATE MEANS (GRAVEL BAGS, FIBER ROLLS, TEMPORARY DESILTING BASINS, SILT FENCES, DIKES, SHORING, ETC.) UNTIL SUCH TIME THAT THE TOTAL PROJECT IS COMPLETED AND ACCEPTED FOR MAINTENANCE BY OWNER.

NATIONAL POLLUTANT DISCHARGE ELIMINATION SYSTEM (NPDES) STATEMENT

DEVELOPMENT THIS PROJECT SHALL COMPLY WITH ALL REQUIREMENTS OF STATE WATER RESOURCES CONTROL BOARD (SWRCB) (NPDES GENERAL PERMIT NO. CASOOOOO2. WASTE DISCHARGE REQUIREMENTS FOR DISCHARGES OF STORM WATER RUNOFF ASSOCIATED WITH CONSTRUCTION ACTIVITY. IN ACCORDANCE WITH SAID PERMIT. A STORM WATER POLLUTION PREVENTION PLAN (SWPPP) AND A MONITORING PROGRAM PLAN SHALL BE DEVELOPED AND IMPLEMENTED CONCURRENT WITH THE COMMENCEMENT OF GRADING ACTIVITIES. THE SWPPP SHALL SPECIFY CONSTRUCTION AND STRUCTURAL AND NON-STRUCTURAL POLLUTION PREVENTION MEASURES.

A COMPLETE AND ACCURATE NOTICE-OF-INTENT (NOI) WILL BE FILED WITH THE SWRCB. A COPY OF THE ACKNOWLEDGMENT FROM THE SWRCB THAT A NOI HAS BEEN RECEIVED FOR THIS PROJECT SHALL BE FILED WITH THE CITY OF CHULA VISTA WHEN RECEIVED; FURTHER, A COPY OF THE COMPLETED NOI FROM THE SWRCB SHOWING THE WASTE DISCHARGE IDENTIFICATION NUMBER (WDID) FOR THIS PROJECT SHALL BE FILED WITH THE CITY OF CHULA VISTA WHEN RECEIVED.

IN ADDITION, THE UNDERSIGNED AND SUBSEQUENT OWNER(S) OF ANY PORTION OF THE PROPERTY COVERED BY THIS GRADING PERMIT NO. PG-972 SHALL COMPLY WITH SPECIAL PROVISIONS REGARDING THE REVOCATION OR CANCELLATION OF NPDES GENERAL PERMIT COVERAGE. AS SET FORTH IN SWRCB ORDER NO. CASOOOOO2, AND ANY SUBSEQUENT AMENDMENTS THERETO AND REISSUANCES THEREOF.

OWNER OF LAND

SIGNATURE OF LAND OWNER, CORPORATE OFFICE, GENERAL PARTNER. OR PROPRIETOR

DATE

PRINTED NAME OF ABOVE PERSON

TITLE

PERMIT IDENTIFICATION NUMBER

AS-BUILT

SIGNATURE

AARON PARKER

PRINTED NAME

P.E. No.: 68547

DATE



DESCRIPTION EARTH SWALE DIRECTION OF DRAINAGE

STABILIZED SLOPES WITH SOIL BINDER

STABILIZED CONSTRUCTION ENTRY

SILT FENCE

LEGEND

GRAVEL BAGS (SINGLE ROW)

INLET PROTECTION

WIND EROSION

FIBER ROLL

STORM DRAIN STORM DRAIN CLEANOUT AREA DRAIN

- CONCRETE WASHOUT
- MATERIAL STORAGE AREA
- * SANITARY FACILITIES
- WASTE STORAGE AREA
- * SOIL STOCKPILE
- , LANDSCAPE STOCKPILE
- * EROSION CONTROL STOCKPILE
- MATERIAL STOCKPILL
- * FUELING AREA
- * VEHICLE MAINTENANCE
- VEHICLE PARKING
- EQUIPMENT STORAGE
- HAZARDOUS MATERIAL STORAGE
- * CLEANUP MATERIALS
- CONSTRUCTION TRAILER

NOTICE

RE-DISTURBED FOR AT LEAST 14 DAYS.

AREAS OF CONSTRUCTION


SEDIMENT AND POLLUTION TRANSPORT ARE:

- PRESERVATION OF EXIST. VEGETATION (EC-2)
- HYDRAULIC MULCH - HYDROSEEDING
- SOIL BINDERS
- STRAW MULCH - GEOTEXTILES AND MATS
- WOOD MULCH
- COMPOST BLANKETS

LANDSCAPE NOTES


- DEVELOPMENT SERVICES.
- PARKS SUPERVISOR. (619) 397-6145. ALL SLOPES THREE FEET IN VERTICAL HEIGHT OR GREATER.

MY REGISTRATION EXPIRES: 9-30-23 DISCIPLINE: CIVIL REFERENCE DRAWINGS REVISIONS By | Date | App'd | REVISIONS

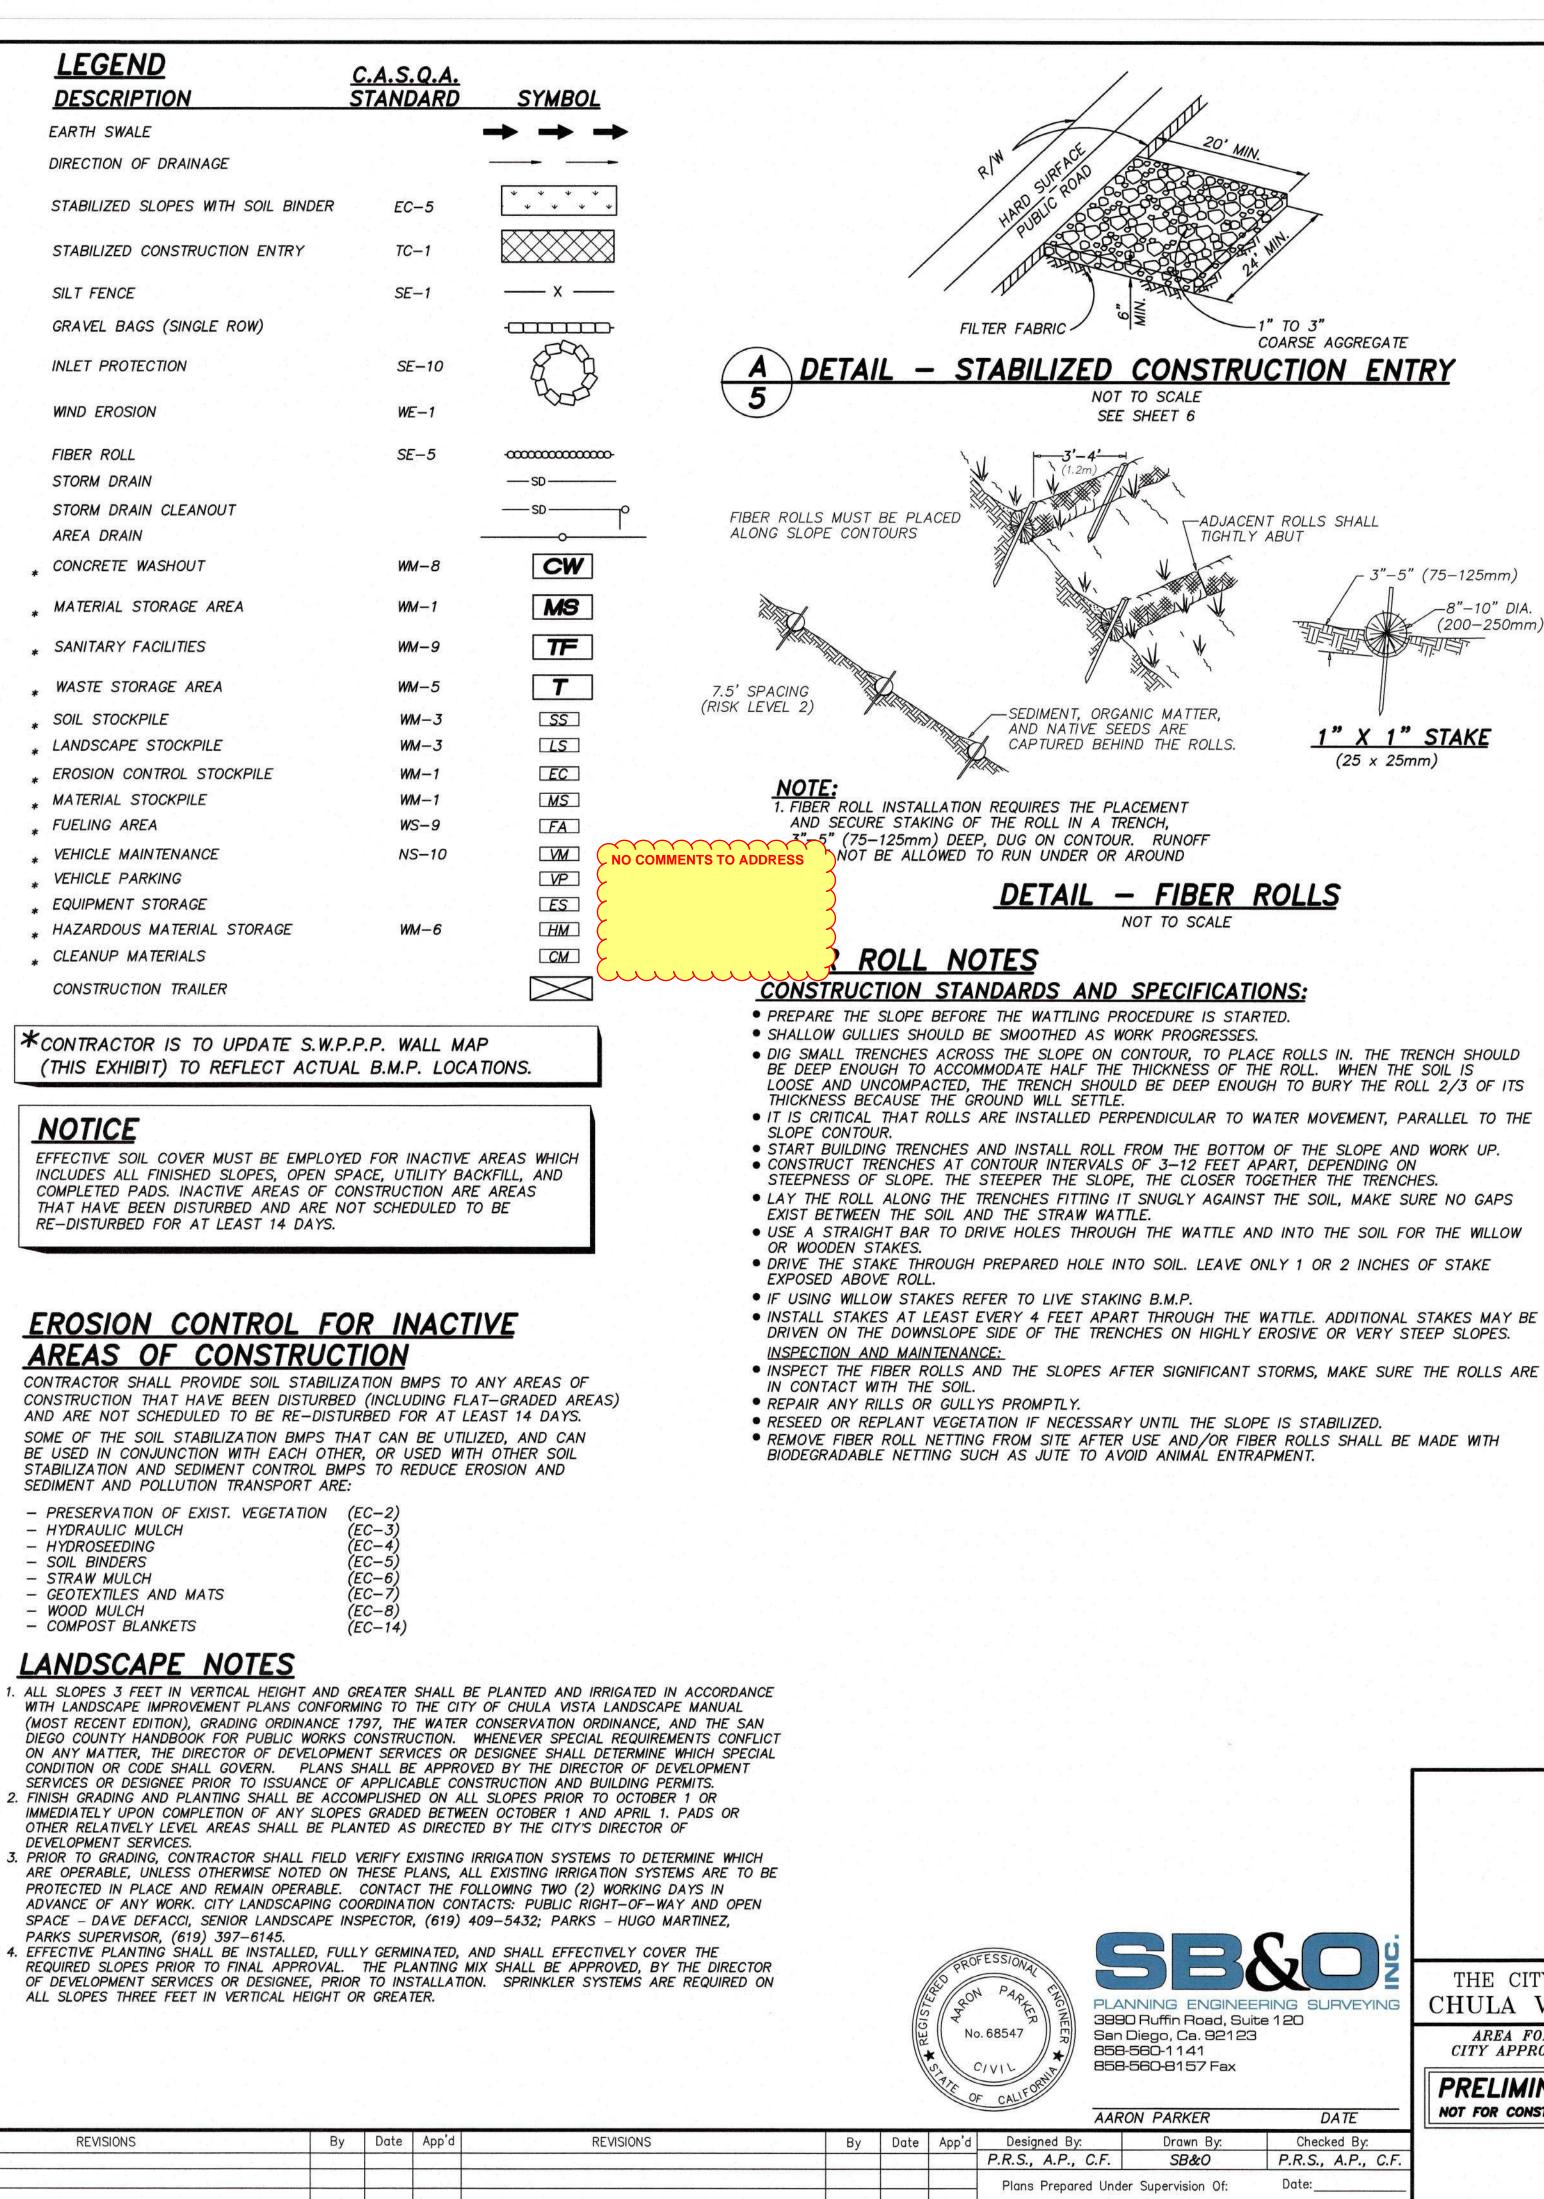

AARON PARKER

R.C.E. No. 68547

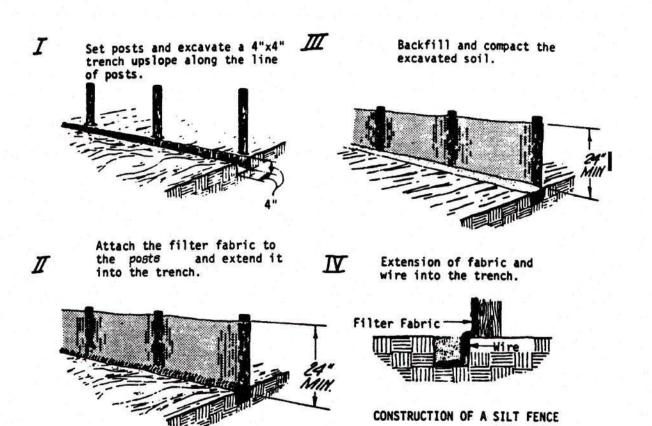

SILT FENCE NOTES:

- 1. POSTS FOR SILT FENCES SHALL BE EITHER 4-INCH-DIAMETER WOOD OR EQUIVALENT WITH A MINIMUM LENGTH OF 5 FEET. POSTS SHALL BE SPACED A MAXIMUM OF 10 FEET APART AND DRIVEN SECURELY INTO THE GROUND (MINIMUM OF 12 INCHES). 2" DIA. WOOD OR EQUIVALENT MAY BE USED PROVIDED POST SPACING DOES NOT EXCEED 4'.
- 2. A TRENCH SHALL BE EXCAVATED APPROXIMATELY 4 INCHES WIDE AND 4 INCHES DEEP ALONG THE LINE OF POSTS AND UPSLOPE FROM THE BARRIER.
- 3. THE FILTER FABRIC SHALL BE STAPLED OR WIRED TO THE POST. AND 8 INCHES OF THE FABRIC SHALL EXTEND INTO THE TRENCH. THE FABRIC SHALL NOT EXTEND MORE THAN 36 INCHES ABOVE THE ORIGINAL GROUND SURFACE.
- FILTER FABRIC SHALL NOT BE STAPLED TO EXISTING TREES. 4. THE TRENCH SHALL BE BACKFILLED AND THE SOIL COMPACTED OVER THE TOE OF THE FILTER FABRIC.

DETAIL -	TYPICAL	SILT	FENCE
	NOT TO SCALL	E	

HYDROSEED PROCEDURES

- 4.4-1 SEED MIXES SHALL BE SPECIFIED BY THE PURE LIVE SEED OF EACH SPECIES. 4.4-2 FIBER MULCH SHALL BE APPLIED AT A MINIMUM RATE OF 2,000 POUNDS PER ACRE EXCEPT WHEN USED IN CONJUNCTION WITH STRAW MULCH, WHEN IT SHALL BE APPLIED AT A MINIMUM RATE OF 400 POUNDS PER ACRE
- 4.4-3 A WETTING AGENT CONSISTING OF 95 PERCENT ALKYL POLYETHYLENE GLYCOL ETHER SHALL BE APPLIED AS PER "MANUFACTURERS" RECOMMENDATIONS. 4.4-4 EQUIPMENT USED FOR THE APPLICATION OF SLURRY SHALL HAVE A BUILT-IN
- AGITATION SYSTEM TO SUSPEND AND HOMOGENEOUSLY MIX THE SLURRY. THE SLURRY MIX SHALL BE DYED GREEN. THE EQUIPMENT MUST HAVE A PUMP CAPABLE OF APPLYING SLURRY UNIFORMLY.

INTERIM BINDER NOTE

GRADED, DISTURB OR ERODED AREAS TO BE TREATED WITH A NON-IRRIGATED HYDROSEED MIX SHALL RECEIVE AND INTERIM BINDER/TACKIFIER AS NEEDED BETWEEN APRIL 2ND AND AUGUST 31ST FOR DUST-ÉROSION CONTROL WITH SUBSEQUENT APPLICATION OF HYDROSEED MIX DURING RAINY SEASON BETWEEN OCTOBER 1ST AND APRIL 1ST.

HYDROSEED NOTES

HYDROSEED COMPONENTS

140 LBS M-BINDER TRIPLE 15

2000 LBS CELLULOSE FIBRE MULCH

- 1. ALL SLOPES 3 FEET IN VERTICAL HEIGHT OR GREATER AND PADS STEEPER THAN 2% SHALL BE HYDROSEEDED WITH THE FOLLOWING IRRIGATED SEED MIX. MULCH AND BINDING AGENT: POUNDS/ACRE SPECIES: BROMUS MOLLIS FESTUCA MEGALURA


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200 LBS FERTILIZER NOTE: PRIOR TO HYDROSEEDING, MIX SHALL BE REVIEWED AND APPROVED BY THE DIRECTOR OF BUILDING AND PARK CONSTRUCTION AND THE ENVIRONMENTAL REVIEW COORDINATOR.

- 2. IRRIGATION METHODS ARE REQUIRED FOR ALL AREAS HYDROSEEDED BETWEEN MARCH FIRST AND NOVEMBER FIRST AS NEEDED. IMMEDIATELY FOLLOWING HYDROSEED APPLICATION. AND FOR A PERIOD OF TIME OF NO LESS THAN 90 DAYS. ADEQUATE SOIL MOISTURE SHALL BE MAINTAINED IN THE UPPER 1/2 INCH OF SOIL TO ASSURE MAXIMUM RATES OF SEED GERMINATION AND PLANT ESTABLISHMENT. IRRIGATION SHALL BE MAINTAINED BEYOND THE 90 DAYS WHEN DEEMED NECESSARY BY THE CITY OF CHULA VISTA PUBLIC WORKS OPERATIONS, OPEN SPACE SECTION.
- 3. IRRIGATION SYSTEMS ARE NOT REQUIRED FOR AREAS HYDROSEEDED ON (OR WITHIN ONE WEEK OF) NOVEMBER FIRST; HOWEVER, TEMPORARY WATERING (BY HAND OR TRUCK) IS REQUIRED UNTIL PLANTING IS ESTABLISHED IF RAINFALL IS NOT PRESENT. 4. NON-IRRIGATED HYDROSEED MIX IS ACCEPTABLE (SEE INTERIM BINDER NOTE).

		EROSION CONTROL TITLE SH	EET FOR	
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5	DEVELO	PMENT SERVICES DEPARTMENT	ACCELA NO.: XXXX	
	DEVELO	I MENI SERVICES DELARIMENT	PROJECT NO.:	77222.20
HE CITY OF	Approved:	TOTAL SHEETS: 6		
ULA VISTA Area for	Ву:	Principal Civil Engineer	XXXX —	<i>XXXX</i>
TY APPROVAL	Submitted:	NAD83 COORDINATES		
ELIMINARY	Ву:		XXXX —	XXXX
FOR CONSTRUCTION	Planning:	Landscape:	LAMBERT COO	DRDINA TES
		AS BUILT	DRAWING NO.	
	CONTRACTOR:	DATE COMPLETED:	XXXXX.XXX	G005

-8"-10" DIA

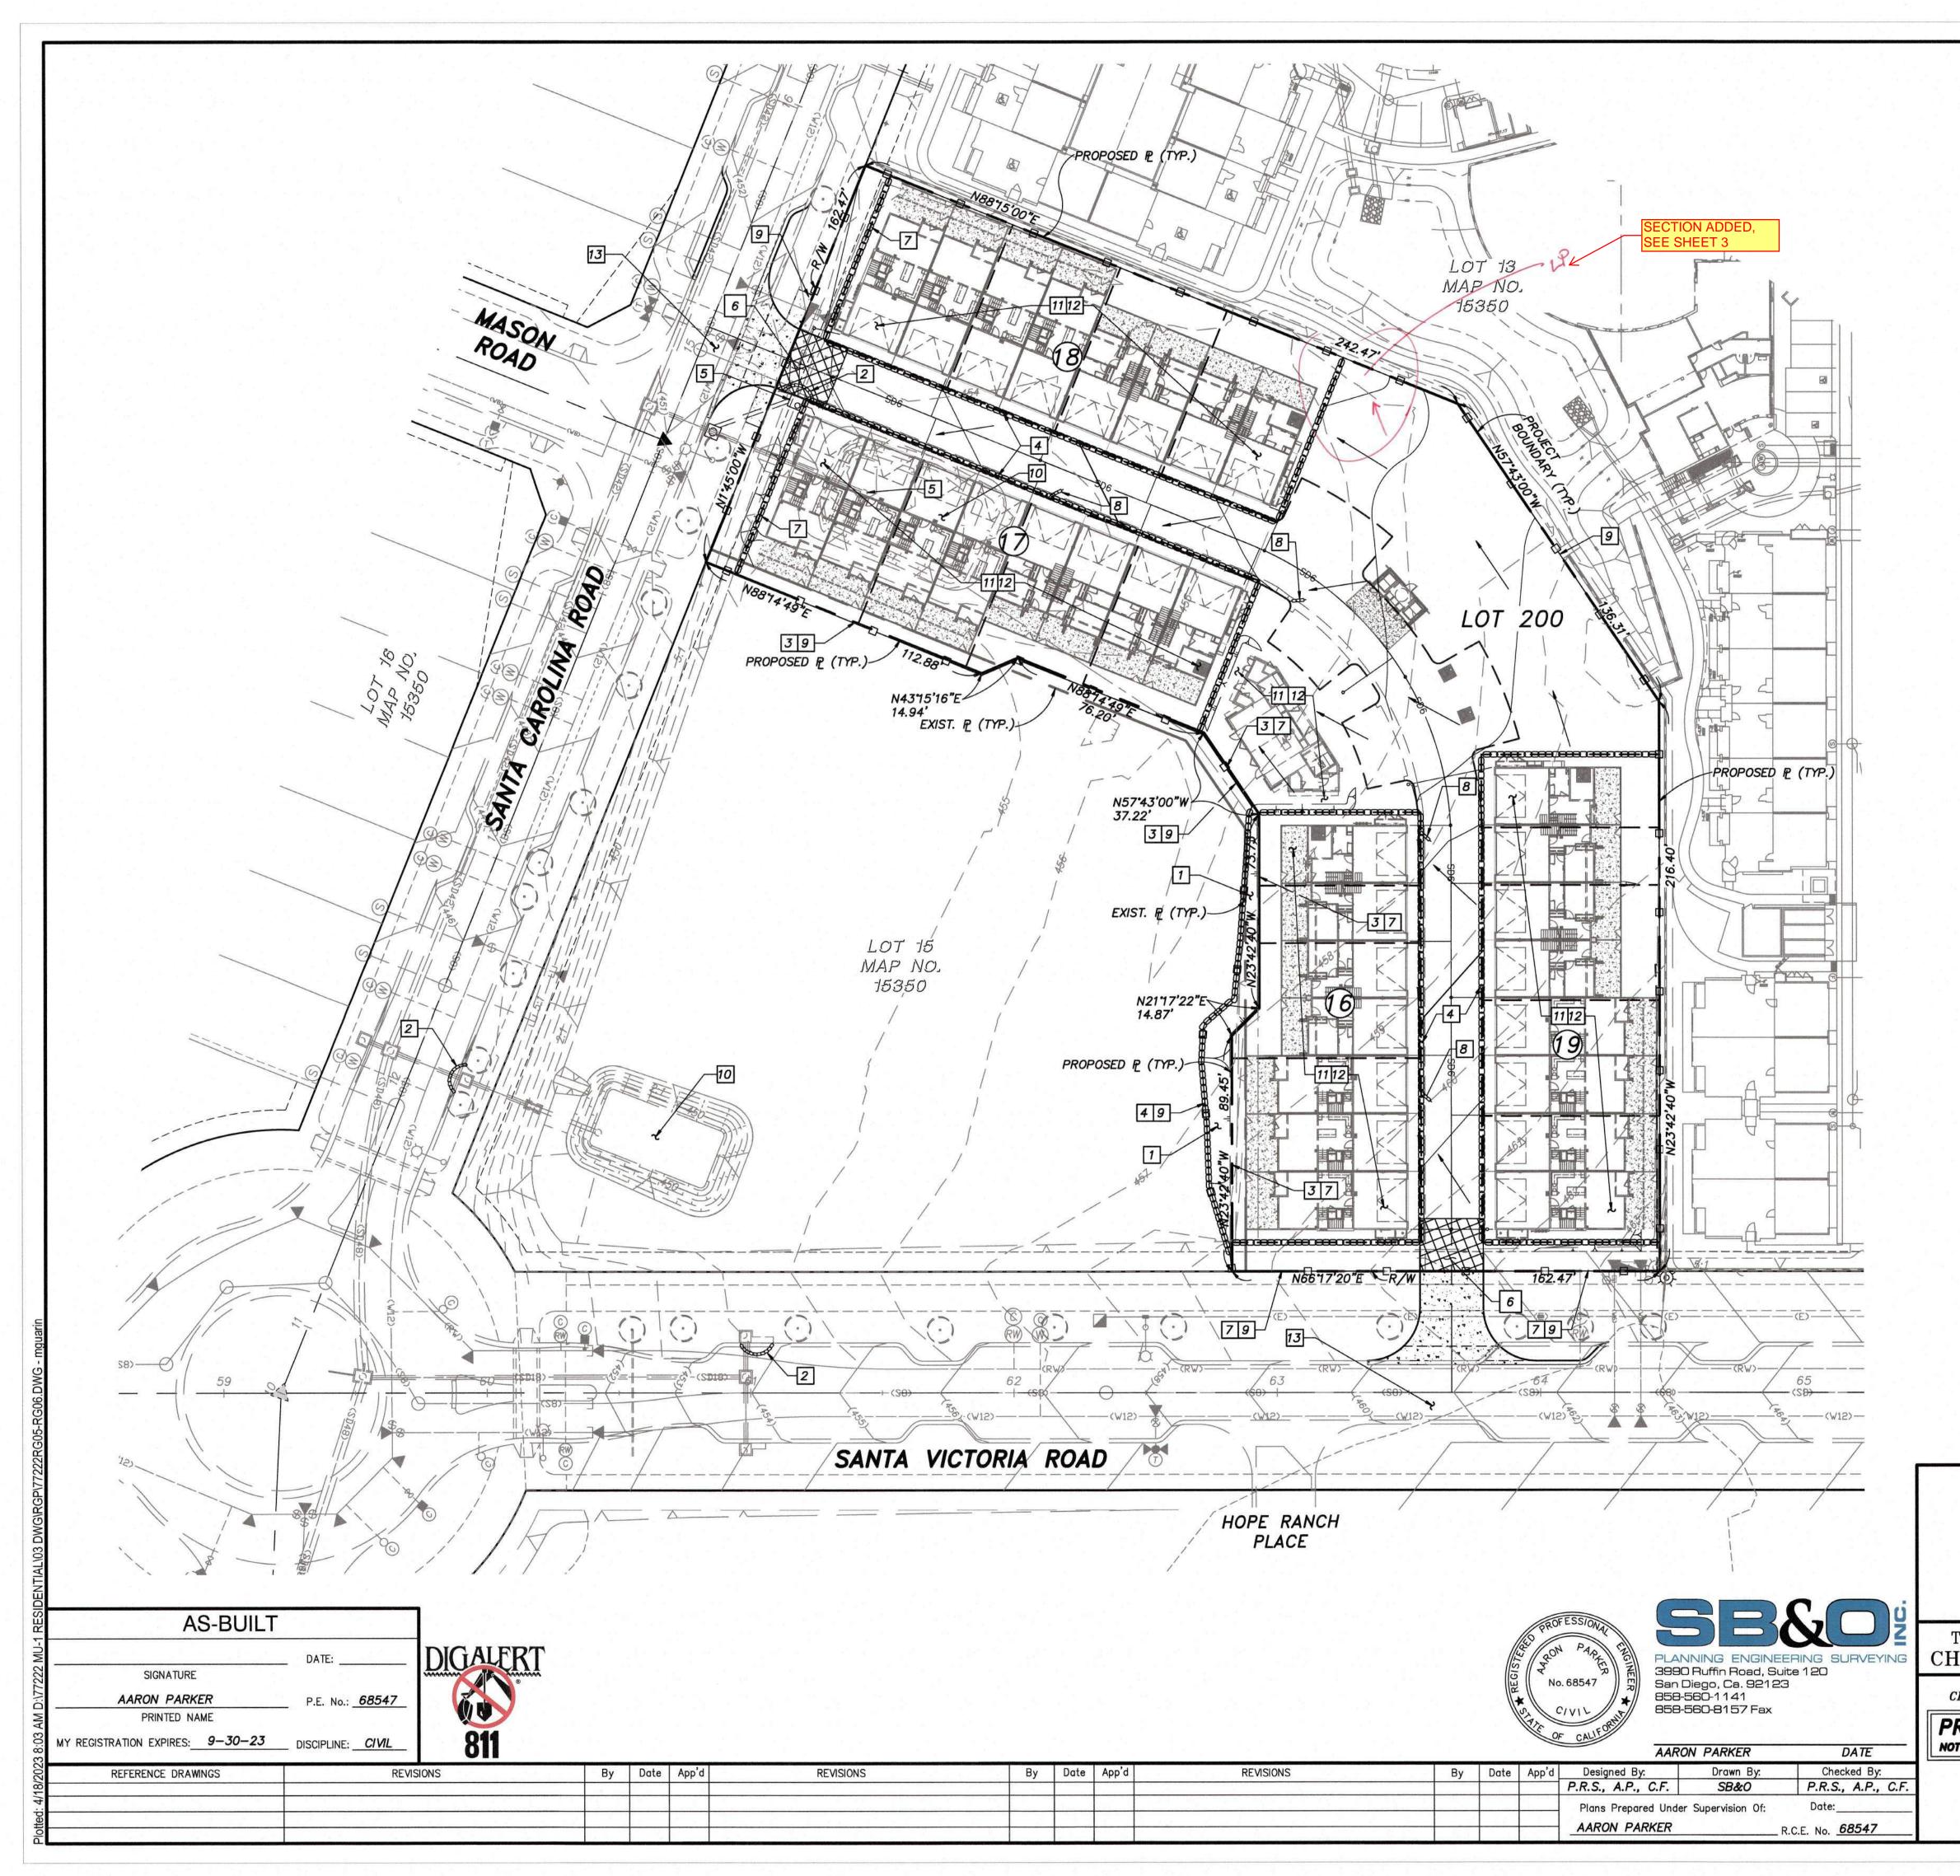

	CC	DNSTRUCTION NOTES	
а [*]	- 10		CASQA STANDARD
	1	STABILIZE ALL SLOPES GREATER THAN 3' IN HEIGHT.	EC-4
	2	PROVIDE INLET PROTECTION (TYP.).	SE-10
	3	A BERM SHALL BE MAINTAINED ALONG THE TOP OF THE SLOPE OF THOSE FILLS ON WHICH GRADING IS NOT IN PROCESS. CONCENTRATED WATER SHALL BE CARRIED NOT CLOSER THAN 10 FEET FROM THE TOP OF SLOPES SEE A	
	4	INSTALL GRAVEL BAGS OR FIBER ROLLS.	SE-5, SE-6
	5	DISCHARGE LOCATION.	
	6	INSTALL STABILIZED CONSTRUCTION ENTRY.	TC-1
	7	MAINTAIN DRAINAGE AWAY FROM TOP OF SLOPES.	SE-8
	8	SINGLE ROW GRAVEL BAGS. DO NOT ENCROACH	
	9	INSTALL SILT FENCE AT TOE OF SLOPES/LIMITS OF WORK	SE-1
	10	EXISTING DESILT BASIN PER DWG. NO. 14024-11. PROTECT IN PLACE.	
	11	PAD STABILIZATION.	EC-3 THROUGH EC-8
	12	WIND EROSION.	WE-1
	13	STREET SWEEPING.	SC-7

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	DEVELOPM	IENT S	ERVICES I	DEPARTMENT	ACCELA NO.: PROJECT NO.:	
CITY OF	Approved:				. TOTAL SHEE	TS: 6
LA VISTA EA FOR APPROVAL	By: Principal Civil Engineer Submitted:				XXXX – XXXX NAD83 COORDINATES	
IMINARY	Ву:					XXXX
R CONSTRUCTION	Planning:	Lo	indscape:		LAMBERT COO	ORDINA TES
		AS	BUILT		DRAWING NO.	
	CONTRACTOR:			DATE COMPLETED:	- xxxxx.xxx	G006