# Trash Enclosure Building

# OTAY RANCH VILLAGE 8

Chula Vista, CA

## CODE COMPLIANCE

APPLICABLE CODES:

 2022 CALIFORNIA BUILDING CODE 2022 CALIFORNIA PLUMBING CODE

**OCCUPANCY & USE:** 

TYPE OF CONSTRUCTION

FIRE SPRINKLERS:

FIRE SEPARATION DISTANCE:

10' OR GREATER ON ALL SIDES

**HEIGHT & STORIES:** 

11'-11" (40'-0" ALLOWED) 1 STORY (1 STORY ALLOWED)

BUILDING AREA:

200 s.f. (5,500 ALLOWED)

PRC JOB NUMBER


NUMBER OF BUILDING MODS:

## GENERAL NOTES

- THE STRUCTURAL DESIGN DETAILS HEREIN ARE SPECIFIC TO THE BUILDING SIZE AND MODULE CONFIGURATION SHOWN ON THE FLOOR PLAN OF THESE DRAWINGS.
- LOCATION OF THIS BUILDING SHALL MEET REQUIRED PROPERTY CODE SETBACKS PER LOCAL JURISDICTION.
- ACCESSIBILITY TO THIS STRUCTURE SHALL BE IN CONFORMANCE WITH LOCAL CODE INCLUDING ALL PATHWAYS, RAMPS AND PATHS OF TRAVEL FROM PARKING TO THE BUILDING. - SOIL BEARING REQUIREMENT IS 1500 PSF, SUB GRADE COMPACTION AT 90%. SITE BUILDING
- PAD PREPARATION BY OTHERS. - ALL DIMENSIONS HEREIN ARE NOMINAL AND SUBJECT TO CHANGE AS LONG AS THEY DO NOT
- VIOLATE CODE. - THIS BUILDING IS NOT DESIGNED TO BE LOCATED IN A WUI (WILDLAND URBAN INTERFACE) FIRE AREA.
- ALL WORK REQUIRED TO BE COMPLETED ON SITE SUBJECT TO LOCAL REVIEW, APPROVAL AND INSPECTION BY LOCAL AHJ. OWNER / GENERAL CONTRACTOR RESPONSIBLE FOR ALL
- a. SITE CONCRETE FOUNDATION (IF APPLICABLE)
- b. COMPACTED BUILDING PAD
- c. UNDER SLAB UTILITY PIPING (SEE NOTE)
- d. SEWER (DWV) CONNECTION
- e. CONCRETE WALKWAY COMPLIANT WITH PATH OF TRAVEL FROM ACCESSIBLE PARKING NOTE: PUBLIC RESTROOM COMPANY WILL ONLY FURNISH AND INSTALL UNDERGROUND UTILITIES (UNDER SLAB) EXTENDING 6 FEET (MAX.) BEYOND THE BUILDING LINE. MIN. OF 24" -

MAX. OF 36" BELOW GRADE - U.N.O. ALL UTILITY BOXES TO BE PROVIDED BY OTHERS. - SITE INSTALLATION DETAILS ARE NOTED ON SHEETS S-1 FOR STRUCTURAL CONNECTIONS, A-2 FOR WEATHERIZATION FINISH, P-1 FOR PLUMBING CONNECTIONS & E-1 FOR ELECTRICAL

- CONNECTIONS IN ACCORDANCE w/ SECTION 4368. a. SERVICE HOOKUPS (PLUMBING CONNECTIONS).
- b. PATCH AND FINISH AT CRANE PICK LOCATIONS AS NEEDED
- c. INSTALL AND CONNECT FLOOR DRAIN.
- d. PATCH CONCRETE @ FLOOR DRAIN

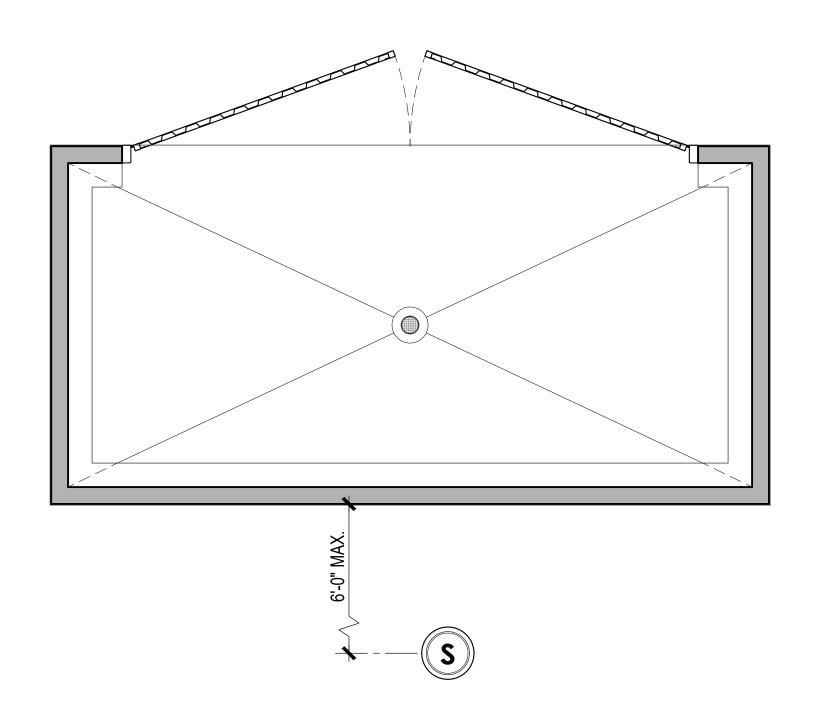

## Utility Location

NOTE: FINAL LOCATIONS OF P.O.C. TO BE COORDINATED WITH P.R.C. AND TO BE CONFIRMED ON SITE. UTILITY BOXES TO BE PROVIDED BY OTHERS



## PROJECT INFORMATION

SITE ADDRESS: OTAY RANCH VILLAGE 8 - La Media North & Main Street West, Chula Vista, CA 91911

PROJECT OWNER:

EMAIL:

**HOMEFED CORPORATION** 1903 Wright Place #220 Carlsbad, CA 92008 CONTACT: Don Ross POSITION: Project Manager PHONE: (760) 219-1159

dross@hfc-ca.com

kari@trib-la.com

CONSULTANT - LANDSCAPE ARCHITECT: TRIBUTARY LA, INC. 2725 Jefferson Street - Suite 14 Carlsbad, CA 92008 CONTACT: Kari Kiehnau

PHONE: (608) 513-2903

POSITION: Architect

STRUCTURAL ENGINEER: **R & S TAVARES ASSOCIATES** 11590 W. Bernardo Court, Suite 100

San Diego, CA 92127 CONTACT: Mariana Cardoso POSITION: Controller PHONE: (858) 444 3344 mariana@rstavares.com DESIGNER / DEALER: PUBLIC RESTROOM COMPANY 2587 Business Parkway

Minden, NV 89423 CONTACT: Chad Kaufman (888) 888-2060 PHONE: (888) 888-1448

### chad@publicrestroomcompany.com

## DRAWING INDEX

SHI	EETS	PM PLAN REVIEW - 03/14/2023	PRC PLAN REVIEW - 03/20/2023	STRUCTURAL REVIEW - 03/22/2023	CONSTRUCTION DOCUMENTS - 05/23/2023		
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A-1	FLOOR PLAN, EXTERIOR ELEVATIONS & SCHEDULES	•	•	•	•		
A-2	CAP BEAM & ROOF FRAMING PLANS, BUILDING SECTIONS	•	•	•	•		
P-1	PLUMBING PLANS, SCHEDULES & DETAILS	•	•				
				1			

## DESIGN LOADS

		STUKAL D	ESIGN CRITERIA	
GRAVITY	/LOADS		SEISMIC	
	FLOOR LIVE	100 psf	SEISMIC DESIGN CATEGORY	D
	FLOOR DEAD	100 psf	SITE CLASS	D
	ROOF LIVE	20 psf	IMPORTANCE FACTOR	1.0
	ROOF DEAD	10 psf	RISK CATEGORY	II
	EXTERIOR WALL DEAD	50 psf	MAPPED ACCELERATIONS	
			S <sub>S</sub>	0.771
			$S_1$	0.279
SNOW			SPECTRAL RESPONSE	
	GROUND SNOW, $P_g$	0 psf	S <sub>DS</sub>	0.617
	FLAT-ROOF SNOW, $P_f$	0 psf	S <sub>D1</sub>	0.380
	IMPORTANCE FACTOR, I <sub>s</sub>	1.00	SEISMIC FORCE RESISTING SYSTEM	A7
	EXPOSURE FACTOR, Ce	1.00	DESIGN BASE SHEAR	0.123W
	THERMAL FACTOR, $C_t$	1.00	RESPONSE MODIFICATION FACTOR	5.0
			ANALYSIS PROCEDURE	ASCE7-16
WIND				
	ULTIMATE WIND SPEED, Vult	97 mph		
	EXPOSURE CATEGORY	С	FLOOD	
	RISK CATEGORY	II	BUILDING SHALL NOT BE LOCATED, IN WH	IOI F OR IN
	INTERNAL PRESSURE, Gcpi	+/- 0.18	PART, IN A FLOOD HAZARD AREA AS ESTA	
	MEAN ROOF HEIGHT	15 Ft	BY THE AUTHORITY HAVING JURISDICTION SET ON A FOUNDATION DESIGNED IN ACC	ORDANCE
	BUILDING SHALL NOT BE PLA UPPER HALF OF A HILL OR ES EXCEEDING 15 FEET IN HEIG	SCARPMENT	WITH ASCE/SEI 25. THE FLOOD RESISTAN FOUNDATION SHALL BE DESIGNED BY A F DESIGN PROFESSIONAL AND CONSTRUCT RESIST ALL FLOOD LOADS WITHOUT TRAIL LOADS TO THE MODULAR STRUCTURE.	REGISTEREI FED TO

COMPONENTS & CLADDING WIND LOADS							
	END ZONE	INTERIOR ZONE					
COMPONENT	(psf)	(psf)					
WINDOWS & SIDING	+25.1 / -25.1	+20.4 / -20.4					
DOORS	+25.1 / -25.1	+20.4 / -20.4					
ROOF CLADDING	+55.3 / -55.3	+37.9 / -37.9					
ROOF OVERHANGS	+65.8 / -65.8	+55.3 / -55.3					

**APPROVED** BY RADCO a CA Department of Housing And Community Development approved third party design approval agency DM920272 8/31/2024 APPROVAL NO.

STRUCTURAL ONLY

591-1255



05/24/2023

Description

**CONSTRUCTION DOCUMENTS** 05/23/2023

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E-MAIL:

PUBLIC RESTROOM COMPANY Building Better Places To Go 2587 Business Pkwy, Minden, NV 89423 Ph: 888-888-2060 | Fax: 888-888-1448

PROJECT OWNER: **HOMEFED CORPORATION** 


Carlsbad, CA

PROJECT NAME AND LOCATION: **OTAY RANCH VILLAGE 8** Chula Vista, CA

**TITLE SHEET** 

SHEET TITLE:


PD Job No. 11385B Drawn by: JC / KM Checked by: 05/23/2023 03/02/2023

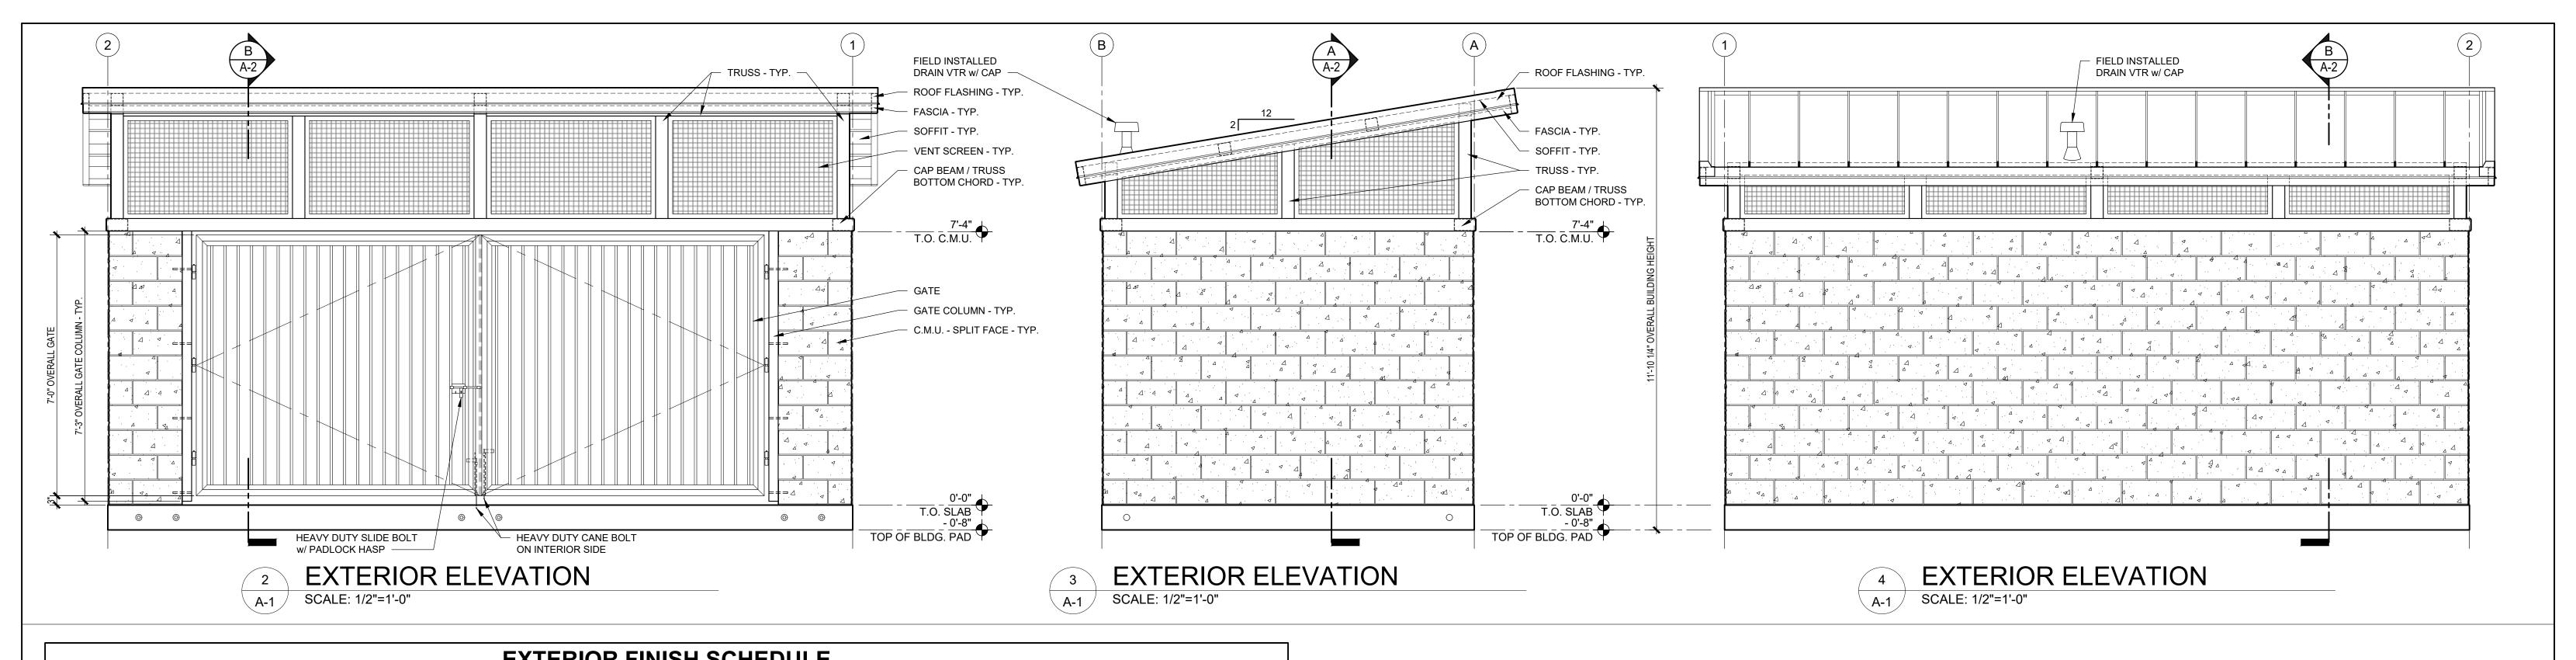

	EXT	<b>ERIOR</b>	FINISH SCHEDULE	
TYPE	DESCRIPTION	FINISH	BRAND / COLOR	NOTES
TO CAP BEAM		1		<u> </u>
C.M.U.	SPLIT FACE	PAINTED	PITTSBURGH PITT-TECH / HALF DOME - PPG 0994-3	2 COATS BLOCK FILLER, 2 COATS FINISH - GLOSS
CAP BEAM	STEEL	PAINTED	PITTSBURGH PITT-TECH / PENCILPOINT - PPG 0994-7	1 COAT PRIMER, 2 COATS FINISH / SEMI-GLOSS
GATE	STEEL FRAME & METAL B-DECK	PAINTED	PITTSBURGH PITT-TECH / PENCILPOINT - PPG 0994-7	1 COAT PRIMER, 2 COATS FINISH / SEMI-GLOSS
ABOVE CAP BEAM				
TRUSSES	STEEL	PAINTED	PITTSBURGH PITT-TECH / PENCILPOINT - PPG 0994-7	1 COAT PRIMER, 2 COATS FINISH / SEMI-GLOSS
VENT CODEENS	FRAME - 1 1/2" x 1 1/2" 1/8" STEEL ANGLE BAR	PAINTED	PITTSBURGH PITT-TECH / PENCILPOINT - PPG 0994-7	1 COAT PRIMER, 2 COATS FINISH / SEMI-GLOSS
VENT SCREENS	WIRE MESH - 1" x 1" x 3/16" STAINLESS STEEL	NATURAL	-	
ROOF				
ROOFING	24 GA. 16" STRIATED STANDING SEAM METAL ROOF PANELS	PREFINISHED	METAL SALES - VERTICAL SEAM / SLATE GRAY (W38)	-
ROOF FLASHINGS	24 GA. METAL	PREFINISHED	METAL SALES - VERTICAL SEAM / MATCH ROOF COLOR	-
FASCIA	STEEL	PAINTED	PITTSBURGH PITT-TECH / PENCILPOINT - PPG 0994-7	1 COAT PRIMER, 2 COATS FINISH / SEMI-GLOSS
COFFITC	UNDERSIDE OF METAL ROOF PANELS	PREFINISHED	METAL SALES / WHITE	-
SOFFITS	STEEL ROOF MEMBERS	PAINTED	PITTSBURGH PITT-TECH / PENCILPOINT - PPG 0994-7	1 COAT PRIMER, 2 COATS FINISH / SEMI-GLOSS

COMPONENT	DESCRIPTION	SPECIFIC MATERIAL LIST	NOTES
SLAB			
PERIMETER FRAMEWORK	STRUCTURAL STEEL	L 6"x6"x5/16"	
REINFORCEMENT	REBAR MAT DESIGN	#4 MIN. GRADE 60 TOP: 8" O.C. EACH WAY - BOT: 16" O.C. EACH WAY	
CONCRETE	8" MAT DESIGN	DESIGN BASIS IS MIN. 2500 PSI	NOTE #1
REBAR CONNECTION TO CONCRETE SLAB	STARTER BARS CONNECTION TO CONCRETE SLAB SHALL BE WITH 2 PART EPOXY w/ 5" MIN. EMBED DEPTH	RED HEAD A7+ EPOXY (OR EQUAL)	USE OF ADHESIVE ANCHORAGE SYSTEM BY PROVISIONS OF CODE REPORT ESR-3903 AND MANUFACTURER RECOMMENDATIONS
WALLS			
FRAMING (EXT.)			
TO CAP BEAM	C.M.U. BLOCK	6 x 8 x 16 CONCRETE BLOCK. GROUT EVERY CELL w/ TYPE 'S' FINE GROUT. REINFORCING: HORIZONTAL - (2) 9 GA WIRES @ 8" O.C. (EVERY COURSE) VERTICAL -#4 REBAR @ 8" O.C. (EVERY CELL)	USE TYPE 'S' FINE GROUT w/ A SLUMP OF 10"-11" FOR A "HIGH LIFT" GROUT POUR GROUT POUR HEIGHT NOT TO EXCEED 12'-8"
CAP BEAM	STEEL	HSS 7 x 4 x 3/16 (A1085 / A 500 Grade B)	
ROOF			
TRUSSES	STEEL	HSS SIZES PER DETAILS (A1085 / A 500 Grade B)	
PURLINS	STEEL	HSS 4 x 4 x 1/8 (A1085 / A 500 Grade B)	
FASCIA	STEEL	HSS 6 x 2 x 1/8 (A1085 / A 500 Grade B)	
ROOFING	METAL	24 GA. STANDING SEAM METAL ROOF PANELS	

C.M.U. SHEAR WALL SCHEDULE						
MARK	BLOCK	REINFORCEMENT	CAP BEAM			
A	6 x 8 x 16 FULLY GROUTED	HORIZONTAL - (2) 9 GA WIRES @ 8" O.C. (EVERY COURSE) VERTICAL - #4 REBAR @ 8" O.C. (EVERY CELL)	HSS 7 x 4 x 3/16			

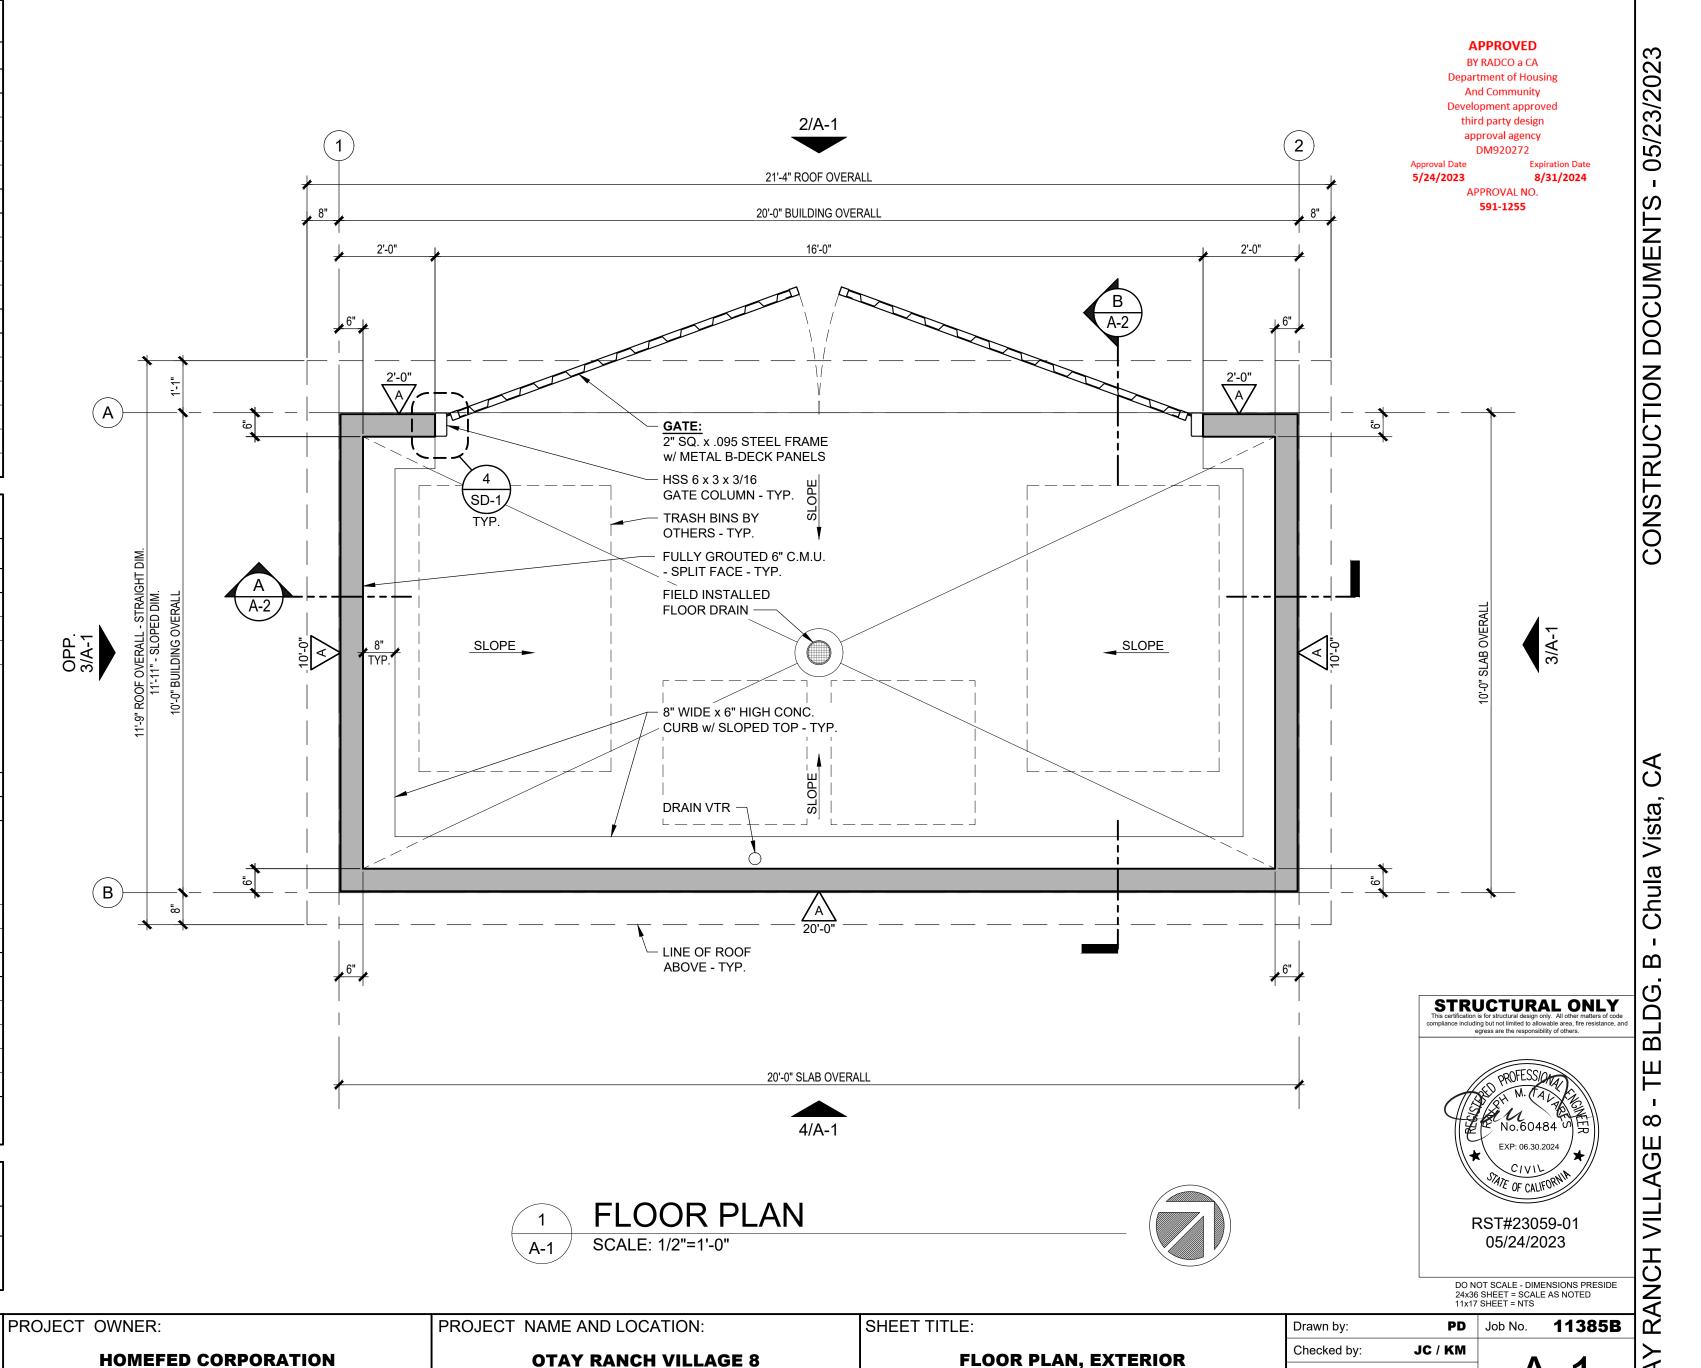

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5	No.	Description	Date
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**CONSTRUCTION DOCUMENTS** 05/23/2023

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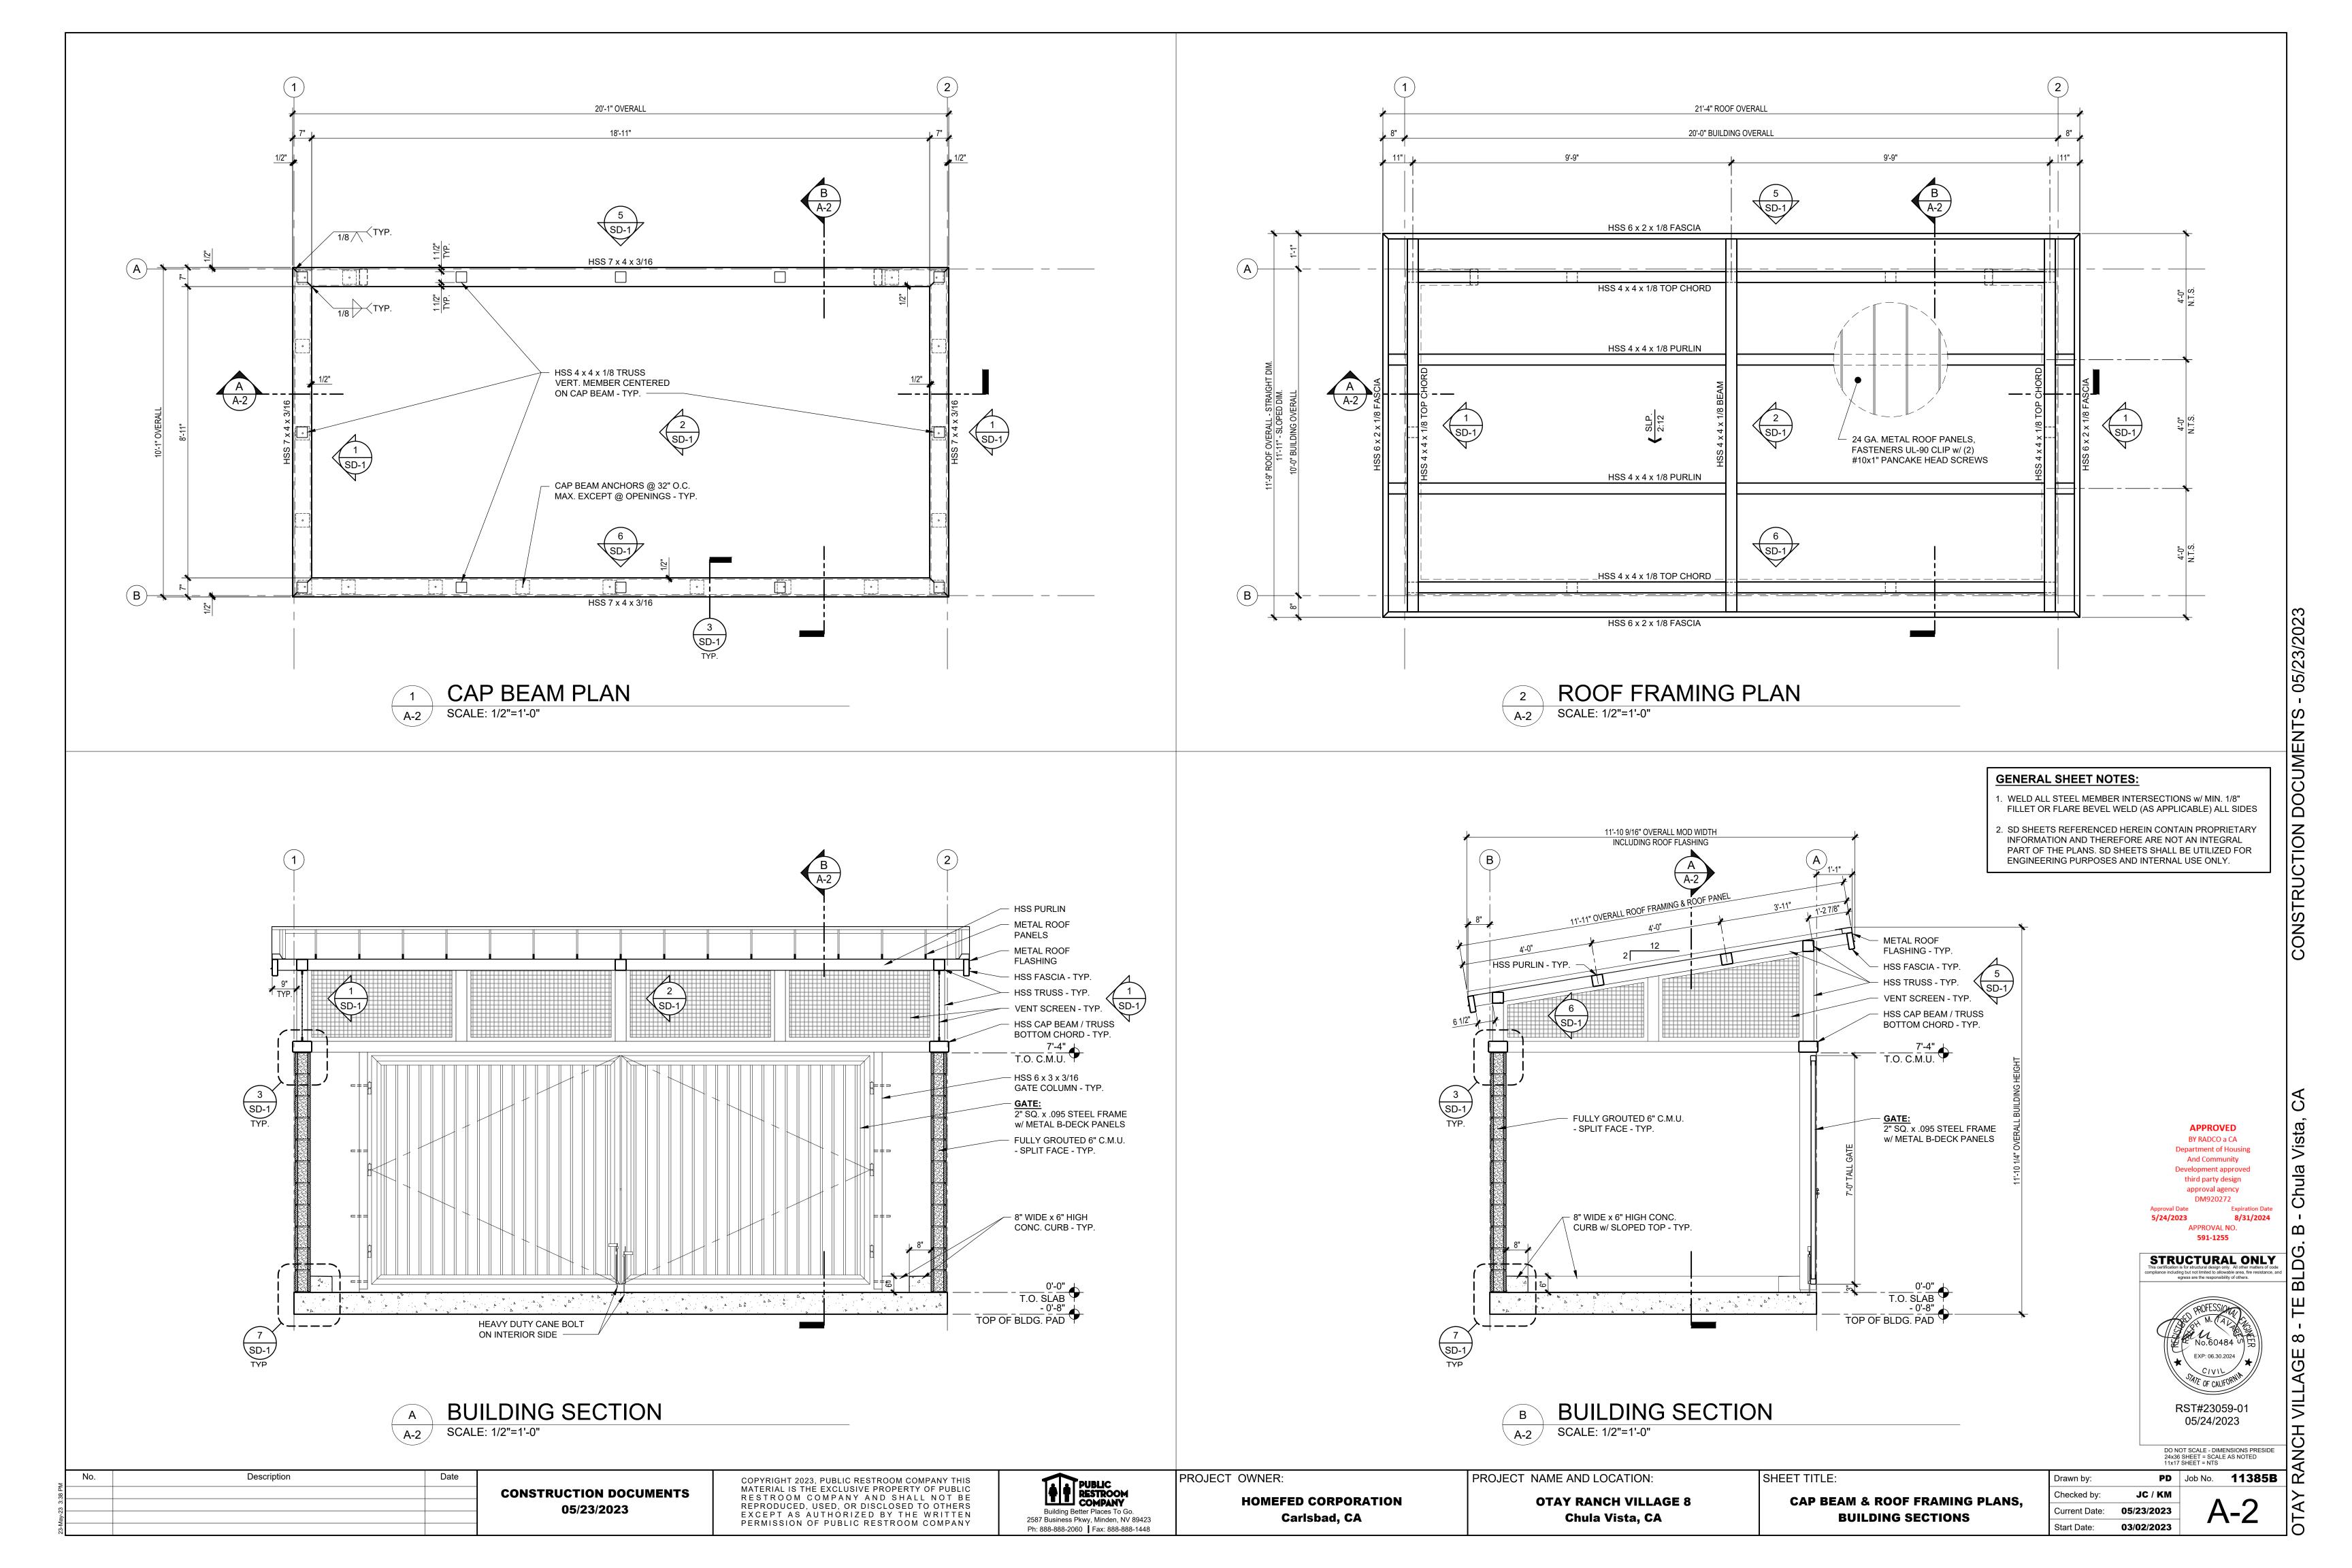
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HOMEFED CORPORATION Carlsbad, CA

**OTAY RANCH VILLAGE 8** Chula Vista, CA


FLOOR PLAN, EXTERIOR **ELEVATIONS & SCHEDULES** 

05/23/2023 Current Date: 03/02/2023



PLUMBING COMPONENTS SCHEDULE QTY. COMPONENT DESCRIPTION PRC# K1703 1 FLOOR DRAIN - 3" ZURN ZN415B-3-NH-Y 1 VENT CAP JAY R SMITH 1748 K1582

PIPE SCHEDULE  TYPE OF SERVICE			Р	IPE	MAT	ERIA	L	
					SCHED. 40 PVC WATER	CAST IRON "NO HUB"	SCHED. 40 PVC DWV	SCHED. 40 ABS DWV
IYPE	OF SERVICE				S	0	S	တ
SANITARY DRAINAGE	BELOW GROUND							<b>/</b>
041117451	ABOVE GROUND							<b>/</b>
SANITARY VENT	BELOW GROUND							<b>/</b>
V = 14 1	ABOVE ROOF					<b>/</b>		

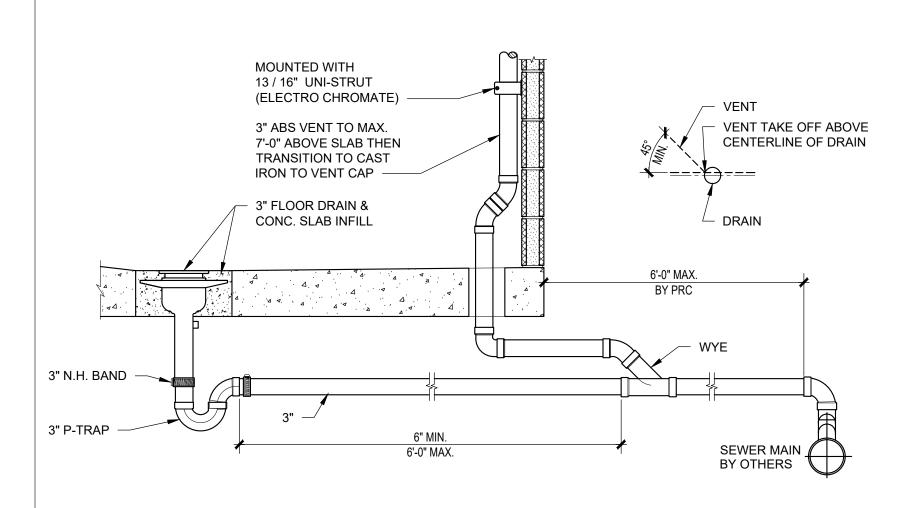

FIELD INSTALLED FLOOR DRAIN DETAIL


**GENERAL NOTES:** 

LEGEND:

---- VENT PIPE

----- WASTE PIPE

- SIZED TO 2022 CALIFORNIA PLUMBING CODE
- CONTINUATION OF WASTE TO MAIN SEWER TO BE DONE ON SITE BY OTHERS.
- SLOPE ALL D.W.V. PIPING 1/4" NOM.DRAIN LINE TO BE SLOPED TO MAIN SEWER LINE.

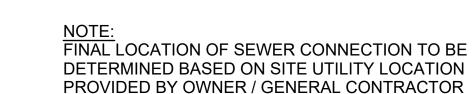

VANDAL PROOF VENT CAP-CAST IRON

- 3" VENT ABOVE GROUND

\_\_ 3" VENT BELOW GROUND

BY OTHERS - UTILITY BOX


MARKED "SEWER" WITHIN 6 FT. OF BUILDING (FINAL LOCATION TBD) WASTE STUB & CLEAN OUT IN BOX

### WASTE & VENT PIPING ISOMETRIC SCALE: NOT TO SCALE

3" FLOOR DRAIN 2 F.U.

#### LEGEND:

---- WASTE & VENT PIPE - BELOW GROUND

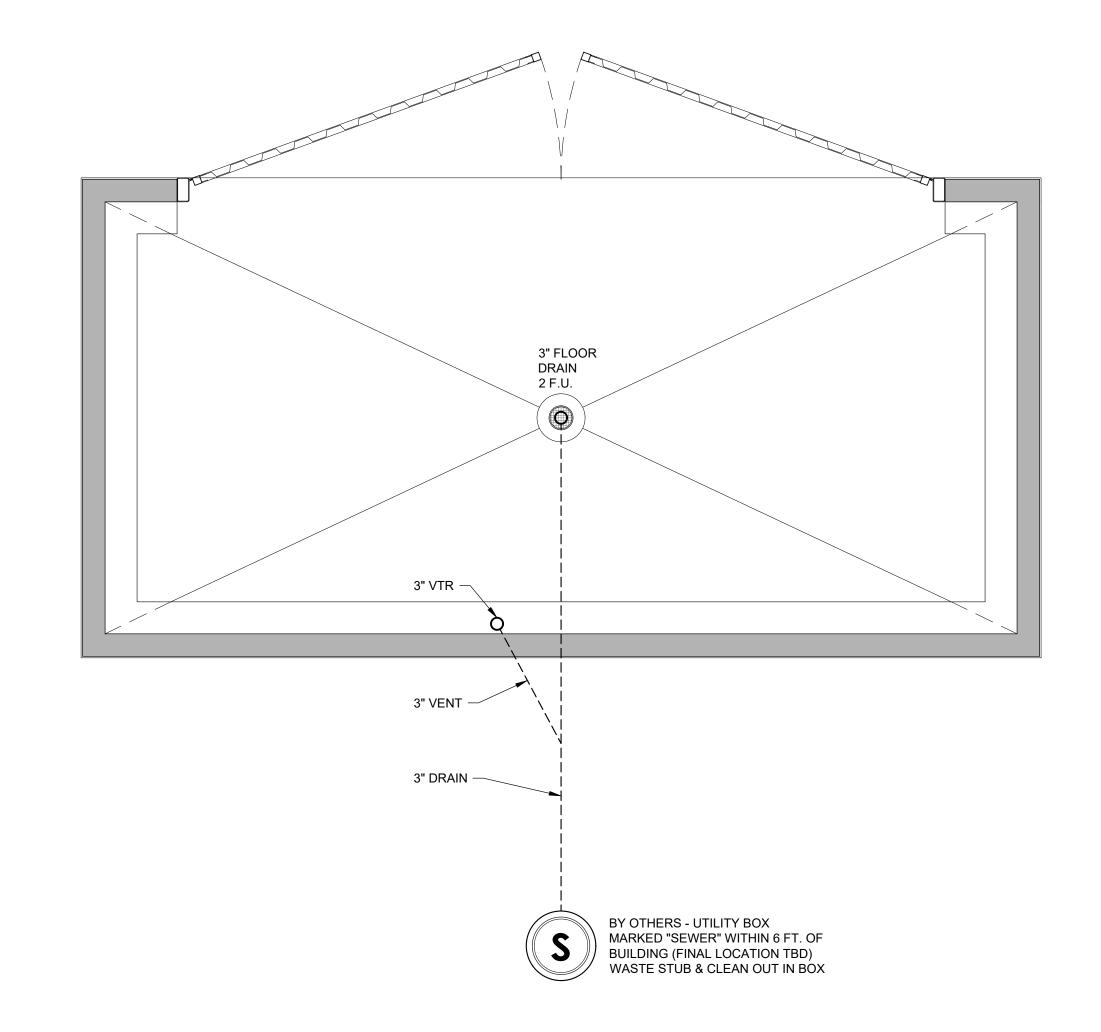

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591-1255

PLUMBING PLAN - WASTE SCALE: 1/2"=1'-0"

DO NOT SCALE - DIMENSIONS PRESIDE 24x36 SHEET = SCALE AS NOTED 11x17 SHEET = NTS

Description

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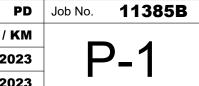
PROJECT OWNER: HOMEFED CORPORATION Carlsbad, CA

PROJECT NAME AND LOCATION:

PLUMBING PLANS, **SCHEDULES & DETAILS** 

SHEET TITLE:

Drawn by: Checked by: 05/23/2023 Current Date: 03/02/2023





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**OTAY RANCH VILLAGE 8** Chula Vista, CA

290 - LBF

330 - LBF



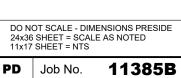

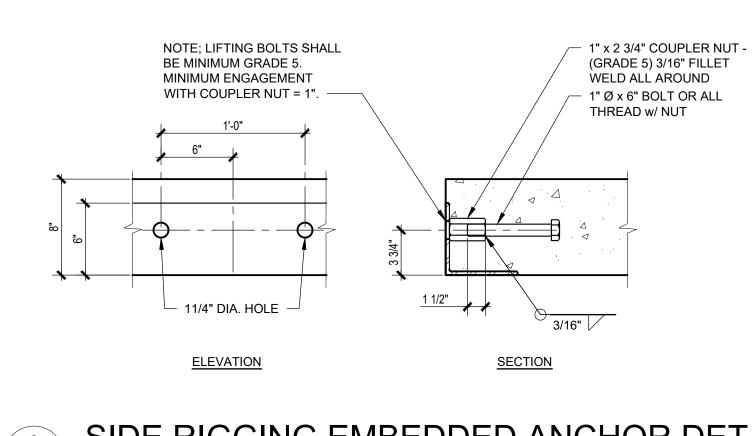CONCRETE SLAB EXTERIOR STEEL FRAME @ CORNER DETAIL

NOTES: (LIGHT WEIGHT CONCRETE)

ALL WELDABLE REINFORCEMENTS TO BE ASTM A706.

ONLY WHERE REQUIRED BY SPECIFIED SLOPES.

CONCRETE STRENGTH BASIS DESIGN IS MIN. 2500 PSI WITH SPECIAL ADDITIVE.

PROVIDE (2) #5 BARS @ 8" O.C. TOP & BOTTOM AT PERIMETER OF EACH SLAB & PROVIDE (3) #5 BARS @ 8" O.C. TOP & BOTTOM AT EACH LIFTING LOCATION.

TOP MAT: ADD TRIMMER BARS NEXT TO BLOCK OUTS IF CLEARANCE TO REGULAR LAYOUT IS GREATER THAN 2". TRIMMER BARS EXTEND 18" PAST OPENING, OR

PROVIDE (2) DIAGONAL 24" LONG #4 REBARS (1 @ TOP MAT & 1 @ BOTTOM MAT) @

SMALL BLOCK OUTS (8" x 8" MAX.) MAY BE ADDED AS REQUIRED FOR SERVICES. ADD DIAGONAL TRIMMER BARS IF CLEARANCE TO REGULAR LAYOUT IS GREATER THAN 2".

10. PROTECT PIPE & FLOOR DRAINS THAT WILL BE ENCASED IN THE CONCRETE BY

12. ALL EXPOSED FACES OF SLAB PERIMETER STEEL ANGLES SHALL RECEIVE

NOTE: SCHEDULE VALUES PER ASD LOAD COMBINATION

**SLAB LOADS SCHEDULE** 

660 - PLF

TERMINATE WITH 90° HOOK AND 8" EXTENSION. CENTER OF TRIMMER BARS TO BLOCK

MINIMUM CONCRETE COVER = 1 1/2" FOR #4 AND #5 BARS.TOP BARS MAY BE LOWER

ALL REBAR TO BE GRADE 60.

OUTS TO BE 2", TYP.

EACH SLAB OPENING.

SPLICES: #4 BARS - 20" LAP

#5 BARS - 24" LAP

PROVIDING AN APPROVED WRAP.

GALVANIZING PAINT COATING.

WALL LINE (GRID) 1 & 2

WALL LINE (GRID) A & B

FLOOR FINISH SCHEDULE:

LIGHT BROOM FINISH - SEALED

MARK LOCATION

 $\langle B \rangle$ 

PLAN VIEW

STEEL ANGLE

- CAP ENDS TYP.

6" x 6" x 5/16"

OVERSIZED CLEARANCE HOLE IN

LARGER THAN NEEDED @ EACH

ANGLE FOR 1" Ø - 8 BOLT 1/8"

COUPLER NUT - 3/16" FILLET


WELD ALL AROUND

SECTION

COUPLER NUT

S-1 SCALE: 1 1/2"=1'-0"

SIDE RIGGING EMBEDDED ANCHOR DET. S-1 SCALE: 1 1/2"=1'-0"

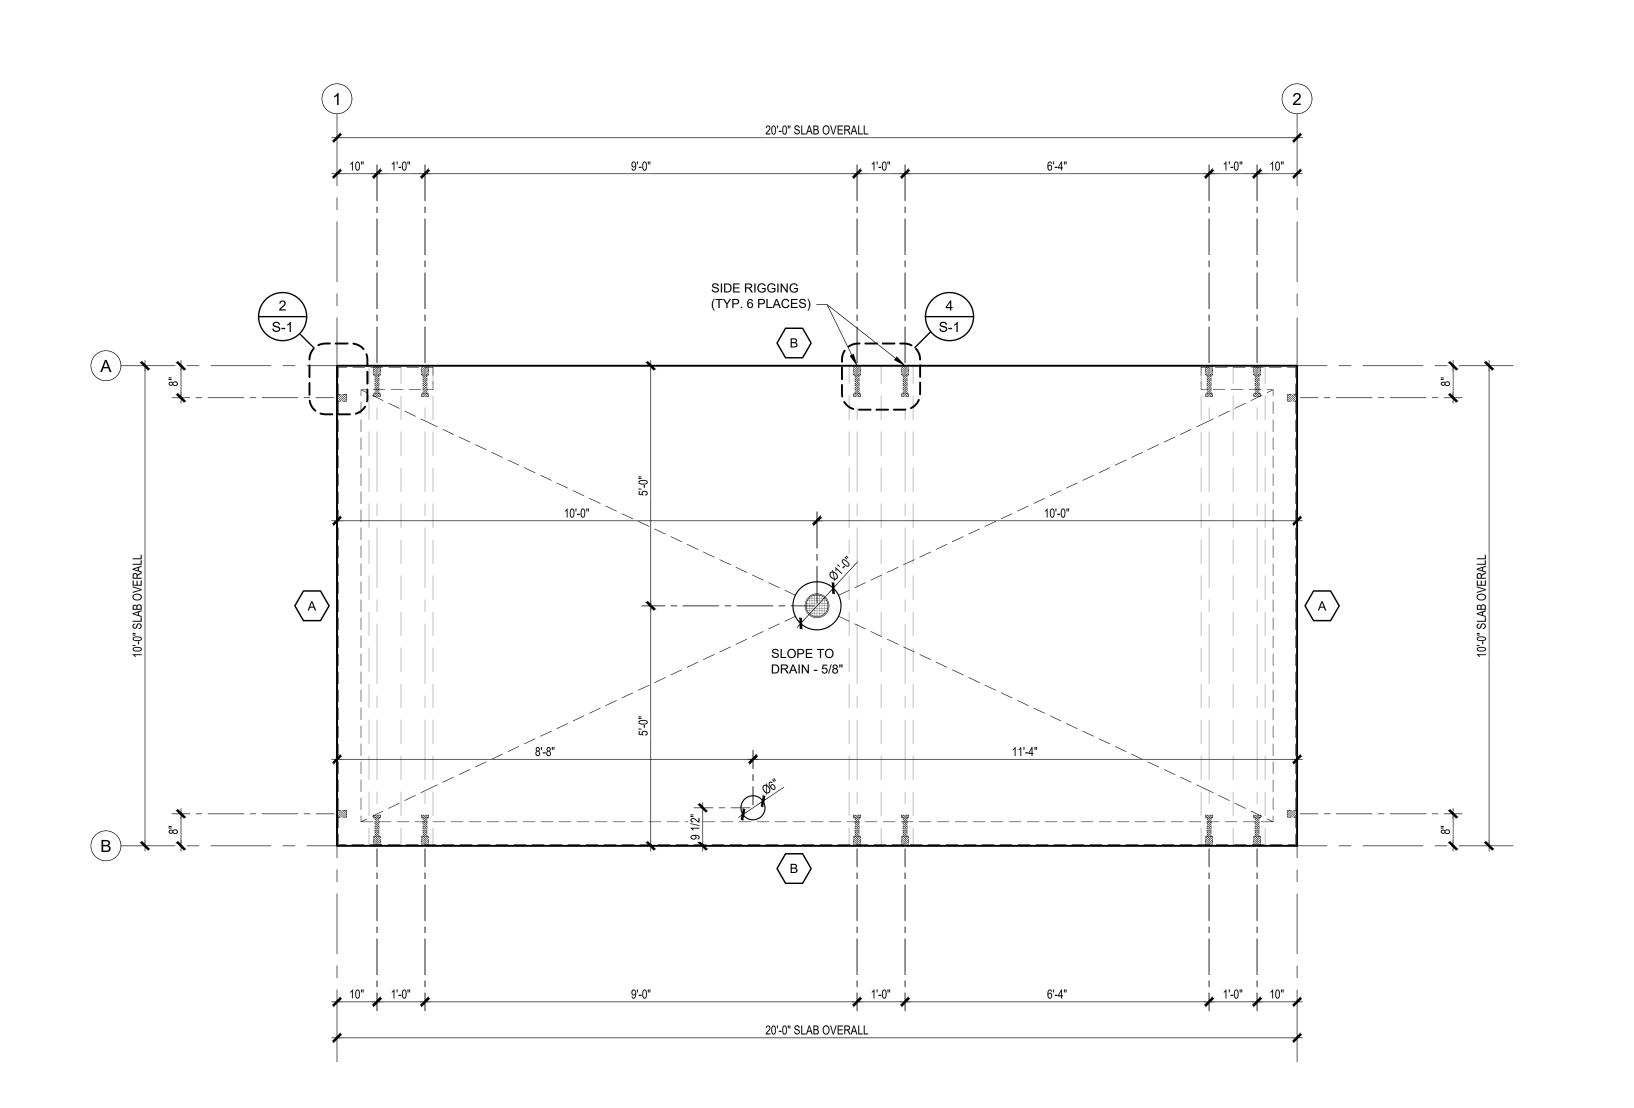

CONCRETE SLAB PLAN S-1 SCALE: 1/2"=1'-0"

PROJECT OWNER:

PROJECT NAME AND LOCATION: **OTAY RANCH VILLAGE 8** Chula Vista, CA

SHEET TITLE:

Drawn by: Checked by: Current Date: 05/23/2023 03/02/2023

PD Job No. 11385B

Description **CONSTRUCTION DOCUMENTS** 05/23/2023

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**HOMEFED CORPORATION** Carlsbad, CA

**CONCRETE SLAB PLAN & DETAILS** 

third party design approval agency DM920272 APPROVAL NO. 591-1255 STRUCTURAL ONLY

> RST#23059-01 05/24/2023

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